


		STREET TREE AND SCREENING PLANTS LIST KEY QUANTITY BOTANICAL NAME COMMON NAME SIZE REMARKS
		10 ACER RUBRUM RED MAPLE 3" TO 3-1/2" C B & B
	LOT 6	10 ACER SACCHARUM SUGAR MAPLE 3" TO 3-1/2" C B & B
		9 QUEROUS PALUSTRIS PIN OAK 2 1/2 TO 3" CAL. B & B THE WRAP THE WRAP
		TURNBUCKLES TURNBUCKLES TURNBUCKLES 4" MULCH TO BE TAPERED TO MEET GROUND AT BASE TO QUERCUS RUBRA NORTHERN RED OAK 3" TO 3-1/2" C B & B TREE WRAP TURNBUCKLES GUY WIRE (3 REQ.) GUYING STAKE
		OF TREE REMOVE BURLAP THUJA PLICATA GREEN GIANT ARBORVITAE 2 1/2" TO 3" C B & B
680		ARBORVITAE SPECIFIED TORSON
		HOLE TO BE 2 ON EXISTING SUB-GRADE HOLE TO BE 2 TIMES WIDTH OF BALL OF TREE HOLE TO BE 2 ON EXISTING SUB-GRADE BALL OF TREE BALL OF TREE
		DECIDUOUS TREES EVERGREEN TREES
		PLANTING & GUYING DETAIL N.T.S.
		SHADE & SCREENING TREE PLANTING SPECIFICATIONS 1. TREES SHALL BE BALLED AND BURLAPPED, HARDY AND SUITABLE TO LOCAL SOIL AND CLIMATE, AND SHALL NOT BE LESS THAN TWO AND A HALF INCHES CALIPER MEASURED SIX INCHES ABOVE THE TOP OF THE BALL NOR LESS THAN 10 FEFT HIGH. THEY MUST BE WELL—BRANCHED, THE BRANCHES TO START NOT LESS THAN SIX FEFT FROM THE CROWN OF THE ROOT SYSTEM. TREES
		SHOULD BE NURSERY GROWN, AND A NURSERY INSPECTION CERTIFICATE SHOULD BE AVAILABLE COVERING ALL TREES. ALL TREES MUST MEET THE STANDARDS OF THE AMERICAN STANDARD FOR NURSERY STOCK. 2. SHADL BE PLANTED ONE FOOT TO FIVE FEET OUTSIDE OF THE RIGHT-OF-WAY LINE, AND APPROXIMATELY 40 FEET APART. TREES SHOULD BE STAGGERED WHEN PLANTED ON
		3. IN GENERAL, EXCAVATIONS FOR PLANTING SHALL BE LARGE ENOUGH TO ACCOMMODATE THE NATURAL SPREAD OF THE ROOT SYSTEM AND AT LEAST TWO TIMES THE WIDTH OF THE BALL OF EARTH SUPPLIED WITH THE TREE. THE PIT SHALL BE ROCK FREE AND REFILLED WITH SEVEN PARTS TOPSOIL AND ONE PART HUMUS AND THE PARENT SOIL DISCARDED. HARDPAN SHALL BE LOOSENED AN ADDITIONAL TWELVE INCHES FROM THE BOTTOM AND SIDE OF PIT. TREES SHALL BE ADEQUATELY FERTILIZED AND WATERED AT THE TIME OF PLANTING AND MULCHED WITH THREE INCHES OF APPROVED MULCH IMMEDIATELY AFTER PLANTING.
		APPROVED MUCH IMMEDIATELY AFTER PLANTING. 4. TREES SHALL BE STAKED AND GUYED IMMEDIATELY AFTER PLANTING. STAKES SHALL BE OF CEDAR OR OAK, EIGHT FEET LONG, NO LESS THAN TWO INCHES IN DIAMETER AND DRIVEN INTO THE TREES ROOT SYSTEM. TREES SHOULD BE GUYED TO THE STAKE USING No. 10 WIRE COVERED WITH RUBBER HOSE OR EQUAL. THE WIRE SHALL BE STAPLED TO THE STAKE IN SUCH A MANNER THAT IT WILL NOT SLIP OR COME INTO CONTACT WITH THE TRUNK OF THE TRUNK OF THE TREE MAY BE PROTECTED WITH TREE WRAPPING PAPER. 5. REMOVAL OF DEBRIS IS REQUIRED. THE PROPERTY MUST BE LEFT IN A NEAT AND ORDERLY CONDITION IN ACCORDANCE WITH GOOD AND ACCEPTED PLANTING AND TREE SURGERY PRACTICES.
		6. ALL TREE VARIETIES, PLACEMENT, CONDITION AND QUALITY ARE SUBJECT TO THE APPROVAL OF THE TOWN PLANNING BOARD PRIOR TO AND AFTER PLANTING. POPLARS, BOX ELDERS, CATALPAS, HORSE CHESTNUTS, WILLOWS AND ELMS SHALL NOT BE PLANTED. 7. CONTRACTOR SHALL VERIFY LOCATIONS OF ALL UNDERGROUND UTILITIES PRIOR TO PLANTING. CONTRACTOR SHALL FIELD ADJUST LOCATION OF SHADE TREES, AS NECESSARY, TO AVOID DAMAGE TO
		ALL EXISTING UNDERGROUND UTILITIES AND/OR EXISTING ABOVE GROUND ELEMENTS. ALL FIELD ADJUSTMENTS MUST MEET THE REGULATIONS SET FORTH IN THE TOWN OF CHESTER SUBDIVISION REGULATIONS, SECTION 83–20B. 8. EXISTING VEGETATION AREAS DISTURBED BY CONSTRUCTION ACTIVITIES SHALL BE TOPSOILED AND SEEDED UPON COMPLETION OF WORK. (SEE PERMANENT SEEDING MIXTURE TABLE ON SHEET 6 OF 9.)
		9. ALL PLANT MATERIAL ON THIS SHEET AND ALL SHEETS ASSOCIATED WITH THIS DRAWING SET MUST MEET THE STANDARDS SET FORTH IN THE LATEST EDITION OF THE AMERICAN NURSERYMAN'S STANDARDS FOR NURSERY STOCK. 10. STREET TREES ARE SHOWN ON THE PLAN. IF EXISTING TREES REMAIN WITHIN 20' OF THE PUBLIC OR PRIVATE ROAD, AND NO GRADING OCCURRED UNDER THE DRIP LINE OF THE CANOPY OF THE TREE, IT MAY BE COUNTED AS A STREET TREE AND A NEWLY PLANTED TREE MAY NOT BE NECESSARY. THE DETERMINATION FOR THE NEED FOR STREET TREES AFTER THE ROAD IS
LOT 8		INSTALLED, SHALL BE THE DISCRETION OF THE TOWN OF CHESTER BUILDING DEPARTMENT OR THEIR CONSULTANT. LANDSCAPE WARRANTY NOTE:
		1. ALL PLANTS SHALL BE WARRANTED FOR A PERIOD OF TWO YEARS. REPLACE, IN ACCORDANCE WITH THE DRAWINGS AND SPECIFICATIONS, ALL PLANTS THAT ARE MISSING, MORE THAN 25% DEAD, DO NOT DEVELOP FROM PLANTING STOCK, APPEAR UNHEALTHY OR UNSIGHTLY AND/OR HAVE LOST THEIR NATURAL SHAPE DUE TO DEAD BRANCHES. ANY TREE THAT LOSES THE MAIN LEADER SHALL BE REPLACED.
		2. PLANT MATERIAL SHALL BE INSPECTED BY A REPRESENTATIVE (OR LANDSCAPE ARCHITECTURAL CONSULTANT) FROM THE TOWN OF CHESTER UPON COMPLETION OF WORK AND DURING EVERY GROWING SEASON FOR TWO YEARS. PLANTS THAT NEED REPLACEMENT SHALL BE NOTED ON AN INSPECTION REPORT AND MUST BE REPLACED WITHIN TWO MONTHS OF RECEIPT OF THE INSPECTION REPORT OR WITHIN TWO MONTHS FOLLOWING THE NEXT GROWING SEASON.
		TEMPORARY MAINTENANCE EASEMENT NOTE: 1. IN ORDER FOR THE TREES TO BE MAINTAINED OR REPLACED BY THE DEVELOPER, A TEN FOOT WIDE TEMPORARY MAINTENANCE EASEMENT SHALL RUN
		PARALLEL TO THE RIGHT-OF-WAY UNTIL RELEASE OF THE MAINTENANCE SECURITY FOR THE TREES. PLANTING SCHEDULE: 1. EACH ZONE CONSISTS OF FOUR SPECIES TO BE PLANTED USING EITHER
LOT 9		1-7/8" PLUGS AND/OR SEED. 1-7/8" PLUGS AND/OR SEED. 2. THE PLUGS FOR EACH ZONE SHALL BE RANDOMLY MIXED AND PONTEDERIA CORDATA, PICKELWEED 1-7/8" PLUGS AND/OR SEED. 2. THE PLUGS FOR EACH ZONE SHALL BE RANDOMLY MIXED AND PLANTED WITH AN APPROXIMATE SPACING OF 2'-6" ON CENTER. THE OF PUBLIC WORKS NOTE:
		TYPHA SPP., CATTAIL TYPHA SPP., CATTAIL TYPHA SPP., CATTAIL THE UPPER ZONE SHALL BE PLANTED WITH A MINIMUM OF 100 PLUGS. VALLISMERA AMERICANA, WILD CELERY THE SEEDING FOR EACH ZONE SHALL CONSIST OF EQUAL PARTS PER VALUE HIGHWAY WORK PERMIT HAS BEEN SECURED.
		MIDDLE ZONE (NYS DEC ZONES 3 & 4): CAREX LACUSTRIS, LAKEBANK SEDGE SPECIES AND BROADCAST OVER IT'S RESPECTIVE AREA AT A RATE OF 1 POUND PER 2,000 SQ.FT. AN OVERLAP OF SPECIES FROM ONE ZONE TO THE NEXT WILL NOT EXCEED 3'-6', ALLOWING FOR INTERGRATION BETWEEN THE INDIVIDUAL
		SCIRPUS CYPERNUS, WOOL GRASS SCIRPUS VALIDUS, SOFT—STEM BULRUSH 5. NORTHEAST WETLAND DIVERSITY MIX SHALL BE BROADCAST OVER BASIN ZONES 3, 4, 5 & 6 AT A RATE OF 2 POUNDS PER ACRE INTERMIXED WITH PLUGS AND/OR SEEDING SPECIFIED ABOVE, AS MANUFACTURED BY: O1-21-16 REVISIONS AS PER 9/2 COMMENT LETTER NR O8-17-15 REVISIONS AS PER 0.C.D.P.W. LETTER NR MANUFACTURED BY:
		DESCHAPSIA CAESPITOSA. TUFTED HAIRGRASS DESCHAPSIA CAESPITOSA. TUFTED HAIRGRASS SOUTHERN TIER CONSULTING, INC. 11–15–14 REVISIONS AS PER 12/2 COMMENT LETTER NR 11–18–14 REVISIONS AS PER 10/9 COMMENT LETTER NR JUNCUS EFFUSUS, SOFT RUSH 140.01.14 DESCEN PREPARATION DATE.
	LOT'3	WEST CLARKSVILLE, NY 14786 PANICUM VIRGATUM, SWITCH GRASS WEST CLARKSVILLE, NY 14786 10-01-14 DESIGN PREPARATION DATE NR 12-05-13 CLUSTER SKETCH PLAN PREPARATION DATE JJP DATE DESCRIPTION INITIALS
LOT 10		PLANTS LIST (NOT FOR OCHD REVIEW OR APPROVAL)
	1 1 1 1 1 1 1 1 1 1 1 1 1 1 1 1 1 1 1	+ 5 ACER RUBRUM RED MAPLE 3" TO 3-1/2" C PROPOSED CONVENTIONAL SDS SYSTEM PROPOSED ELJEN SDS SYSTEM PROPOSED ELJEN SDS SYSTEM PROPOSED ELJEN SDS SYSTEM
	The state of the s	PROPOSED PROPERTY LINE PROPOSED MAJOR CONTOUR PROPOSED MAJOR CONTOUR ENGINEERING & SURVEYING, PLLC 262 GREENVICH AVENUE, SUITE A 2 HAVILTON AVENUE
	TOT 3	PROPOSED MINOR CONTOUR SHADBLOW SERVICEBERRY 18"-24" PROPOSED MINOR CONTOUR EXISTING MAJOR CONTOUR (845) 294-0606 (845) 796-4646
		9 ARROWOOD CIBURNUM VIBURNUM DENTATUM 18"-24" EXISTING PROPERTY LINE EXISTING TREFLINE OVERAGE TO SET UNE OVERAGE TO SET U
		10 CLETHRA ALNIFOLIA SUMMERSWEET 18"-24" NOTES: 1. WOODY VEGETATION MAY NOT BE PLANTED OR ALLOWED TO GROW WITHIN 15 FEET OF THE TOE PASS DEEMS NO. 076936 PASS DEEMS NO. 050075 PASS DEEMS NO. 05007
2 16.22 2 16.22 2 2 2 2 2 2 2 2 2 2 2 2 2 2 2 2 2 2		OF THE EMBANKMENT AND 25 FEET FROM THE PRINCIPAL SPILLWAY STRUCTURE. 2. SOIL TESTING IN EACH DETENTION POND AREA IS TO BE CONDUCTED AT THE TIME OF POND CONSTRUCTION. IF THIS TESTING REVEALS THAT SIGNIFICANT INFILTRATION WILL OCCUR, THE PROPOSED POND IS TO BE CONSTRUCTED WITH A 6 TO 12 INCH NON-PERMEABLE CLAY LAYER (OR APPROVED EQUAL). THIS LAYER IS TO BE COMPACTED AND HARDENED TO EASE MAINTENANCE OHW EXISTING OVERHEAD UTILITIES EXISTING OVERHEAD UTILITIES OHW EXISTING OVERHEAD UTILITIES OHW EXISTING OVERHEAD UTILITIES DATE WOURDE CLUSTER
		(OR APPROVED EQUAL). THIS LAYER IS TO BE COMPACTED AND HARDENED TO EASE MAINTENANCE AND CLEANING OF FOREBAY AND WET POND. 3. A 6 INCH LAYER OF TOPSOIL IS TO BE SPREAD EVENLY FROM THE TOP OF THE POND TO 2 FEET BELOW THE PERMANENT WATER ELEVATION TO BETTER PROMOTE VEGETATION ESTABLISHMENT. EXISTING UTILITY POLE WITH OVERHEAD WIRES EXISTING SIGN SUBDIVISION
	LOT 1	O.C.D.P.W. LANDSCAPING NOTES: 1. NO PLANTINGS (SHRUBS/TREES) OR LANDSCAPING FEATURES (GATES, FENCES, STONE PILLARS, RESERVED FOR TOWN PLANNING BOARD APPROVAL TOWN OF CHESTER COUNTY OF ORANGE, NEW YORK
		STONE WALLS, SIGNS, ETC.) SHALL BE PLACED WITHIN THE COUNTY RIGHT OF WAY. 2. ALL DISTURBED AREAS ARE TO BE GRADED, SEEDED, AND STRAWED ON A DAILY BASIS. I AND SCADING DIAM
***************************************	EDGE OF PAVEMENT WHITE LINE	GRAPHIC SCALE LANDSCAPING PLAN SECTION 8 BLOCK 1 LOT 50.2
LAROE ROAD (COUNTY ROUTE 45) GAS GAS GAS GAS GAS GAS GAS GA	GAS	DRAWING TITLE 50 0 25 50 100 200 UNAUTHORIZED ALTERATION OR ADDITION TO A PLAN BEARING A LICENSED LAND SURVEYOR'S OR PROFESSIONAL ENGINEER'S SEAL IS A VIOLATION OF SECTION 7209, SUB-DIVISION 2 OF THE N.Y. STATE EDUCATION LAW.
LAROE RUAD GAS	CHWY CHWY GAS GAS GAS GAS GAS	(IN FEET) 1 inch = 50 ft. (IN FEET NO. D.E.C. SHEET NO. DRAWING NUMBER N/A OF N/
OHW OHW OHW	h/1 (175/10)	1" = 50' 14102 ENG BASE 14102.01

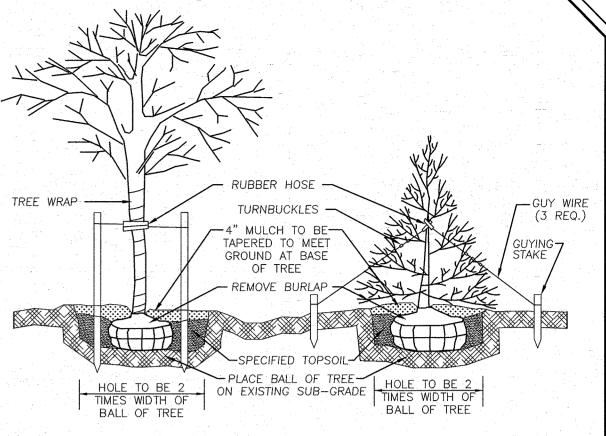

PLANTING & GUYING DETAIL


- CLIMATE, AND SHALL NOT BE LESS THAN TWO AND A HALF INCHES CALIPER MEASURED SIX INCHES ABOVE HED, THE BRANCHES TO START NOT LESS THAN SIX FEET FROM THE CROWN OF THE ROOT SYSTEM. TREES VAILABLE COVERING ALL TREES. ALL TREES MUST MEET THE STANDARDS OF THE AMERICAN STANDARD FOR
- -WAY LINE, AND APPROXIMATELY 40 FEET APART. TREES SHOULD BE STAGGERED WHEN PLANTED ON THE NATURAL SPREAD OF THE ROOT SYSTEM AND AT LEAST TWO TIMES THE WIDTH OF THE BALL OF EARTH
- ADEQUATELY FERTILIZED AND WATERED AT THE TIME OF PLANTING AND MULCHED WITH THREE INCHES OF E OF CEDAR OR OAK, EIGHT FEET LONG, NO LESS THAN TWO INCHES IN DIAMETER AND DRIVEN INTO THE OVERED WITH RUBBER HOSE OR EQUAL. THE WIRE SHALL BE STAPLED TO THE STAKE IN SUCH A MANNER OF THE TREE MAY BE PROTECTED WITH TREE WRAPPING PAPER.
- DERLY CONDITION IN ACCORDANCE WITH GOOD AND ACCEPTED PLANTING AND TREE SURGERY PRACTICES. OVAL OF THE TOWN PLANNING BOARD PRIOR TO AND AFTER PLANTING. POPLARS, BOX ELDERS, CATALPAS,
- NTING, CONTRACTOR SHALL FIELD ADJUST LOCATION OF SHADE TREES, AS NECESSARY, TO AVOID DAMAGE TO
- ALL FIELD ADJUSTMENTS MUST MEET THE REGULATIONS SET FORTH IN THE TOWN OF CHESTER SUBDIVISION
- ILED AND SEEDED UPON COMPLETION OF WORK. (SEE PERMANENT SEEDING MIXTURE TABLE ON SHEET 6 SET MUST MEET THE STANDARDS SET FORTH IN THE LATEST EDITION OF THE AMERICAN NURSERYMAN'S
- THE PUBLIC OR PRIVATE ROAD, AND NO GRADING OCCURRED UNDER THE DRIP LINE OF THE CANOPY OF NOT BE NECESSARY. THE DETERMINATION FOR THE NEED FOR STREET TREES AFTER THE ROAD IS INT OR THEIR CONSULTANT.
- DANCE WITH THE DRAWINGS AND SPECIFICATIONS, ALL PLANTS THAT AR UNHEALTHY OR UNSIGHTLY AND/OR HAVE LOST THEIR NATURAL REPLACED.
- CTURAL CONSULTANT) FROM THE TOWN OF CHESTER UPON THAT NEED REPLACEMENT SHALL BE NOTED ON AN INSPECTION REPORT OR WITHIN TWO MONTHS FOLLOWING THE NEXT GROWING


S OF FOUR SPECIES TO BE PLANTED USING EITHER

- OR SEED. ZONE SHALL BE RANDOMLY MIXED AND PPROXIMATE SPACING OF 2'-6" ON CENTER. THE BE PLANTED WITH A MINIMUM OF 50 PLUGS, THE BE PLANTED WITH A MINIMUM OF 75 PLUGS AND ALL BE PLANTED WITH A MINIMUM OF 100 PLUGS. CH ZONE SHALL CONSIST OF EQUAL PARTS PER CAST OVER IT'S RESPECTIVE AREA AT A RATE OF
- CIES FROM ONE ZONE TO THE NEXT WILL NOT WING FOR INTERGRATION BETWEEN THE INDIVIDUAL
- DIVERSITY MIX SHALL BE BROADCAST OVER & 6 AT A RATE OF 2 POUNDS PER ACRE

E, NY 14786

ORANGE COUNTY DEPARTMENT

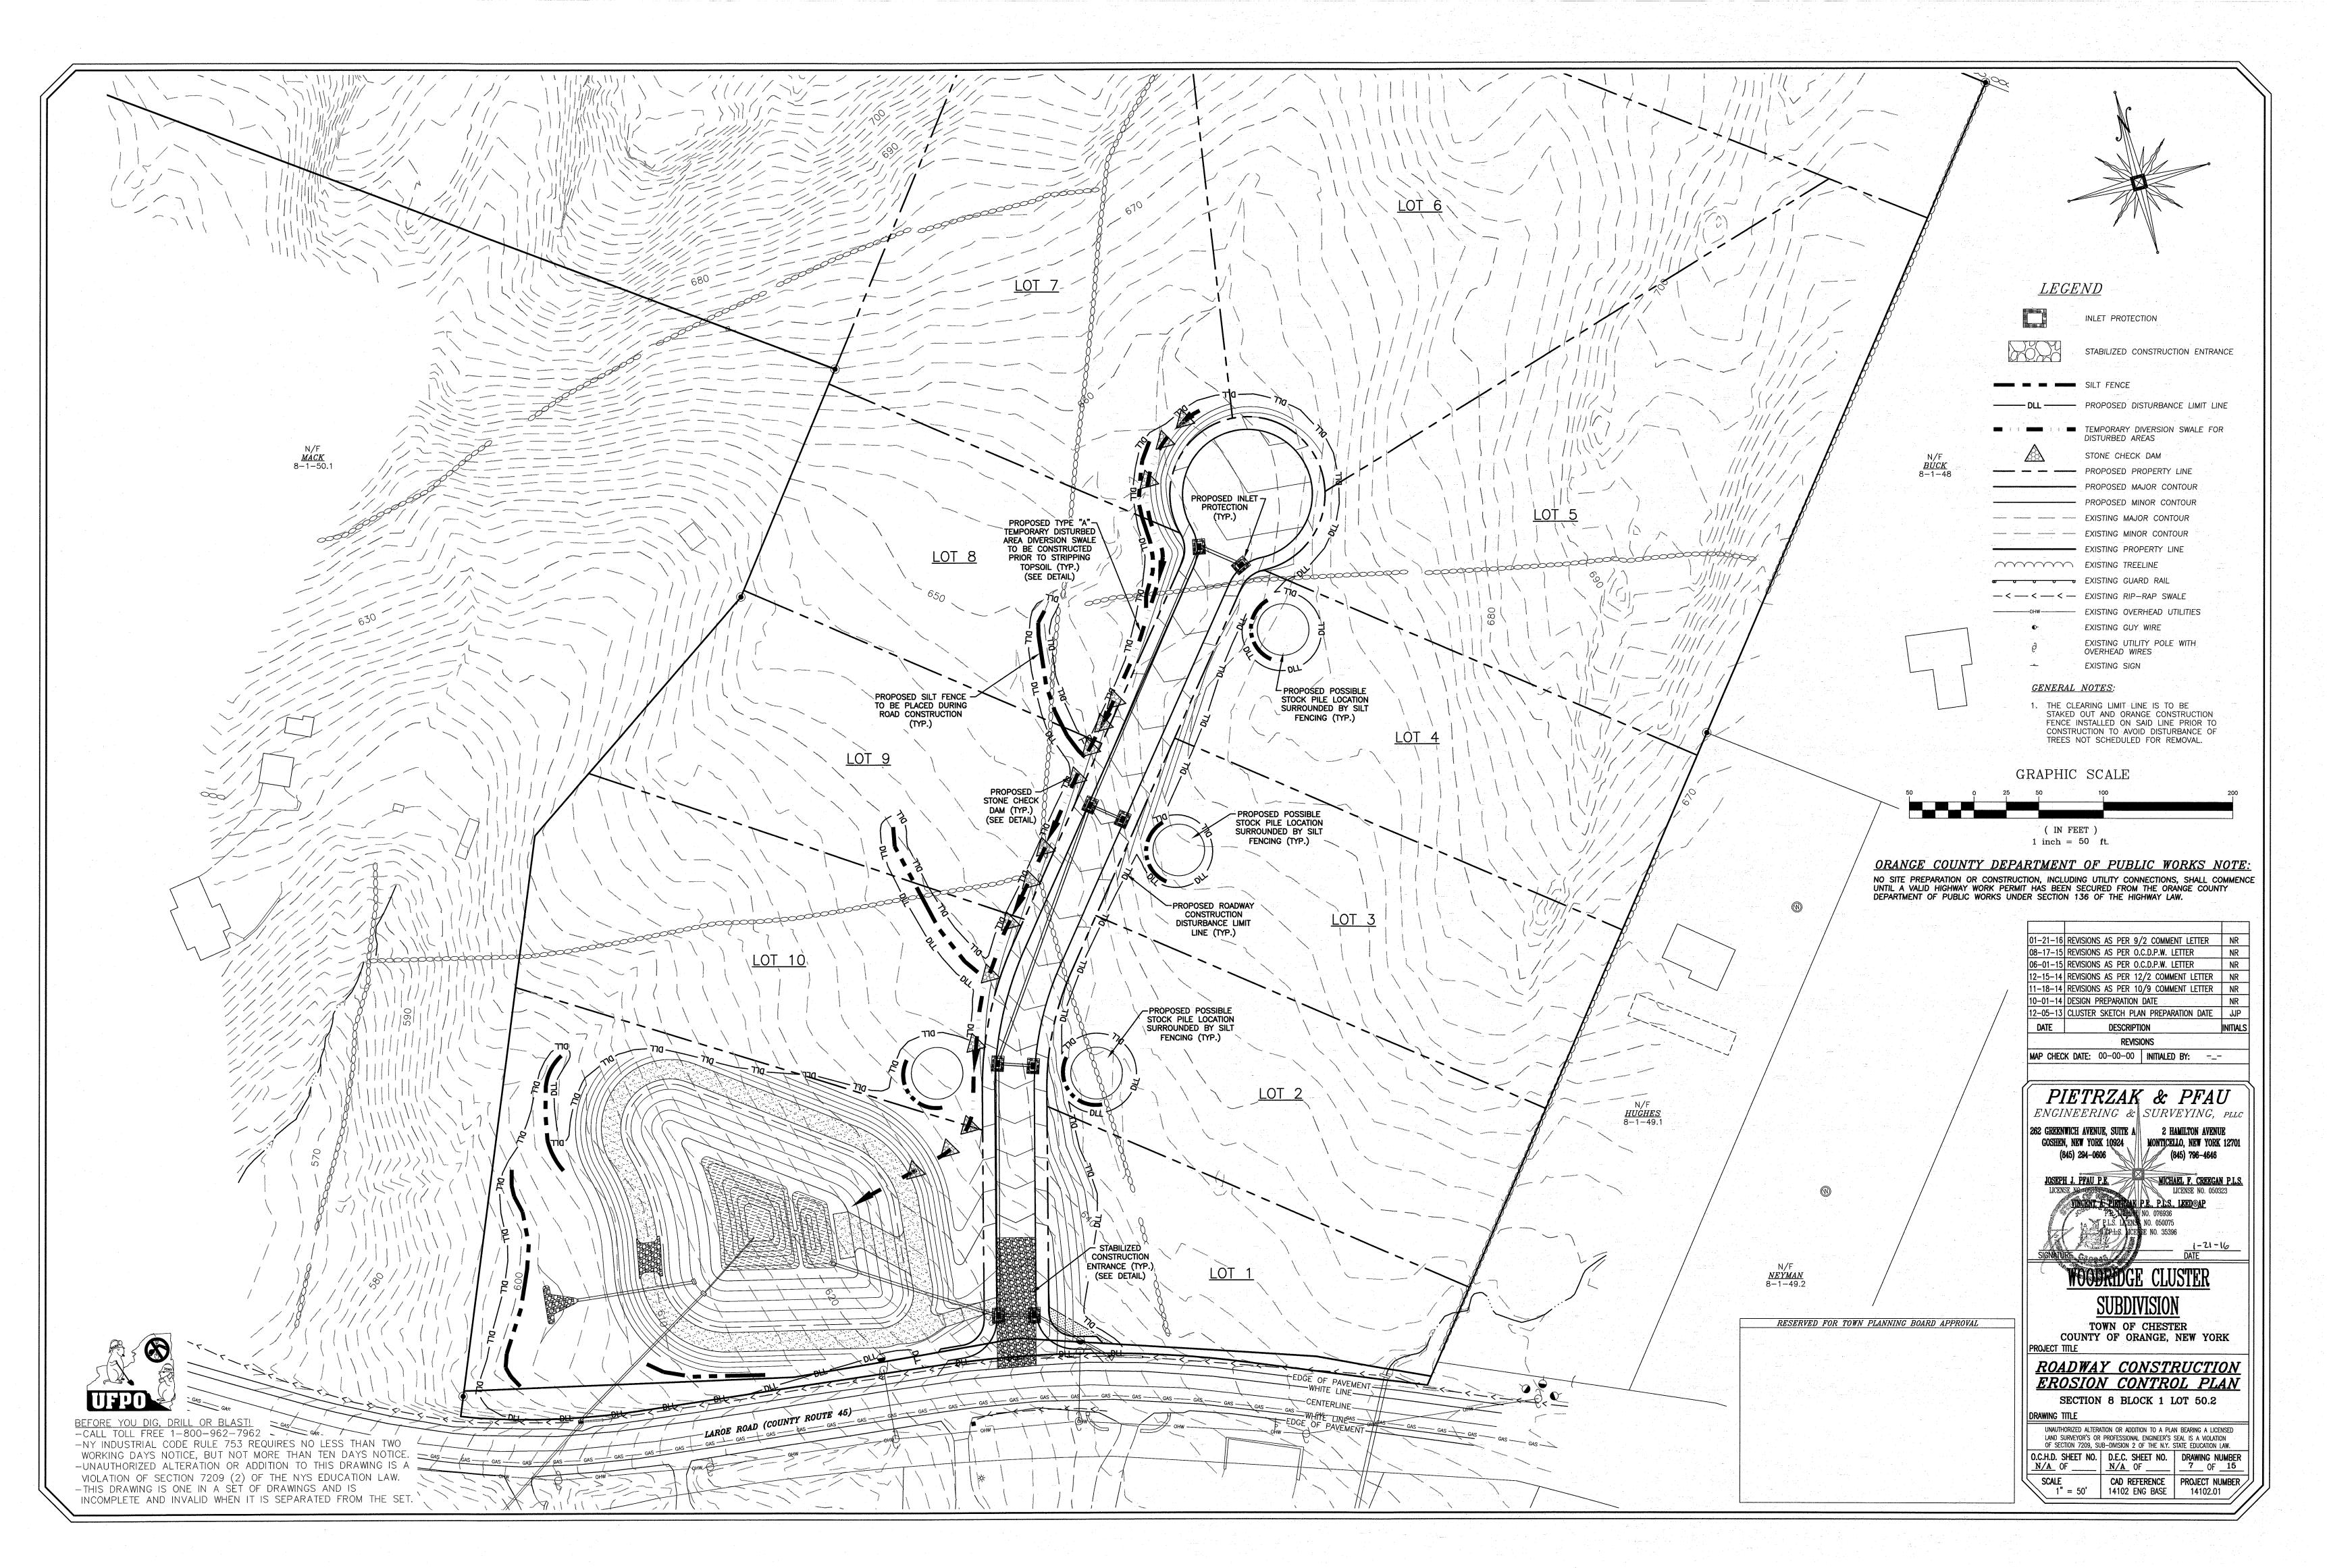

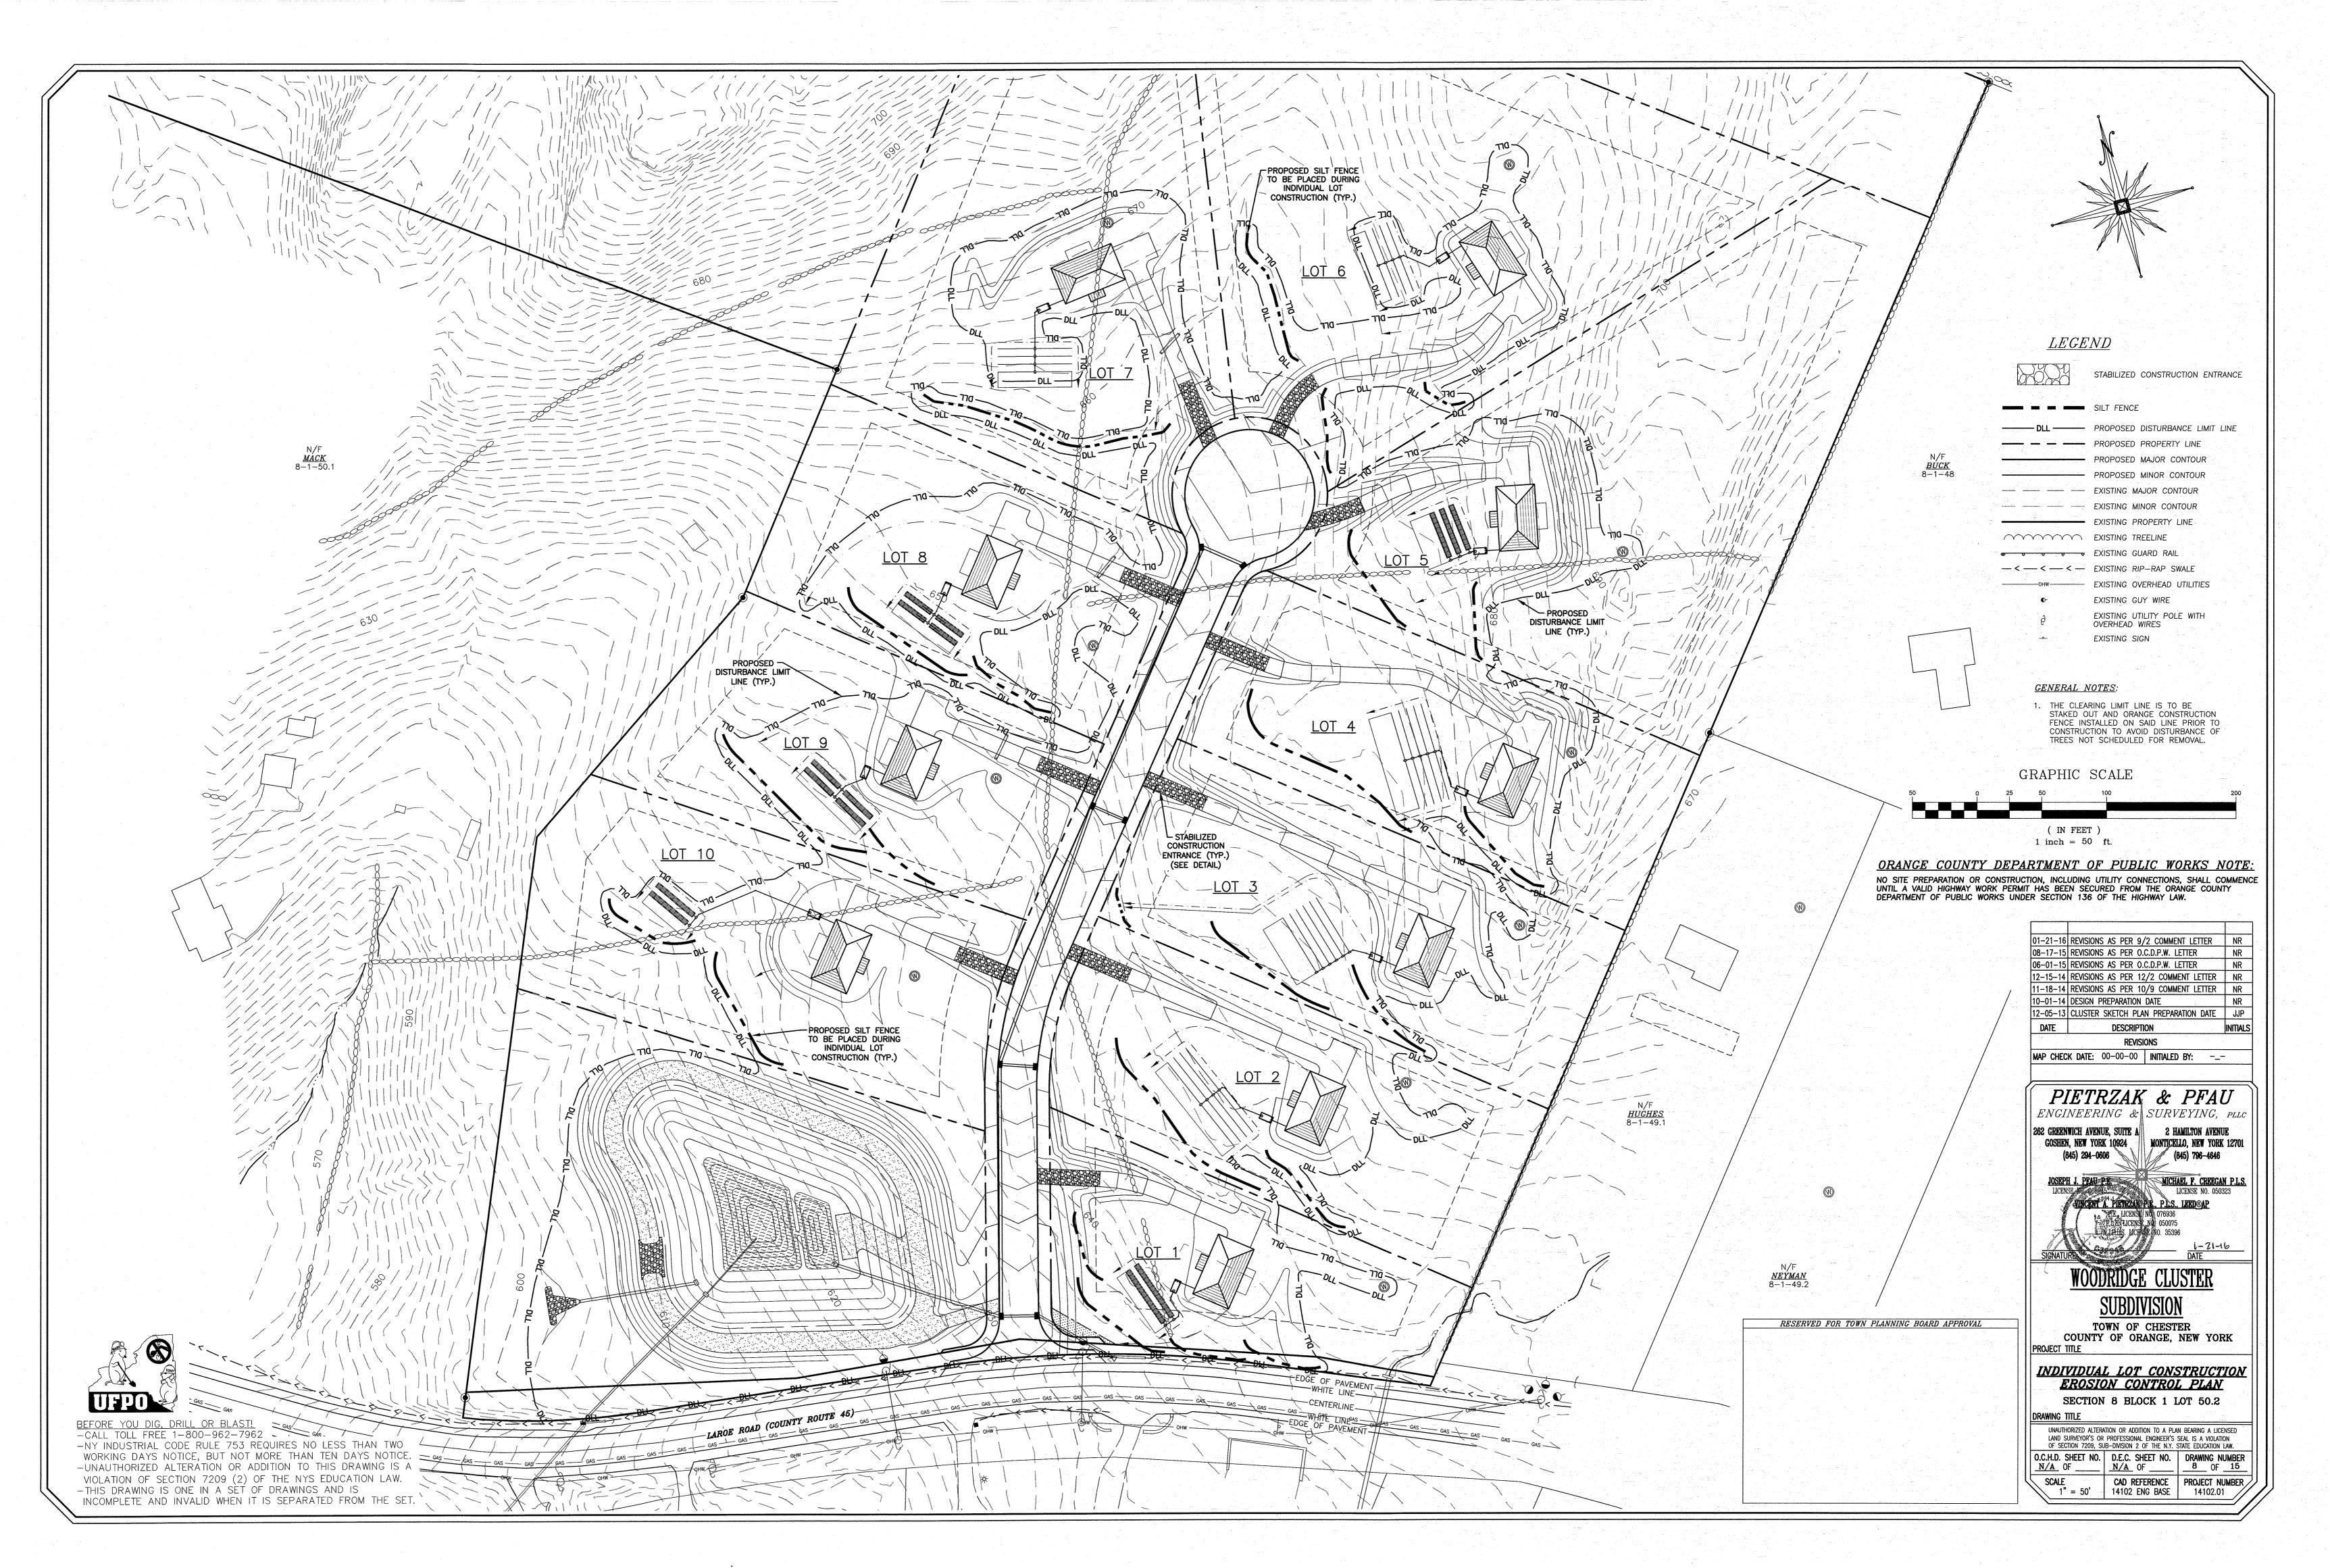



<u>EROSION CONTROL SEQUENCE</u>

- MEASURES SHALL BE TAKEN TO PREVENT SOIL EROSION DURING PROJECT CONSTRUCTION, ALL FRESHLY DISTURBED AREAS THAT WILL REMAIN DISTURBED FOR MORE THAN A PERIOD OF FOURTEEN (14) DAYS SHALL BE STABILIZED BY TEMPORARY SEEDING AS INDICATED ON THE TEMPORARY SEEDING SCHEDULE. DISTURBED AREAS SHALL BE MINIMAL IN SIZE AND SHALL NOT EXCEED THE APPROVED CLEARING AND GRADING LIMITS. THE FOLLOWING MEASURES SHALL BE IMPLEMENTED AS CONSTRUCTION PROGRESSES.
- A. PRIOR TO COMMENCING CONSTRUCTION ACTIVITIES, THE LIMITS OF CLEARING AND GRADING SHALL BE MARKED. FILTER FABRIC SEDIMENTATION BARRIERS (SILT FENCE) SHALL BE PLACED ALONG THE DOWNGRADE PERIMETER OF THE SITE AND ANY OTHER AREAS WHERE SILT FENCE IS INDICATED AS TO BE INSTALLED "PRIOR TO CONSTRUCTION" ON THE APPROVED PLANS. INSTALLATION IS TO BEGIN AT THE DOWNSTREAM PORTIONS OF THE
- B. STABILIZED CONSTRUCTION ENTRANCES SHALL BE BUILT IN THE AREAS SHOWN ON THE APPROVED PLANS AND WHEREVER A CONSTRUCTION ACCESS ROAD INTERSECTS ANY PUBLIC THROUGHFARE. STABILIZED ENTRANCES SHALL BE BUILT IN ACCORDANCE WITH THE STABILIZED CONSTRUCTION ENTRANCE DETAIL.
- C. UPON COMPLETION OF CLEARING AND GRUBBING ACTIVITIES, TOPSOIL SHALL BE STRIPPED AND STOCKPILED FROM ALL AREAS TO BE DISTURBED. STOCKPILED TOPSOIL SHALL BE STABILIZED BY TEMPORARY SEEDING AND SURROUNDED WITH A PERIMETER SILT FENCE.
- D. TEMPORARY EROSION CONTROL DEVICES SHALL BE INSTALLED PRIOR TO COMMENCING EARTH MOVING ACTIVITIES. THIS INCLUDES SEDIMENTATION TRAPS, TYPE "B" DIVERSION SWALES (WITH CHECK DAMS IF APPLICABLE) AND SILT FENCE IN AREAS NOT DESIGNATED TO BE GRADED. INSTALLATION SHALL BEGIN AT DOWNSTREAM PORTIONS OF THE SITE THEN WORKING UPSTREAM. INFILTRATION AND FILTERING PRACTICES, SUCH AS SAND FILTERS AND BIORETENTION PONDS SHALL NOT HAVE INFILTRATION AND FILTER MEDIA INSTALLED UNTILL ALL TRIBUTARY AREAS HAVE BEEN SUBSTANTIALLY STABILIZED.
- E. IMMEDIATELY AFTER COMPLETION OF ROUGH GRADING, REMAINING TEMPORARY EROSION CONTROL SHALL BE INSTALLED AS SPECIFIED ON THE APPROVED PLANS. THIS INCLUDES ANY REMAINING SILT FENCE AND TYPE "A" DIVERSION SWALES (WITH CHECK DAMS IF APPLICABLE). AREAS NOT REQUIRING FURTHER EARTHWORK SHALL BE FINE GRADED, TOPSOILED, AND STABILIZED AS EARLY AS POSSIBLE.
- F. ANY PROPOSED STORM DRAINAGE SHALL BE INSTALLED AND INCORPORATED INTO EROSION CONTROL AS SPECIFIED ON THE APPROVED PLANS. STORM DRAINAGE COMPONENTS SHALL BE PROTECTED FROM SILTATION AS
- G. UPON COMPLETION OF CONSTRUCTION ACTIVITES, REMAINING AREAS SHALL BE FINE GRADED, TOPSOILED, AND STABILIZED. PERMANENT VEGETATION AND LANDSCAPING SHALL BE ESTABILISHED
- H. TEMPORARY EROSION CONTROL DEVICES SHALL BE REMOVED ONCE UPSTREAM AREAS HAVE BEEN PERMANENTLY STABILIZED. REMOVAL OF TEMPORARY EROSION CONTROL DEVICES SHALL BEGIN WITH THE MOST UPSTREAM PORTIONS OF THE SITE THEN WORKING DOWNSTREAM.
- I. ALL NEWLY SEEDED VEGETATIVE COVER SHALL BE MAINTAINED. WASHOUTS OR POORLY GROWING AREAS SHALL BE CORRECTED AS THEY OCCUR.

GENERAL EROSION CONTROL NOTES

- FILTER FABRIC IS TO BE MIRAFI 140 AS MANUFACTURED BY THE CELANESE CORPORATION OR APPROVED EQUAL WHEREVER FEASIBLE, NATURAL VEGETATION SHOULD BE RETAINED AND PROTECTED. ONLY THE SMALLEST PRACTICAL AREA OF LAND SHOULD BE EXPOSED AT ANY ONE TIME DURING DEVELOPMENT. WHEN LAND IS EXPOSED DURING DEVELOPMENT, THE EXPOSURE SHALL BE KEPT TO THE SHORTEST PRACTICAL
- PERIOD OF TIME. 5. ALL WORK SHALL BE IN ACCORDANCE WITH ALL OF THE ATTACHED DRAWINGS.

MAINTENANCE REQUIREMENTS

- 1. THE MAINTENANCE OF EROSION CONTROL DEVICES WILL BE THE RESPONSIBILITY OF THE CONTRACTOR. THE JOB SUPERINTENDENT WILL MONITOR THE CONDITION OF ALL THE DEVICES, CLEAN AND REPLACE STRUCTURES AS CLIMATIC CONDITIONS REQUIRE, THE DEVELOPER WILL ALSO BE SUBJECT TO THE DIRECTIVE OF THE DESIGN ENGINEER AND TOWN REPRESENTATIVES TO INCLUDE TOWN ENGINEER, HIGHWAY SUPERINTENDENT AND BUILDING
- 2. GENERAL CONTRACTOR AND ALL CONTRACTORS SHALL PERFORM ALL WORK IN ACCORDANCE WITH THE APPROVED PLANS AND MAY BE SUBJECT TO ADDITIONAL EROSION CONTROL REQUIREMENTS AS CONDITIONS MAY ARISE IN THE FIELD OR AS DIRECTED BY THE DESIGN ENGINEER 3. THE CONTRACTOR SHALL MAINTAIN ALL EROSION CONTROL DEVICES IN ACCORDANCE WITH THE APPROVED PLANS.
- MANUFACTURER'S RECOMMENDATIONS, AS DIRECTED BY THE DESIGN ENGINEER AND TOWN REPRESENTATIVES INCLUDING TOWN ENGINEER, HIGHWAY SUPERINTENDENT AND BUILDING INSPECTOR. 4. NO EROSION CONTROL STRUCTURES SHALL BE REMOVED UNTIL ALL WORK UPSTREAM THEREFROM HAS BEEN COMPLETED, INCLUDING STABILIZATION AND APPROVED BY THE DESIGN ENGINEER AND TOWN REPRESENTATIVES.
- CONSTRUCTION ACTIVITIES TO BE LIMITED TO THE PERIOD OF 7:00 AM TO 7:00 PM. . ALL CONSTRUCTION EQUIPMENT SHALL HAVE PROPERLY SIZED MAINTAINED MUFFLERS.
- 7. ALL CONSTRUCTION EQUIPMENT SHALL BE TURNED OFF WHEN NOT IN USE.

<u>SLOPE STABILIZATION, SEEDING METHOD & MULCHING</u>

- SLOPES SHALL BE HYDROSEEDED WITH THE MIXTURES AND RATES INDICATED IN THE PERMANENT SEEDING MIXTURE SCHEDULE. STRAW OR HAY MULCH SHALL BE APPLIED AT A RATE OF 2000 LBS/ACRE. STRAW OR HAY MULCH SHALL BE ANCHORED WITH BIOD-Mesh60 NETTING AS MANUFACTURED BY ROLANKA INTERNATIONAL OR APPROVED EQUIVALENT. NETTING TO BE INSTALLED PER MANUFACTURER SPECIFICATIONS
- GENTLE SLOPES AND FLAT AREAS

 AREAS SHALL BE SEEDED BY HYDROSEEDING OR BROADCASTING WITH THE MIXTURES AND RATES INDICATED ON THE PERMANENT SEEDING MIXTURE AND RATES INDICATED ON THE PERMANENT SEEDING MIXTURE SCHEDULE. HYDROSEEDED AREAS SHALL BE MULCHED WITH A WOOD FIBER MULCH APPLIED AT A RATE OF 500 LBS/ACRES. BROADCAST AREAS SHALL BE MULCHED WITH HAY OR STRAW AT A RATE OF 2000 LBS/ACRE. AREAS SEEDED BY BROADCASTING SHALL BE LIGHTLY RAKED AND PACKED PRIOR TO PLACING MULCH.

STREAMS, DRAINAGE SWALES AND EMBANKMENTS

- 1. ALL CONSTRUCTION ACTIVITIES IN OR EXISTING AROUND DRAINAGE SWALES OR WETLANDS ARE TO BE PROVIDED WITH TEMPORARY EROSIION CONTROL STRUCTURES AS SHOWN IN DETAIL, LOCATED IMMEDIATELY DOWNSTREAM FROM SUCH ACTIVITY. THESE STRUCTURES ARE TO BE IN PLACE AS SHOWN PRIOR TO THE START OF ANY UPSTREAM CONSTRUCTION ACTIVITY.
- CONSTRUCTION EQUIPMENT SHALL NOT UNNECESSARILY CROSS LIVE STREAMS OR DRAINAGE SWALES EXCEPT BY MEANS OF BRIDGES AND CULVERTS OR OTHER APPROVED METHODS. ALL EMBANKMENTS TO BE GRADED AND SEEDED IMMEDIATELY UPON BEING LAID BACK.
- STABILIZATION OF THE SWALES WILL INCLUDE SEEDING AND STRAW MULCH ON SLOPES LESS THAN 5% AND JUTE NETTING OR EQUAL ON SLOPES EXCEEDING 5%.
- TOPSOIL AND/OR EARTH STOCKPILE SHALL BE LOCATED OUTSIDE OF EXISTING DRAINAGE SWALES, WETLANDS AND ADJACENT AREAS. SILT FENCE WILL BE PLACED ALONG THE TOE OF THE PILES AND PILES SHALL RECEIVE

SOIL RESTORATION NOTE:

TO INCREASE INFILTRATION OF STORM WATER AND IMPROVE DIRECT GROUNDWATER RECHARGE FROM RAIN EVENTS, SOIL RESTORATION PRACTICES, AS OUTLINED IN CHAPTER 5.1.6 OF THE NEW YORK STATE STORMWATER MANAGEMENT DESIGN MANUAL, SHOULD BE APPLIED TO THE SITE. AERATION AND DEEP RIPPING PROCEDURES SHALL BE AS DESCRIBED IN APPENDIX 8 OF SWPPP, AND SHALL BE APPLIED TO ALL FLAT TO MODERATELY SLOPED AREAS OF SOIL DISTURBANCE WHICH ARE PROPOSED TO REMAIN PERVIOUS.

SEEDBED PREPARATION & AMENDMENTS

MODERATE TO STEEP SLOPES AND LOW MAINTENANCE AREAS


- -SCARIFY SOIL TO DEPTH OF 4" TO 6" IF COMPACTED. -REMOVED LARGE STONES AND STUMPS ALLOWING ROCKS, ROOTS
- CLODS AND OTHER NATURAL DEBRIS TO REMAIN.
- -ROUGHEN SLOPE FACES BY MAKING GROVES 2"-3" DEEP, PERPENDICULAR TO THE SLOPE WITH DISK OR YORK RAKE. -LIME AS REQUIRED TO ACHIEVE A pH OF 6.0.
- -FERTILIZE AT A RATE OF 600 LBS/ACRE OF 5-10-10 FERTILIZER OR
- AS RECOMMENDED BY SOIL TESTS. -INCORPORATE LIME AND FERTILIZER INTO TOP 4" OF SOIL BY ROUGHENING.

GENERAL RECREATION AREAS AND LAWNS

- -PLACE TOPSOIL TO A MINIMUM DEPTH OF 4" -SCARIFY SOIL TO A DEPTH OF 4"-6" IF COMPACTED
- -REMOVE ALL STONES OVER 1" IN DIAMETER, STICKS AND FOREIGN MATTER FROM THE SURFACE.
- -LIME AS REQUIRED TO ACHIEVE A pH OF 6.5. -FERTILIZE AT A RATE OF 850 LBS/ACRE OF 5-10-10 OR EQUIVALENT FERTILIZER OR AS RECOMMENDED BY SOIL TESTS.
- -INCORPORATE LIME AND FERTILIZER INTO TOP 2"-4" OF TOPSOIL. -SMOOTH AND FIRM THE SEEDBED.

TEMPORARY SEEDING SPECIFICATIONS

- -SCARIFY SOILS IF COMPACTED -LIME TO pH OF 6.0 IF REQUIRED
- -FERTILIZE WITH 600 LBS/ACRE 5-10-10 FERTILIZER IF REQ.. -SEED WITH SPECIES AND RATE SHOWN BELOW -MUICH WITH HAY OR STRAW AT A RATE OF 2000 LBS/ACRE. ANCHOR MULCH WITH NETTING OF WOOD FIBER OR JUTE IF
- STEEP SLOPE OR HIGH POTENTIAL FOR EROSION. RYEGRASS (ANNUAL OR PERENNIAL)
- APPLICATION RATE 30 LBS/ACRE (USE WINTER RYE IF SEEDING IN OCT./NOV.) (0.7 LBS/1000 SF)

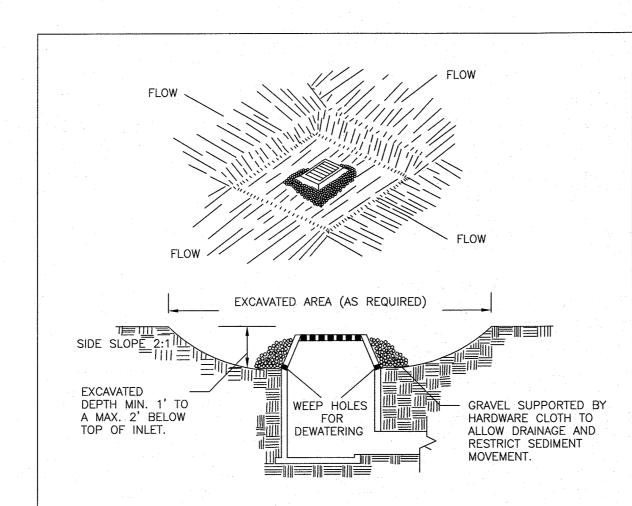


CONSTRUCTION SPECIFICATIONS

- 1. CLEAR THE AREA OF ALL DEBRIS THAT WILL HINDER EXCAVATION. 2. GRADE APPROACH TO THE INLET UNIFORMLY AROUND THE BASIN.
- 3. WEEP HOLES SHALL BE PROTECTED BY GRAVEL.
- 4. UPON STABILIZATION OF CONTRIBUTING DRAINAGE AREA, SEAL WEEP HOLES, FILL BASIN WITH STABLE SOIL TO FINAL GRADE, COMPACT IT PROPERLY AND STABILIZE WITH PERMANENT SEEDING.
- MAXIMUM DRAINAGE AREA 1 ACRE

U.S. DEPARTMENT OF AGRICULTURE NATURAL RESOURCES CONSERVATION SERVICE NEW YORK STATE DEPARTMENT OF ENVIRONMENTAL CONSERVATION NEW YORK STATE SOIL & WATER CONSERVATION COMMITTEE

EXCAVATED DROP INLET PROTECTION

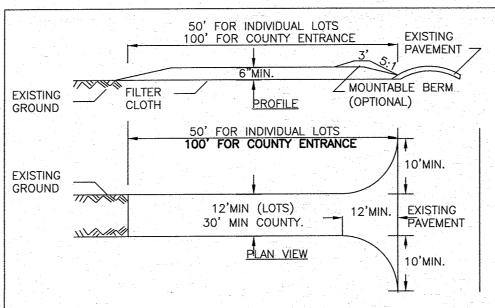


CONSTRUCTION SPECIFICATIONS

- STONE SIZE USE 2" STONE, OR RECLAIMED OR RECYCLED CONCRETE EQUIVALENT.
- 2. LENGTH NOT LESS THAN 50 FEET (EXCEPT ON A SINGLE RESIDENCE LOT WHERE A 30 FOOT MINIMUM LENGTH WOULD APPLY).
- 3. THICKNESS NOT LESS THAN SIX (6) INCHES. 4. WIDTH - TWELVE (12) FOOT MINIMUM, BUT NOT LESS THAN THE FULL WIDTH AT
- POINTS WHERE INGRESS OR EGRESS OCCURS. TWENTY-FOUR (24) FOOT IF SINGLE
- 5. FILTER CLOTH WILL BE PLACED OVER THE ENTIRE AREA PRIOR TO PLACING
- SURFACE WATER ALL SURFACE WATER FLOWING OR DIVERTED TOWARD CON-STRUCTION ENTRANCES SHALL BE PIPED ACROSS THE ENTRANCE. IF PIPING IS
- IMPRACTICAL, A MOUNTABLE BERM WITH 5:1 SLOPES WILL BE PERMITTED. MAINTENANCE - THE ENTRANCE SHALL BE MAINTAINED IN A CONDITION WHICH WILL PREVENT TRACKING OR FLOWING OF SEDIMENT ONTO PUBLIC RIGHTS-OF-WAY, ALL SEDIMENT SPILLED, DROPPED, WASHED OR TRACTED ONTO PUBLIC RIGHTS-OF-WAY MUST BE REMOVED IMMEDIATELY.
- 8. WHEN WASHING IS REQUIRED, IT SHALL BE DONE ON A AREA STABILIZED WITH STONE AND WHICH DRAINS INTO AN APPROVED SEDIMENT TRAPPING DEVICE.
- 9. PERIODIC INSPECTION AND NEEDED MAINTENANCE SHALL BE PROVIDED AFTER EACH

STABILIZED U.S. DEPARTMENT OF AGRICULTURE NATURAL RESOURCES CONSERVATION SERVICE NEW YORK STATE DEPARTMENT OF ENVIRONMENTAL CONSERVATION NEW YORK STATE SOIL & WATER CONSERVATION COMMITTEE

CONSTRUCTION ENTRANCE

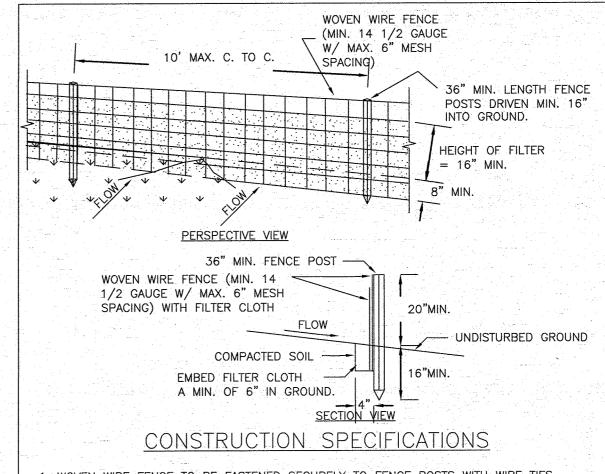


- . WOVEN WIRE FENCE TO BE FASTENED SECURELY TO FENCE POSTS WITH WIRE TIES OR STAPLES, POSTS SHALL BE STEEL EITHER "T" OR "U" TYPE OR HARDWOOD. FILTER CLOTH TO BE TO BE FASTENED SECURELY TO WOVEN WIRE
- FENCE WITH TIES SPACED EVERY 24" AT TOP AND MID SECTION. FENCE SHALL BE WOVEN WIRE, 12 1/2 GAUGE, 6" MAXIMUM MESH OPENING. WHEN TWO SECTIONS OF FILTER CLOTH ADJOIN EACH OTHER THEY SHALL BE OVER-
- MIRAFI 100X, STABILINKA T140N, OR APPROVED EQUIVALENT. 4. PREFABRICATED UNITS SHALL BE GEOFAB, ENVIROFENCE, OR APPROVED EQUIVALENT.

LAPPED BY SIX INCHES AND FOLDED. FILTER CLOTH SHALL BE EITHER FILTER X,

MAINTENANCE SHALL BE PERFORMED AS NEEDED AND MATERIAL REMOVED WHEN "BULGES" DEVELOP IN THE SILT FENCE.

U.S. DEPARTMENT OF AGRICULTURE NATURAL RESOURCES CONSERVATION SERVICE NEW YORK STATE DEPARTMENT OF ENVIRONMENTAL CONSERVATION NEW YORK STATE SOIL & WATER CONSERVATION COMMITTEE


SILT FENCE

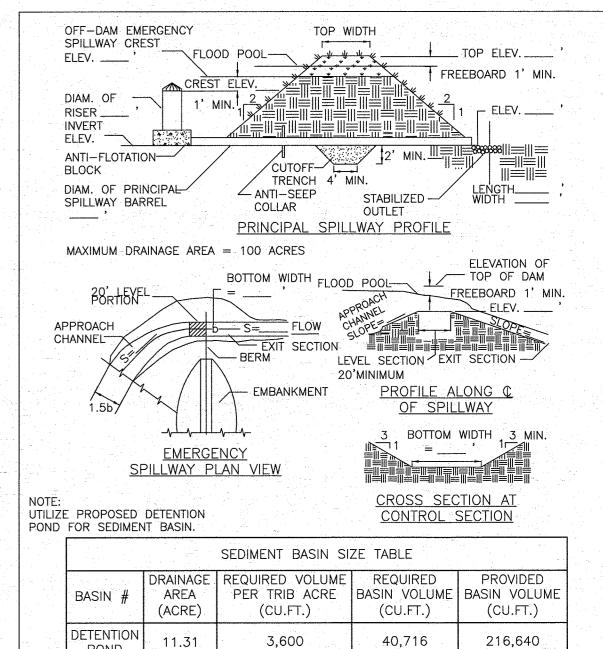

POND U.S. DEPARTMENT OF AGRICULTURE

NATURAL RESOURCES CONSERVATION SERVICE NEW YORK STATE DEPARTMENT OF ENVIRONMENTAL CONSERVATION NEW YORK STATE SOIL & WATER CONSERVATION COMMITTEE


SEDIMENT BASIN DETAILS

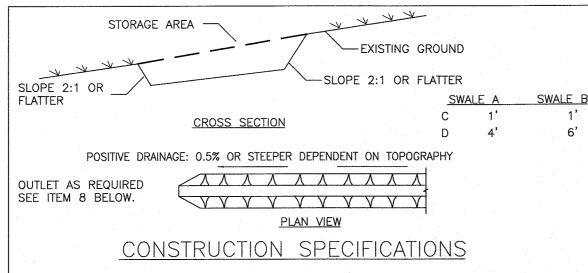

- . ALL TEMPORARY SWALES SHALL HAVE UNINTERUPTED POSITIVE GRADE TO AN OUTLET 2. DIVERTED RUNOFF FROM A DISTURBED AREA SHALL BE CONVEYED TO A SEDIMENT
- . DIVERTED RUNOFF FROM AN UNDISTURBED AREA SHALL OUTLET DIRECTLY INTO AN UNDISTURBED STABILIZED AREA AT NON-EROSIVE VELOCITY.
- I. ALL TREES, BRUSH, STUMPS, OBSTRUCTIONS, AND OTHER OBJECTIONABLE MATERIAL SHALL BE REMOVED AND DISPOSED OF SO AS NOT TO INTERFERE WITH THE PROPER FUNCTIONING OF THE SWALE.
- THE SWALE SHALL BE EXCAVATED OR SHAPED TO LINE, GRADE, AND CROSS SECTION AS REQUIRED TO MEET THE CRITERIA SPECIFIED HEREIN AND BE FREE OF BANK PROJECTIONS OR OTHER IRREGULARITIES WHICH WILL IMPEDE NORMAL FLOW.
- FILLS SHALL BE COMPACTED BY EARTH MOVING EQUIPMENT. 7. ALL EARTH REMOVED AND NOT NEEDED FOR CONSTRUCTION SHALL BE PLACED SO THAT IT WILL NOT INTERFERE WITH THE FUNCTIONING OF THE SWALE.
- 8. STABILIZATION SHALL BE AS PER THE FLOW CHANNEL STABILIZATION CHART BELOW: B(5 AC -10AC) . A(5 AC. OR LESS) TREATMENT GRADE
- SEED AND STRAW MULCH SEED AND STRAW MULCH 0.5 - 3.0%3.1-5.0% SEED AND STRAW MULCH SEED USING JUTE OR EXCELSIOR SEED WITH JUTE OR EXCELSIOR, SOD 5.1-8.0% LINED WITH 4-8" RIP-RAP OR RECYCLED CONCRETE EQUIVALENT 8.1-20.% LINED WITH 4-8" RIP-RAP ENGINEERED DESIGN
- PERIODIC INSPECTION AND REQUIRED MAINTENANCE MUST BE PROVIDED AFTER EACH RAIN EVENT.

U.S. DEPARTMENT OF AGRICULTURE NATURAL RESOURCES CONSERVATION SERVICE NEW YORK STATE DEPARTMENT OF ENVIRONMENTAL CONSERVATION NEW YORK STATE SOIL & WATER CONSERVATION COMMITTEE

TEMPORARY SWALE

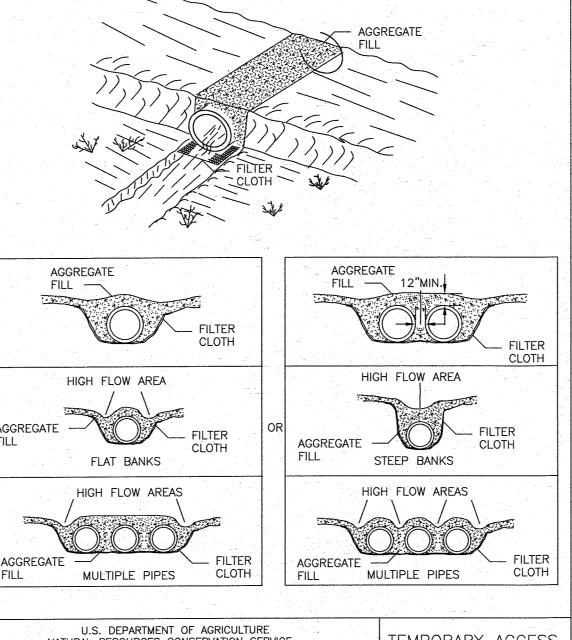


AGGREGATE NATURAL RESOURCES CONSERVATION SERVICE NEW YORK STATE DEPARTMENT OF ENVIRONMENTAL CONSERVATION

NEW YORK STATE SOIL & WATER CONSERVATION COMMITTEE

TEMPORARY ACCESS

CULVERT

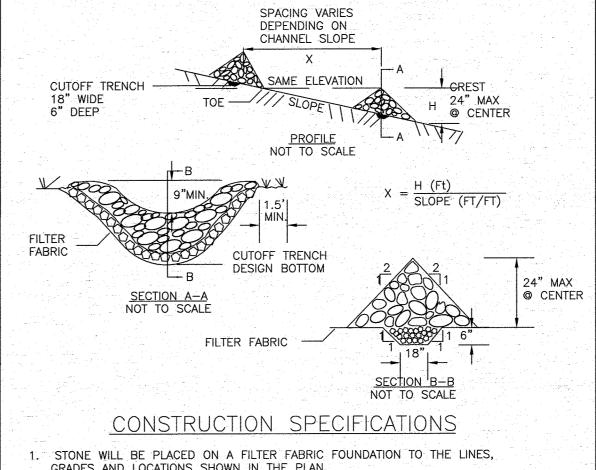

- GRADES AND LOCATIONS SHOWN IN THE PLAN. 2. SET SPACING OF CHECK DAMS TO ASSUME THAT THE ELEVATIONS OF THE CREST OF THE DOWNSTREAM DAM IS AT THE SAME ELEVATION OF THE TOE OF THE
- UPSTREAM DAM. EXTEND THE STONE A MINIMUM OF 1.5 FEET BEYOND THE DITCH BANKS TO
- PREVENT CUTTING AROUND THE DAM. PROTECT THE CHANNEL DOWNSTREAM OF THE LOWEST CHECK DAM FROM SCOUR AND EROSION WITH STONE OR LINER AS APPROPRIATE.
- 5. ENSURE THAT CHANNEL APPURTENANCES SUCH AS CULVERT ENTRANCES BELOW CHECK DAMS ARE NOT SUBJECT TO DAMAGE OR BLOCKAGE FROM DISPLACED STONE. MAXIMUM DRAINAGE AREA 2 ACRES.

NATURAL RESOURCES CONSERVATION SERVICE NEW YORK STATE DEPARTMENT OF ENVIRONMENTAL CONSERVATION NEW YORK STATE SOIL & WATER CONSERVATION COMMITTEE

U.S. DEPARTMENT OF AGRICULTURE


CHECK DAM

RESERVED FOR TOWN PLANNING BOARD APPROVAL

ORANGE COUNTY DEPARTMENT OF PUBLIC WORKS NOTE: NO SITE PREPARATION OR CONSTRUCTION, INCLUDING UTILITY CONNECTIONS, SHALL COMMENCE UNTIL A VALID HIGHWAY WORK PERMIT HAS BEEN SECURED FROM THE ORANGE COUNTY DEPARTMENT OF PUBLIC WORKS UNDER SECTION 136 OF THE HIGHWAY LAW.

01-21-16 REVISIONS AS PER 9/2 COMMENT LETTER 08-17-15 REVISIONS AS PER O.C.D.P.W. LETTER 06-01-15 REVISIONS AS PER O.C.D.P.W. LETTER NR. 12-15-14 REVISIONS AS PER 12/2 COMMENT LETTER | NR 1-18-14 REVISIONS AS PER 10/9 COMMENT LETTER NR 10-01-14 DESIGN PREPARATION DATE 12-05-13 CLUSTER SKETCH PLAN PREPARATION DATE JJP

MAP CHECK DATE: 00-00-00 INITIALED BY: -_-

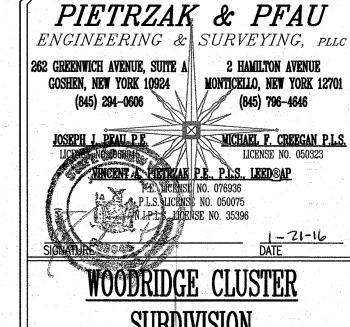

TOWN OF CHESTER COUNTY OF ORANGE, NEW YORK

<u>EROSION CONTROL</u> <u>DETAILS</u> SECTION 8 BLOCK 1 LOT 50.2

"UNAUTHORIZED ALTERATION OR ADDITION TO A PLAN BEARING A LICENSED-LAND SURVEYOR'S OR PROFESSIONAL ENGINEER'S SEAL IS A VIOLATION OF SECTION 7209, SUB-DIVISION 2 OF THE N.Y. STATE EDUCATION LAW. O.C.H.D. SHEET NO. | D.E.C. SHEET NO. | DRAWING NUMBER 10 OF 15 ______N/A__ OF ______

CAD REFERENCE | PROJECT NUMBER NO SCALE 14102 ENG BASE 14102.01

PERMANENT SEEDING MIXTURES

MODERATE TO STEEP SLOPES AND LOW MAINTENANCE AREAS APPLICATION RATE

8 LBS/ACRE EMPIRE BIRDSFOOT TREFOIL 20 LBS/ACRE TALL FESCUE 5 LBS/ACRE

GENERAL RECREATION AREAS AND LAWNS

APPLICATION RATE SUNNY SITES (WELL, MODERATELY WELL AND SOMEWHAT POORLY

DRAINED SOILS) 65% KENTUCKY BLUEGRASS BLEND 85-114 LBS/ACRE 20% PERENNIAL RYEGRASS 26-35 LBS/ACRE 19-26 LBS/ACRE 15% FINE FESCUE

SUNNY DROUGHTY SITES (SOMEWHAT EXCESSIVELY TO EXCESSIVELY DRAINED SOILS)


114-143 LBS/ACRE 65% FINE FESCUE 15% PERENNIAL RYEGRASS 26-33 LBS/ACRE 20% KENTUCKY BLUEGRASS BLEND 35-44 LBS/ACRE

SHADY DRY SITES (WELL TO SOMEWHAT POORLY DRAINED SOILS) 80% SHADE TOLFRANT KENTUCKY

105-138 LBS/ACRE BLUEGRASS BLEND 25-37 LBS/ACRE 20% PERENNIAL RYEGRASS SHADY WET SITES (SOMEWHAT POOR TO POORLY DRAINED SOILS)

70% ROUGH BLUEGRASS 80% SHADE TOLERANT KENTUCKY BLUEGRASS BLEND

60-91 LBS/ACRE 25-39 LBS/ACRE

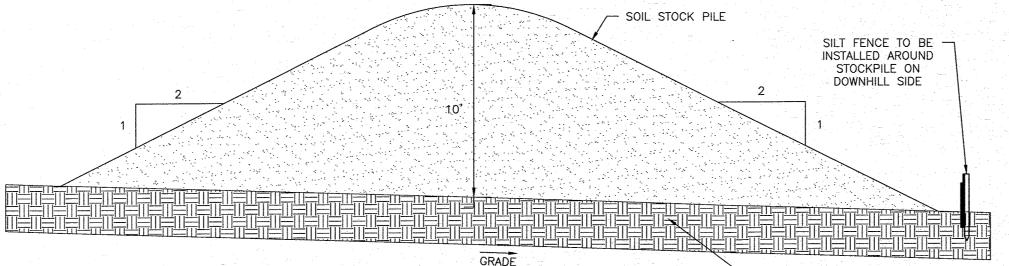

 EXISTING GRADI SOIL STOCKPILE DETAIL





PERCOLATION TESTS WERE PERFORMED AT A DEPTH OF 24" UNLESS NOTED OTHERWISE.


DEEP TEST PITS WERE WITNESSED BY PIETRZAK & PEAU. PLLC ON 6/06/14 SEPTIC SYSTEM DESIGN BASED ON 110 GALLONS PER BEDROOM PER DAY SEPTIC SYSTEM DESIGN FOR 4 BEDROOM MAXIMUM DWELLING UNLESS NOTED OTHERWISE

ALL SEPTIC SYSTEM DESIGNS INCLUDE 35 GALLONS PER DAY OF BACKWASH FOR THE OPTIONAL WATER SOFTENER, MAKING A TOTAL DISCHARGE OF 475 GALLONS PER DAY.

SURFACE WATER DIVERSION SWALES ARE REQUIRED ON ALL LOTS.

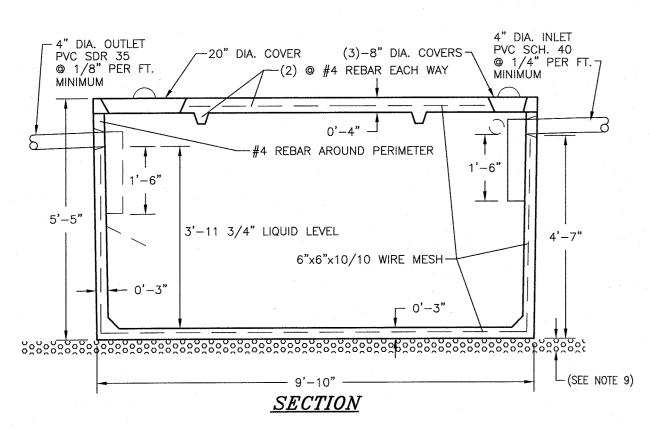

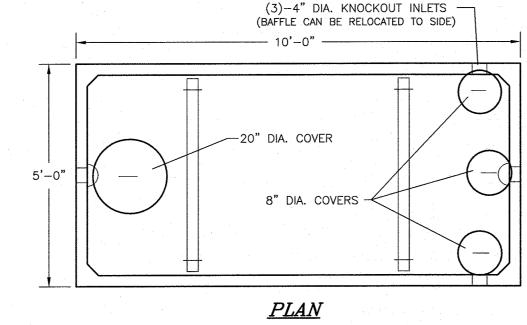

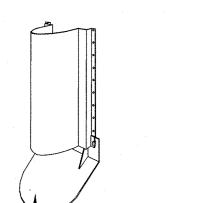

LGAS DEFLECTOR

<u>BAFFLE</u>

(DEFLECTOR ON OUTLET ONLY)

BUILDING SEWER TO BE SCHEDULE 40 PVC. SEPTIC TANK TO BE INSTALLED A MINIMUM OF TEN (10) FEET FROM BUILDING FOUNDATION.

LOCATION STAKE TO BE SET IN GROUND DIRECTLY ABOVE THE INLET END COVER. SEPTIC TANK TO BE COVERED WITH EARTH TO A MINIMUM DEPTH OF 6" AND A MAXIMUM DEPTH OF 12" PRECAST CONCRETE TO REACH 4000 PSI STRENGTH @ 28 DAYS.


TANK CONSTRUCTION JOINTS TO BE SEALED WITH BUTYL RUBBER BASE CEMENT. INLET INVERT TO BE 3" HIGHER THAN OUTLET INVERT. INLET AND OUTLET JOINTS TO BE SEALED WITH PORTLAND

CEMENT GROUT PRECAST CONCRETE SEPTIC TANK TO BE AS MANUFACTURED BY WOODARD'S CONCRETE PRODUCTS, INC. MODEL ST1250 OR EQUAL. 3" MINIMUM OF SAND, PEA GRAVEL OR TRENCH AGGREGATE FOR

11. SEPTIC TANKS SHOULD BE INSPECTED PERIODICALLY AND PUMPED EVERY 2-3 YEARS.

1,250 GALLON SEPTIC TANK DETAIL

CLEANOUT FITTING WITH SCREW TYPE CAP 45° BEND WYE FITTING CLEANOUT DETAIL

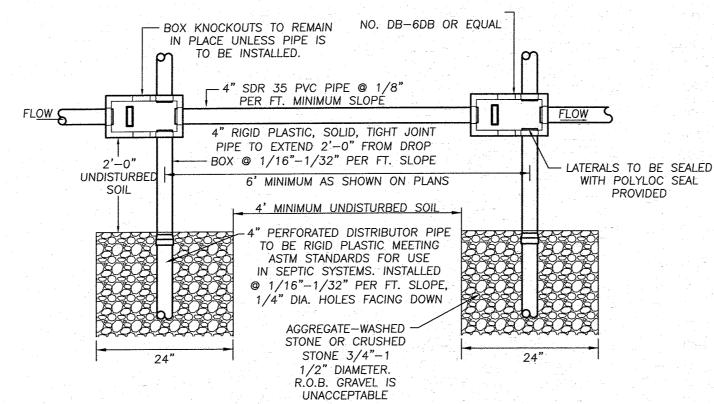

<u>PLAN</u> BACKFILL IMMEDIATELY OR TEMPORARILY -COVER TRENCH WITH IMPERVIOUS COVER. MOUND BACKFILL SLIGHTLY. 5x5x1.5" BRICK AND LESS THAN 12" GRADE AFTER SETTLEMENT AND SEED. MORTAR BAFFLE BACKFILL WITH NATIVE SOIL PIPE (1/4" HOLES-6" MINIMUM, 12" MAXIMUM FACING DOWN) PERMEABLE GEO-TEXTILE-COVER 12" PEA GRAVEL OR SAND ---AGGREGATE-WASHED STONE OR CRUSHED DROP BOX STONE 3/4" - 1 1/2" DIAMETER. UNDISTURBED SOIL 24" MIN. TO IMPERVIOUS STRATA, BEDROCK, OR SEASONAL HIGH GROUNDWATER

1. ABSORPTION FIELDS SHALL NOT BE BUILT UNDER DRIVEWAYS, PARTS OF BUILDINGS. OR UNDER ABOVE GROUND POOLS, OR OTHER AREAS SUBJECT TO HEAVY LOADINGS. 2. THE AGGREGATE SHALL BE COVERED WITH A PERMEABLE GEOTEXTILE FABRIC PRIOR TO


3. TRENCHES SHALL NOT BE CONSTRUCTED IN WET SOIL. 4. SIDES AND BOTTOM OF TRENCH SHALL BE RAKED IMMEDIATELY PRIOR TO PLACING **AGGREGATE**

THE END OF ALL DISTRIBUTOR PIPES SHALL BE PLUGGED. HEAVY EQUIPMENT SHALL BE KEPT OFF THE AREA OF THE FIELD EXCEPT FOR ACTUAL CONSTRUCTION OF TEH FIELD. THERE SHALL BE NO UNNECESSARY MOVEMENT OF CONSTRUCTION EQUIPMENT IN THE AREA OF THE PROPOSED FIELD, BEFORE OR AFTER CONSTRUCTION.


DISTRIBUTION LATERALS SHALL BE SLOPED AT 1/16"-1/32" PER FOOT. 8. DISTRIBUTION LATERALS FOR PUMPED OR DOSED SYSTEMS SHALL HAVE PIPES SET NEARLY


9. ABSORPTION TRENCH BOTTOM TO BE SET LEVEL. 10. DISTRIBUTION LATERALS ARE TO BE SET WITH PERFORATIONS FACING DOWN.

CONVENTIONAL ABSORPTION TRENCH **DETAIL**

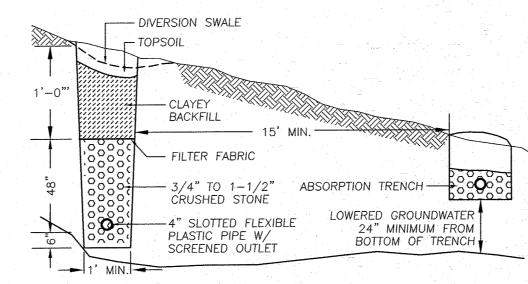


CURTAIN DRAIN DETAIL

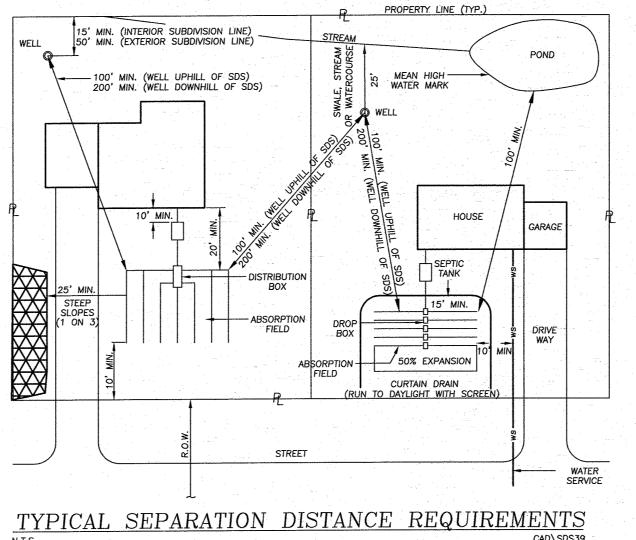

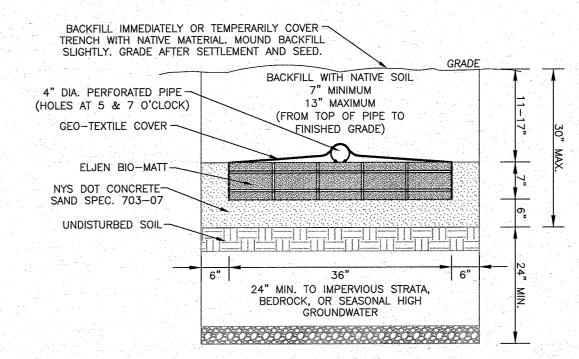

ELJEN IN-DRAIN CROSS SECTION DETAIL

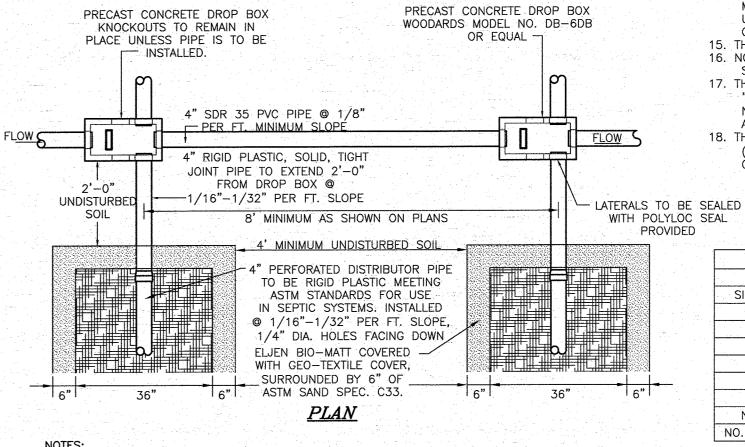

ABSORPTION FIELDS SHALL NOT BE BUILT UNDER DRIVEWAYS, PARTS OF BUILDINGS, OR UNDER ABOVE GROUND POOLS, OR OTHER AREAS SUBJECT TO HEAVY LOADINGS. THE SAND BEDDING SHALL BE COVERED WITH THE GEOTEXTILE FABRIC PROVIDED WITH EACH UNIT.

TRENCHES SHALL NOT BE CONSTRUCTED IN WET SOIL SIDES AND BOTTOM OF TRENCH SHALL BE RAKED IMMEDIATELY PRIOR TO PLACING SAND. THE END OF ALL DISTRIBUTOR PIPES SHALL BE PLUGGED.

HEAVY EQUIPMENT SHALL BE KEPT OFF THE AREA OF THE FIELD EXCEPT FOR ACTUAL CONSTRUCTION OF TEH FIELD. THERE SHALL BE NO UNNECESSARY MOVEMENT OF CONSTRUCTION EQUIPMENT IN THE AREA OF THE PROPOSED FIELD, BEFORE OR AFTER CONSTRUCTION. 7. DISTRIBUTION LATERALS SHALL BE SLOPED AT 1/16"-1/32" PER FOOT.

ABSORPTION TRENCH BOTTOM TO BE SET LEVEL. 9. DISTRIBUTION LATERALS ARE TO BE SET WITH PERFORATIONS FACING DOWN.

- WELL SEAL - MARTINSON LP-6

ELJEN IN-DRAIN SYSTEM DROP BOX/ABSORPTION TRENCH DETAIL

GENERAL NOTES - SEWAGE SYSTEMS

1. SEPTIC SYSTEMS TO CONFORM TO THE MINIMUM REQUIREMENTS OF THE N.Y.S. HEALTH DEPARTMENT STANDARDS/CODES FOR INDIVIDUAL DISPOSAL SYSTEMS,

APPENDIX 75-A, AND THE AUTHORITY HAVING JURISDICTION. 2. THE SANITARY FACILITIES ON THESE PLANS SHALL BE INSPECTED FOR COMPLIANCE, WITH THE APPROVED PLANS, AT THE TIME OF CONSTRUCTION, BY A LICENSED PROFESSIONAL ENGINEER. WRITTEN CERTIFICATION TO THAT EFFECT SHALL BE SUBMITTED TO THE COUNTY HEALTH DEPARTMENT AND THE LOCAL BUILDING CODE ENFORCEMENT OFFICER PRIOR TO OCCUPANCY, AND SHALL INDICATE THAT ANY JOINTS HAVE BEEN SEALED AND TESTED FOR WATER TIGHTNESS AND THAT THE TANK IS INSTALLED IN ACCORDANCE WITH APPENDIX 75-A AND THE MANUFACTURERS INSTRUCTIONS.

3. SEPTIC FIELDS AND WELLS SHALL NOT BE RELOCATED

4. ALL PERCOLATION TESTS TAKEN AT 24" - 30" UNLESS OTHERWISE NOTED. 5. SEPTIC SYSTEM DESIGNS ARE BASED ON THE SLOWEST PERCOLATION RATE FOUND WITHIN THE AREA OF THE SYSTEM.

6. LAUNDRY WASTE IS TO BE DISCHARGED INTO THE SEPTIC SYSTEM. 7. HOUSE SEWER AND SEWER RUNS SHALL NOT EXCEED 75' BETWEEN POINTS OF POSSIBLE CLEANOUT. AT LEAST ONE CLEANOUT IS TO BE PROVIDED. BENDS ARE TO BE AVOIDED BUT WHERE REQUIRED AN ADDITIONAL CLEANOUT SHALL BE

8. THE MAXIMUM LENGTH OF ABSORPTION LINES USED IN CONJUNCTION WITH GRAVITY DISTRIBUTION SHALL BE 60 FEET.

9. FOOTING DRAINS ARE NOT TO DISCHARGE INTO THE SEPTIC SYSTEM, FOOTING DRAINS ARE TO RUN TO DAYLIGHT WITH RODENT SCREEN.

10. UNLESS OTHERWISE INDICATED ON THESE PLANS, INDIVIDUAL SEPTIC TANKS ARE NOT DESIGNED TO ACCOMMODATE GARBAGE GRINDERS.

11. TRENCHES SHALL NOT BE CONSTRUCTED IN WET SOILS. 12. SIDES AND BOTTOM OF TRENCHES SHALL BE RAKED IMMEDIATELY PRIOR TO PLACING SAND.

13. THE END OF ALL DISTRIBUTOR PIPES SHALL BE PLUGGED 14. HEAVY EQUIPMENT SHALL BE KEPT OFF THE AREA OF THE TILE FIELD EXCEPT FOR THE ACTUAL CONSTRUCTION OF THE FIELD. THERE SHALL BE NO UNNECESSARY MOVEMENT OF CONSTRUCTION EQUIPMENT IN THE AREA OF THE PROPOSED FIELD BEFORE, DURING AND AFTER CONSTRUCTION. EXTREME CARE MUST BE TAKEN DURING THE ACTUAL CONSTRUCTION SO AS TO AVOID ANY UNDUE COMPACTION THAT COULD RESULT IN A CHANGE OF THE ABSORPTION CAPACITY OF THE SOIL ON WHICH THE DESIGN WAS BASED.

15. THERE IS NO REGRADING ALLOWED IN THE AREA OF THE ABSORPTION FIELD. 16. NO SWIMMING POOLS, DRIVEWAYS, OR STRUCTURES WHICH MAY COMPACT THE SOIL SHALL BE LOCATED OVER ANY PORTION OF THE ABSORPTION FIELD 17. THIS SYSTEM WAS NOT DESIGNED TO ACCOMMODATE GARBAGE GRINDERS, OR


"JACUZZI" TYPE SPA TUBS OVER 100 GALLONS. AS SUCH, THESE ITEMS SHALL NOT BE INSTALLED UNLESS THE SDS IS REDESIGNED TO ACCOUNT FOR THEM AND REAPPROVED BY THE ORANGE COUNTY DEPARTMENT OF HEALTH. 18. THERE MUST BE AN UNINTERRUPTED POSITIVE SLOPE FROM THE SEPTIC TANK (OR ANY PUMPING OR DOSING CHAMBER) TO THE HOUSE, ALLOWING SEPTIC

GASES TO DISCHARGE THROUGH THE STACK VENT.

ASTM SAND SPEC. C33 % PASSING BY WEIGHT MINIMUM MAXIMUM 3/8" 100 95 100 NO. 4 80 50 NO. 16 NO. 30 NO. 50 5 NO. 100 0 NO. 200, WET 0 5x5x1.5" BRICK AND LESS THAN 12" 12" PEA GRAVEL OR SAND -

> ORANGE COUNTY DEPARTMENT OF PUBLIC WORKS NOTE: NO SITE PREPARATION OR CONSTRUCTION, INCLUDING UTILITY CONNECTIONS, SHALL COMMENCE UNTIL A VALID HIGHWAY WORK PERMIT HAS BEEN SECURED FROM THE ORANGE COUNTY DEPARTMENT OF PUBLIC

WORKS UNDER SECTION 136 OF THE HIGHWAY LAW.

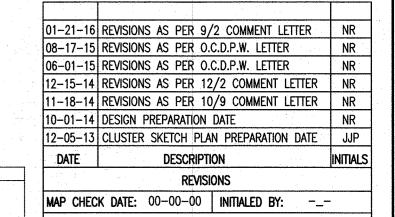

PIETRZAK & PFAU ENGINEERING & SURVEYING, PLLO

262 GREENWICH AVENUE, SUITE A 2 HAMILTON AVENUE GOSHEN, NEW YORK 10924 MONTICELLO, NEW YORK 12701 (845) 294-0606 **(845) 796-4646** WICHAEL F. CREEGAN P.L.S. <u>vincent a. Pietrzak P.E., P.Ls., leed®ap</u> P.L.S. LICENS NO. 050075 JPAS LICENSE NO. 35396

TOWN OF CHESTER

COUNTY OF ORANGE, NEW YORK PROJECT TITLE

SITE DETAILS

SECTION 8 BLOCK 1 LOT 50.2

UNAUTHORIZED ALTERATION OR ADDITION TO A PLAN BEARING A LICENSED LAND SURVEYOR'S OR PROFESSIONAL ENGINEER'S SEAL IS A VIOLATION OF SECTION 7209, SUB-DIVISION 2 OF THE N.Y. STATE EDUCATION LAW. D.C.H.D. SHEET NO. | D.E.C. SHEET NO. | DRAWING NUMBER <u>N/A</u> OF ____ __<u>11</u>__0F__<u>15</u>__ CAD REFERENCE | PROJECT NUMBER /

14102 ENG BASE

14102.01

NO SCALE

- SLOPE TO DRAIN AWAY FROM WELL - ELECTRICAL SERVICE MONITOR PS PITLESS **ADAPTER** SUBMERSIBLE PUMP -MIN.

" TYPE K COPPER WATER LINE WITH MINIMUM 4'-0" GROUT SEAL 1-1/2" THICK PORTLAND CEMENT 40' MIN. 6" STEEL WELL CASING 10" FOR WELDED PIPE 12" FOR COUPLED PIPE XEND OF CASING FIRMLY SEATED MINIMUM 10' INTO ROCK. LIMIT OF GROUT. WELL CONSTRUCTION TO CONFORM TO NYS HEALTH DEPARTMENT RURAL WATER SUPPLY STANDARDS AWWA A100 AND THE 10 STATE STANDARDS LATEST EDITIONS. MINIMUM YIFLD 5 GPM. 2. INSTALL TOP OF CASING MINIMUM 24" ABOVE THE 100 YEAR FLOOD ANTICIPATED WELL DEPTHS ARE BETWEEN 300' AND 500', WITH HARDPAN OVERBURDEN. 4. ANTICIPATED DEPTHS OF WELL CASINGS ARE 40' AND THROUGH BEDROCK 5. DIAMETER OF DRILL HOLES TO BE 10"-12" THROUGH OVERBURDEN, AND 6" THROUGH ROCK.

FOR HEALTH DEPARTMENT APPROVAL HIS SHEET IS INCOMPLETE AND INVALID WITHOUT EACH AND EVERY OTHER SHEET LISTED 6. IF WATER IS ENCOUNTERED AT A DEPTH OF LESS THAN 50 FEET,


THE MINIMUM CASING AND


REQUIREMENT SHALL BE 50 FEET.


IN THE TITLE BOX UNDER THE HEADING O.C.H.D. SHEET NO. - OF -. ENGINEER'S CERTIFICATION

THE PROPOSED SEWAGE DISPOSAL SYSTEM(S) AND WATER SUPPLY SYSTEM(S) SHOWN ARE DESIGNED IN ACCORDANCE WITH THE STANDARDS AND REQUIREMENTS ESTABLISHED BY THE NEW YORK STATE DEPARTMENT OF HEALTH AND THE NEW YORK STATE DEPARTMENT OF ENVIRONMENTAL CONSERVATION FOR RESIDENTIAL LOTS. THE DESIGN(S) ARE BASED UPON ACTUAL SOIL AND SITE CONDITIONS FOUND UPON THE LOT(S) AT THE DESIGN LOCATION AT THE TIME OF DESIGN


RESERVED FOR TOWN PLANNING BOARD APPROVAL

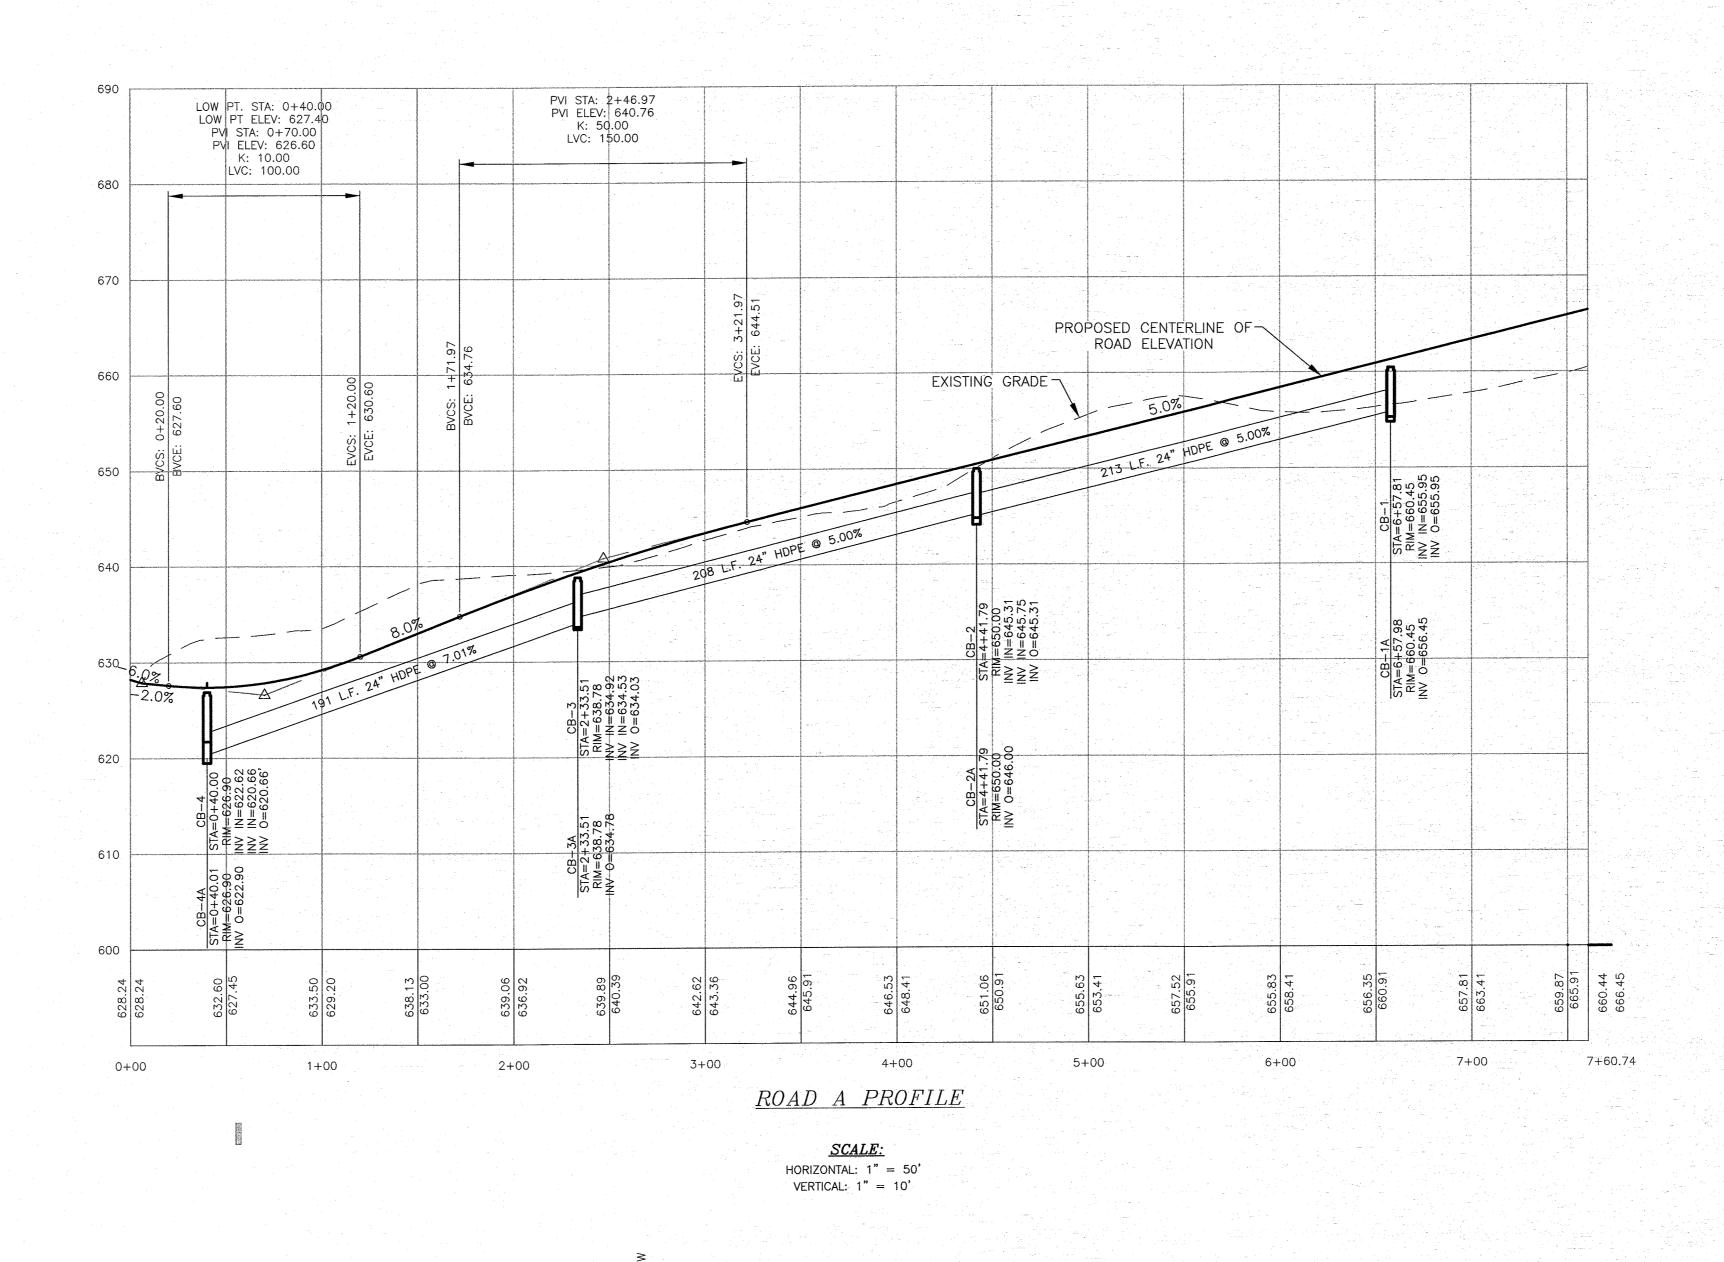

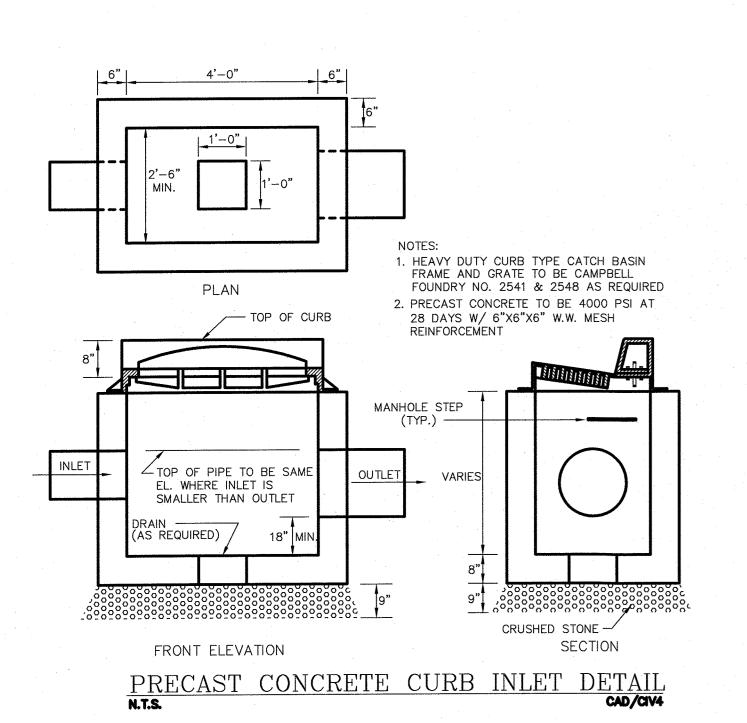

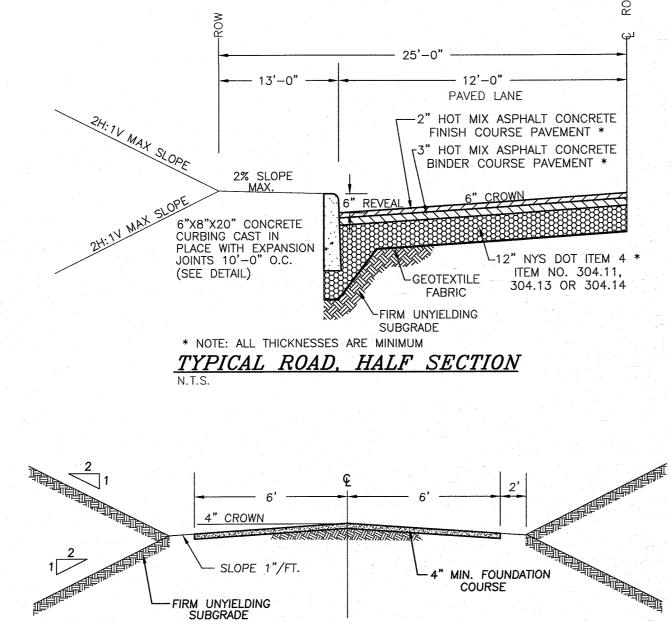


DRIVEWAY CROSS SECTION

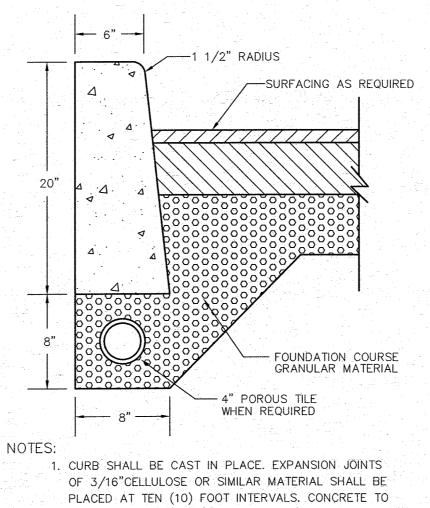

BE 1:2:3 MIX DESIGN, AIR ENTRAINED WITH DUREX OR EQUAL. 2. CONCRETE TO TEST 4000 PSI AT 28 DAYS

CONCRETE CURB DETAIL

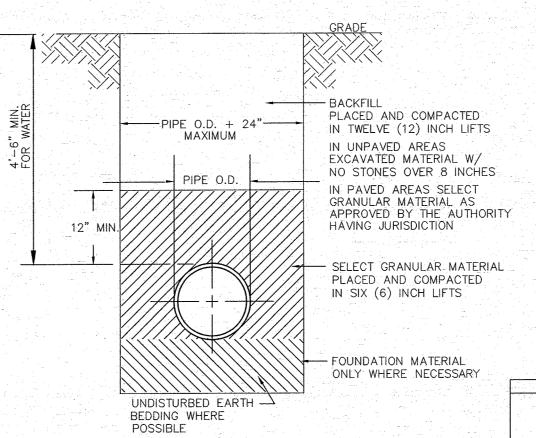

PIPE BEDDING & BACKFILL DETAIL

ORANGE COUNTY DEPARTMENT OF PUBLIC WORKS NOTE:

NO SITE PREPARATION OR CONSTRUCTION, INCLUDING UTILITY CONNECTIONS, SHALL COMMENCE UNTIL A VALID HIGHWAY WORK PERMIT HAS BEEN SECURED FROM THE ORANGE COUNTY DEPARTMENT OF PUBLIC WORKS UNDER SECTION 136 OF THE HIGHWAY LAW.

	1				
	01-21-16	REVISIONS AS PER 9/2 COMMENT LETTER	NR		
	08-17-15	REVISIONS AS PER O.C.D.P.W. LETTER	NR		
	06-01-15	REVISIONS AS PER O.C.D.P.W. LETTER	NR		
	12-15-14	REVISIONS AS PER 12/2 COMMENT LETTER	NR		
	11-18-14	REVISIONS AS PER 10/9 COMMENT LETTER	NR		
	10-01-14	DESIGN PREPARATION DATE	NR		
	12-05-13	CLUSTER SKETCH PLAN PREPARATION DATE	JJP		
	DATE	DESCRIPTION	INITIALS		
		REVISIONS			
4.20	MAP CHEC	K DATE: 00-00-00 INITIALED BY:	-		

PIETRZAK & PFAU ENGINEERING & SURVEYING, PLL 2 HAMILTON AVENUE


MONTICELLO, NEW YORK 12701 (845) 796-4646 (845) 294-0606 VICHAEL P. CREEGAN P.LS. LICENSE NO. 050323 P.E. LICENST NO. 076936 P.L.S ACTINS NO. 050075 N.J. 48 ACTINS NO. 35396


TOWN OF CHESTER COUNTY OF ORANGE, NEW YORK


RESERVED FOR TOWN PLANNING BOARD APPROVAL


PROFILE VIEW & SITE DETAILS SECTION 8 BLOCK 1 LOT 50.2


UNAUTHORIZED ALTERATION OR ADDITION TO A PLAN BEARING A LICENSED LAND SURVEYOR'S OR PROFESSIONAL ENGINEER'S SEAL IS A VIOLATION OF SECTION 7209, SUB-DIVISION 2 OF THE N.Y. STATE EDUCATION LAW. O.C.H.D. SHEET NO. | D.E.C. SHEET NO. | DRAWING NUMBER <u>N/A</u> OF ____ N/A OF ____ 12 OF 15 CAD REFERENCE PROJECT NUMBER AS SHOWN 14102 ENG BASE 14102.01

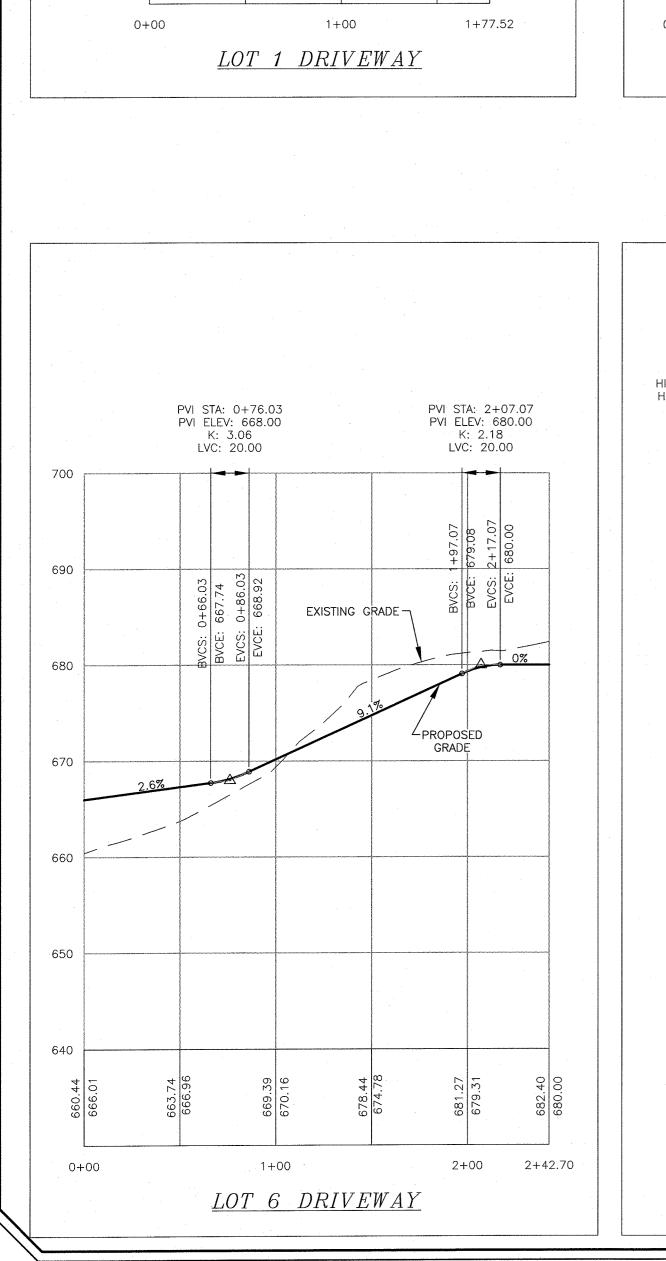


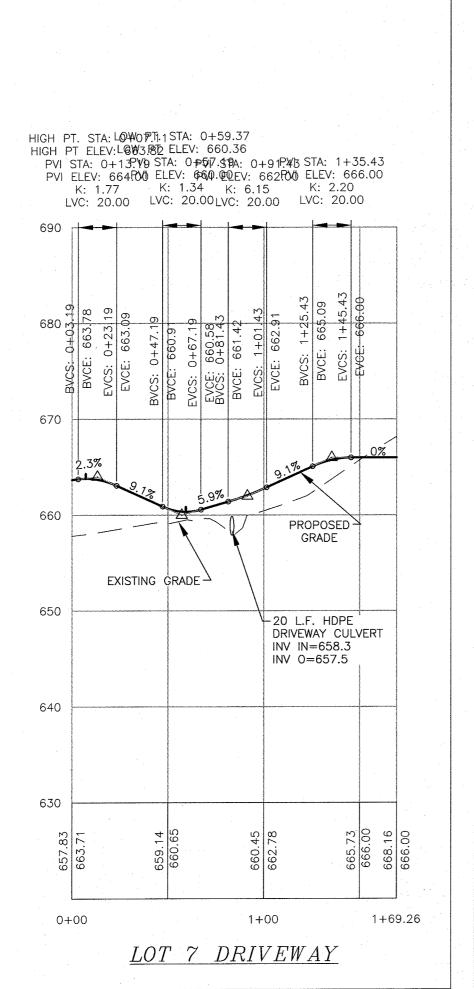


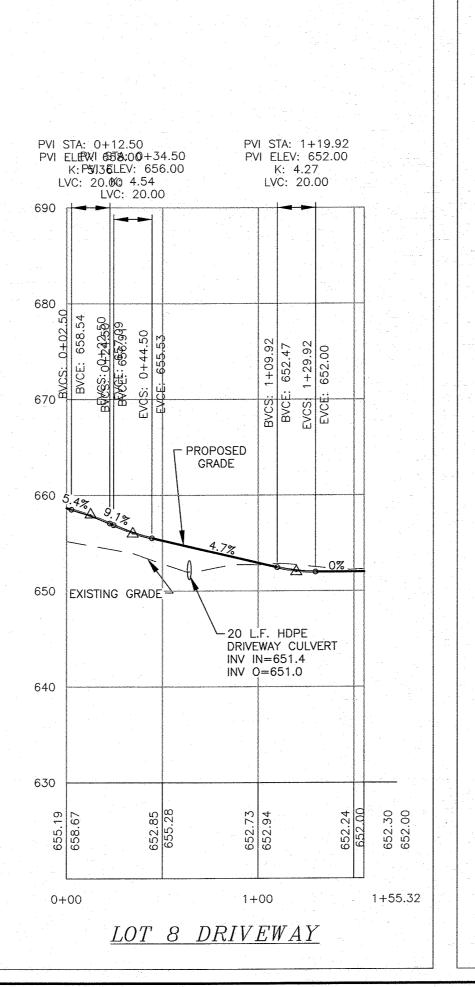


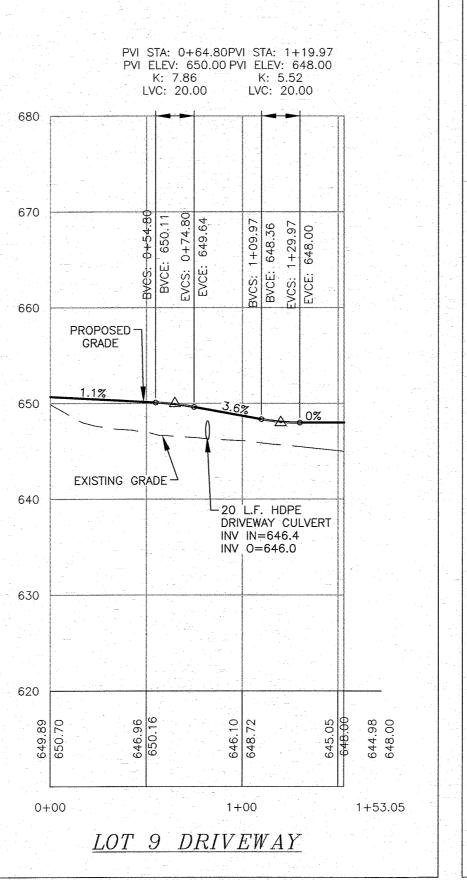


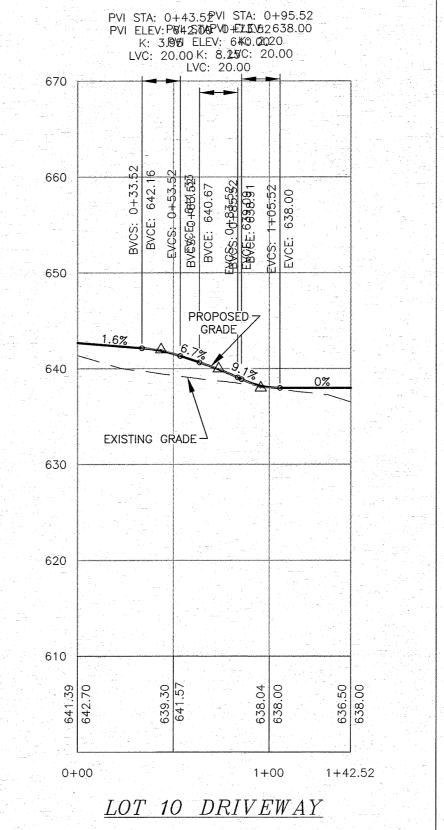


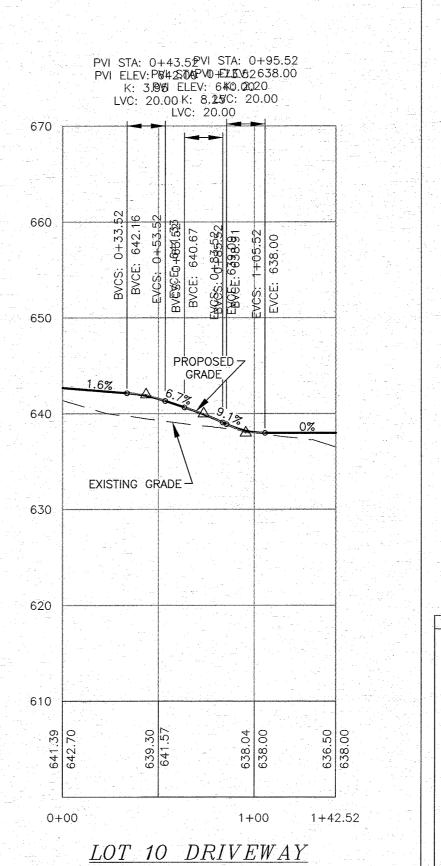


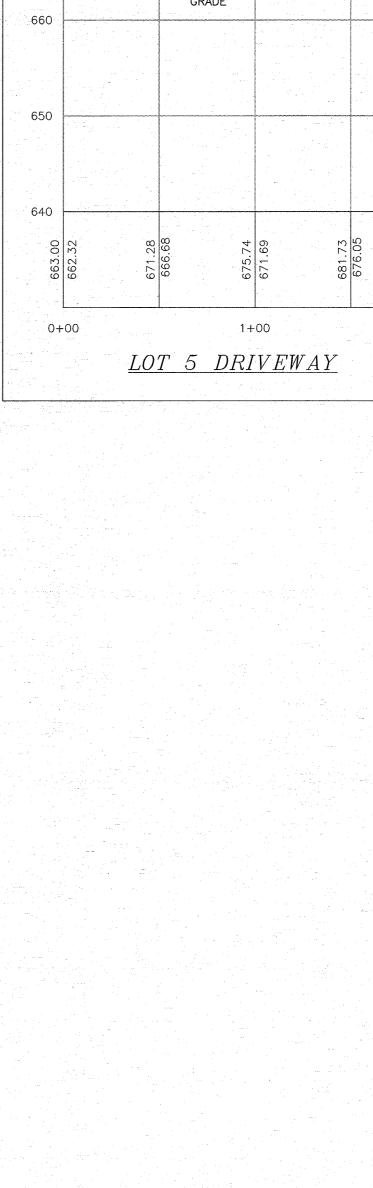

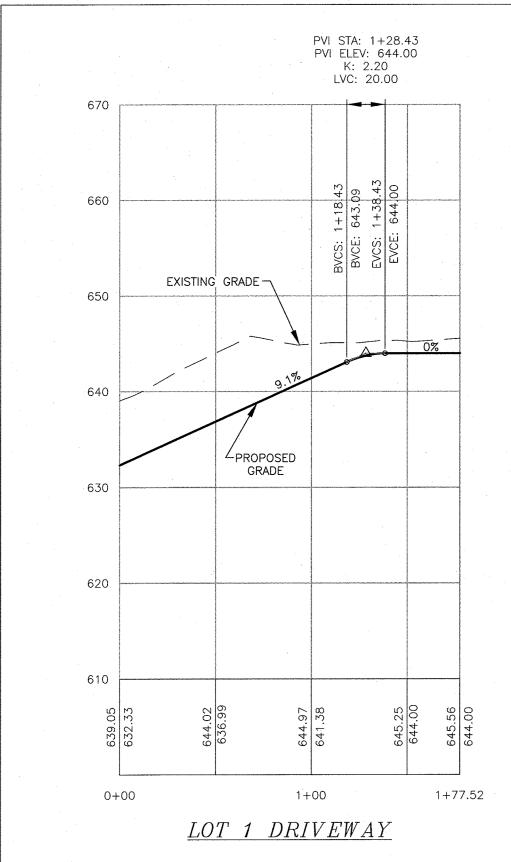


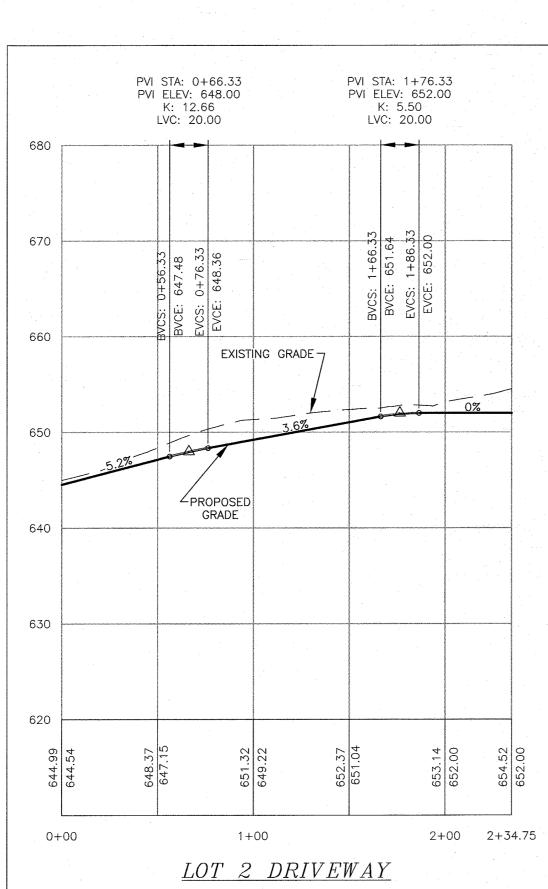


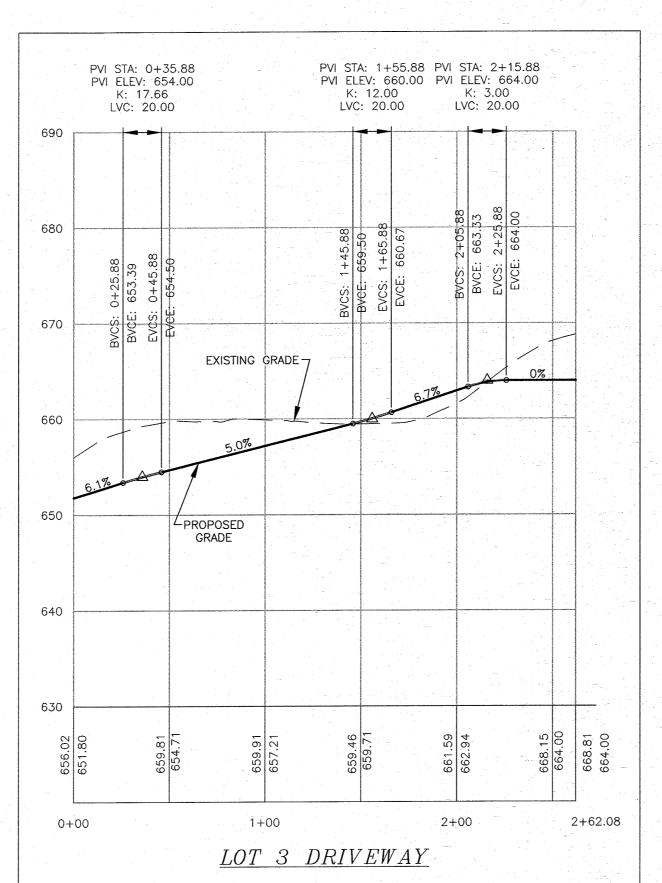

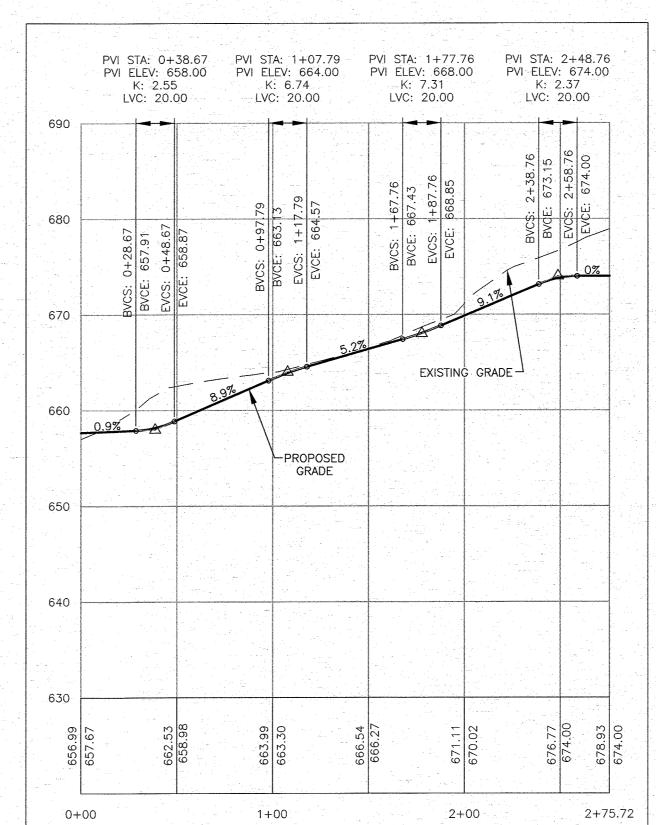

LOT 4 DRIVEWAY

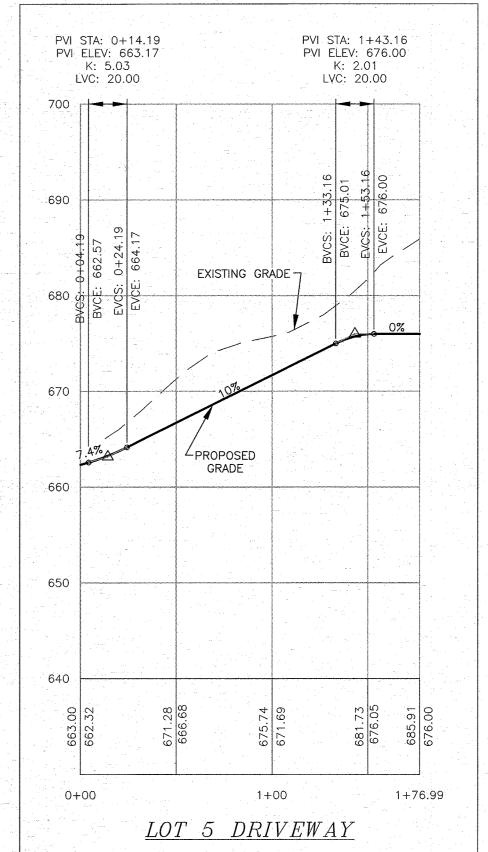

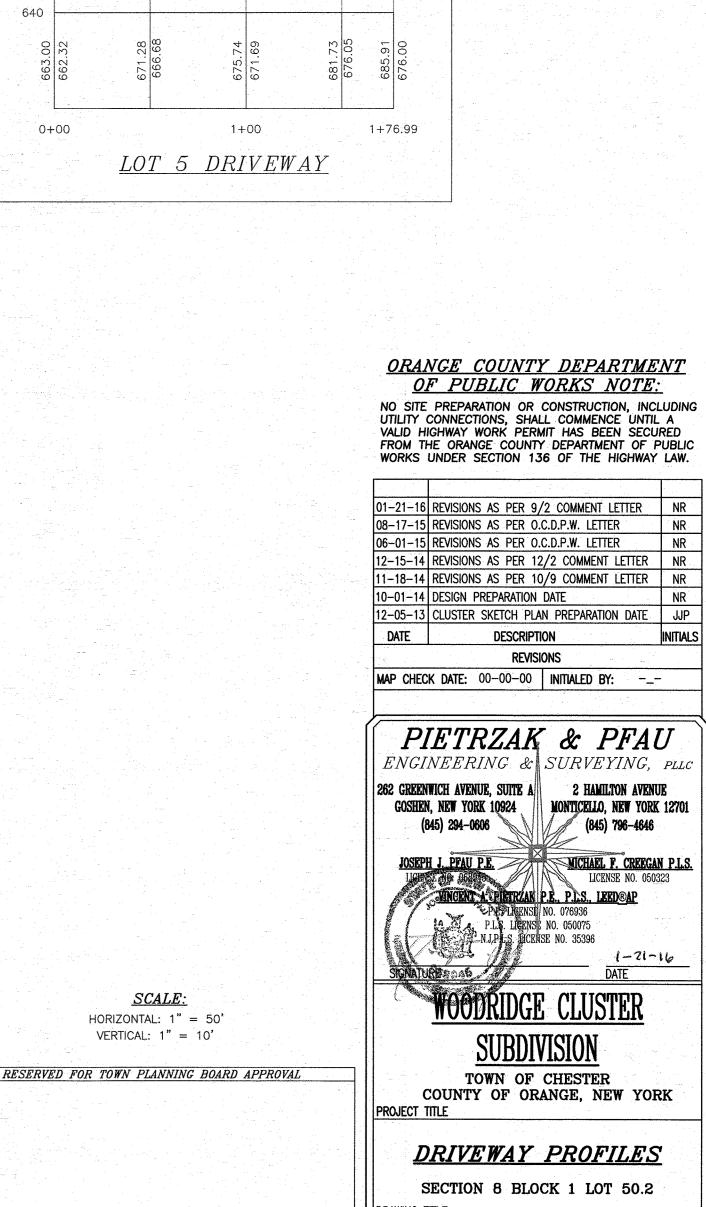

NR

NR


UNAUTHORIZED ALTERATION OR ADDITION TO A PLAN BEARING A LICENSED LAND SURVEYOR'S OR PROFESSIONAL ENGINEER'S SEAL IS A VIOLATION OF SECTION 7209, SUB-DIVISION 2 OF THE N.Y. STATE EDUCATION LAW.

O.C.H.D. SHEET NO.D.E.C. SHEET NO.DRAWING NUMBERN/AOF13OF15

SCALE

AS SHOWN

CAD REFERENCE PROJECT NUMBER
14102 ENG BASE 14102.01

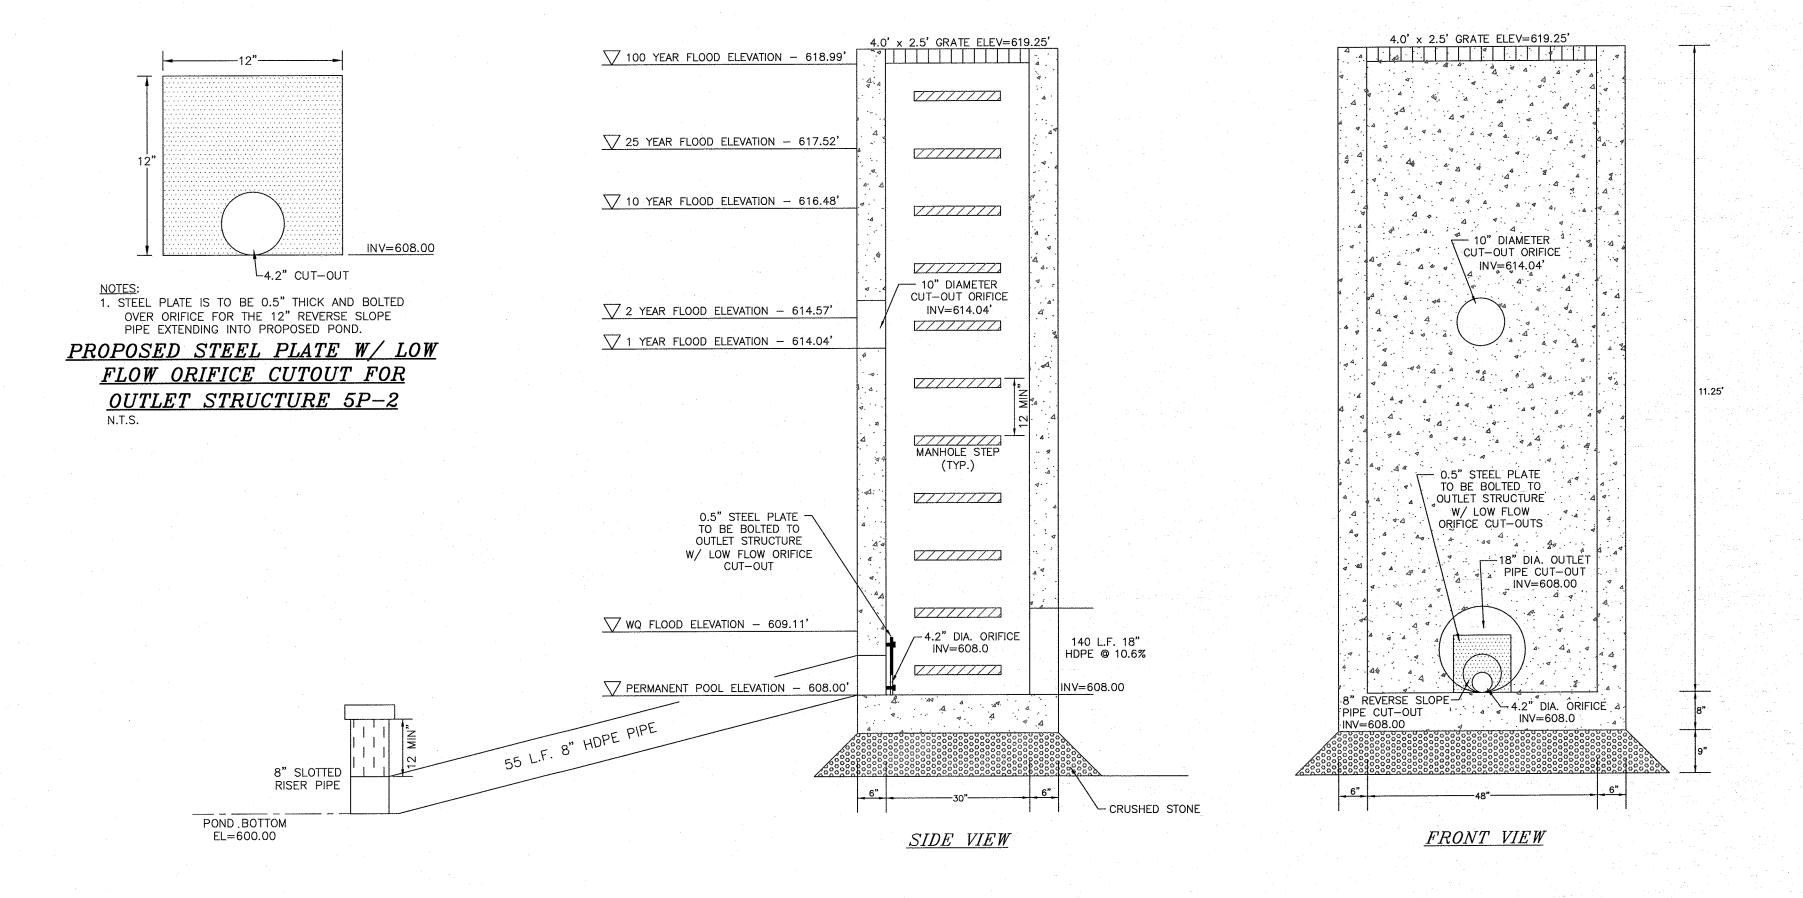

STORMWATER POND NOTES:

FOREBAY AND WET POND.

SOIL TESTING IN THE DETENTION POND AREA IS TO BE CONDUCTED AT THE


SIGNIFICANT INFILTRATION WILL OCCUR, THE PROPOSED POND IS TO BE CONSTRUCTED WITH A 6 TO 12 INCH NON-PERMEABLE CLAY LAYER (OR APPROVED EQUAL). THIS LAYER IS TO BE PROVIDED WITH AN UNDERLYING LAYER OF GEOTEXTILE FILTER FABRIC AND IS TO BE COMPACTED AND HARDENED TO EASE MAINTENANCE AND CLEANING OF

2. A 4 INCH LAYER OF TOPSOIL IS TO BE SPREAD EVENLY FROM THE TOP


OF THE POND TO 2 FEET BELOW THE PERMANENT WATER ELEVATION

TO BETTER PROMOTE VEGETATION ESTABLISHMENT.

TIME OF POND CONSTRUCTION. IF THIS TESTING REVEALS THAT

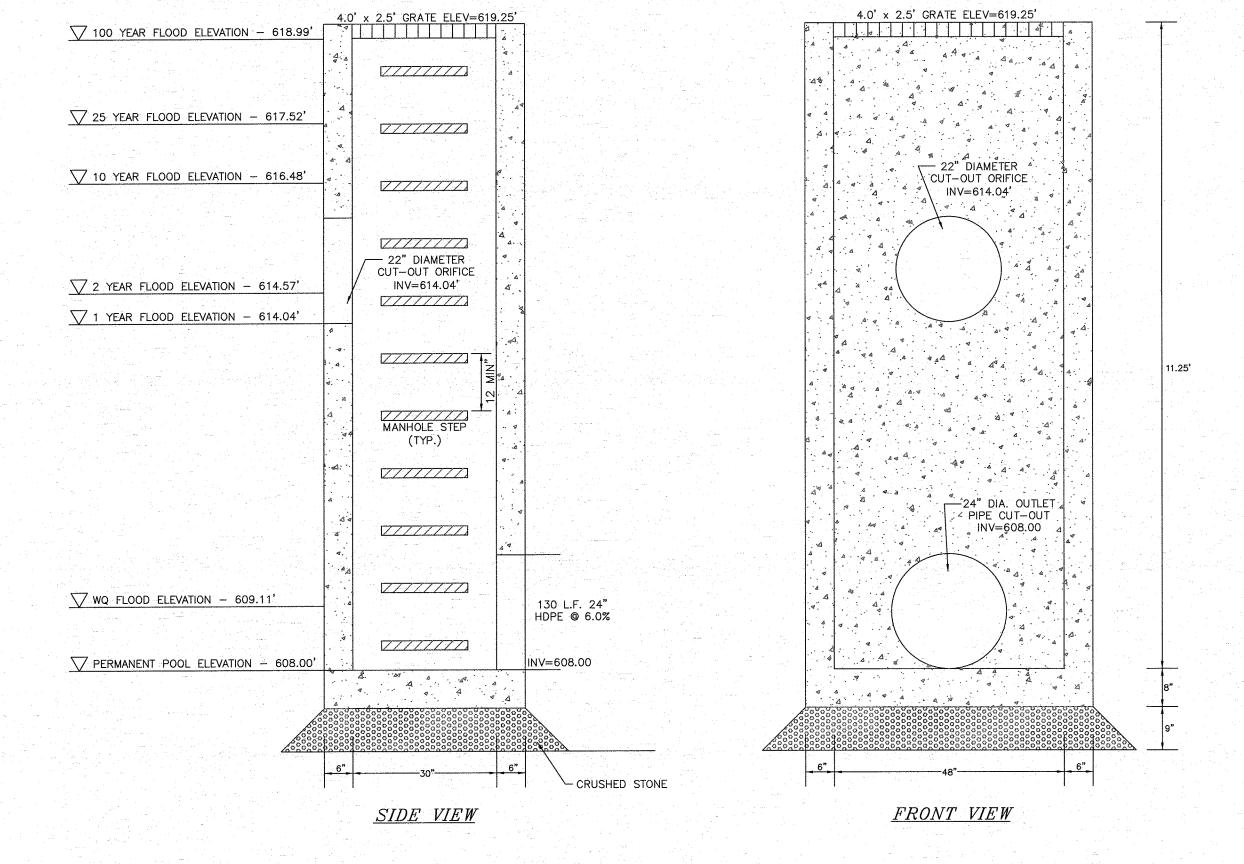

PROPOSED OUTLET CONTROL STRUCTURE 5P-2 DETAIL

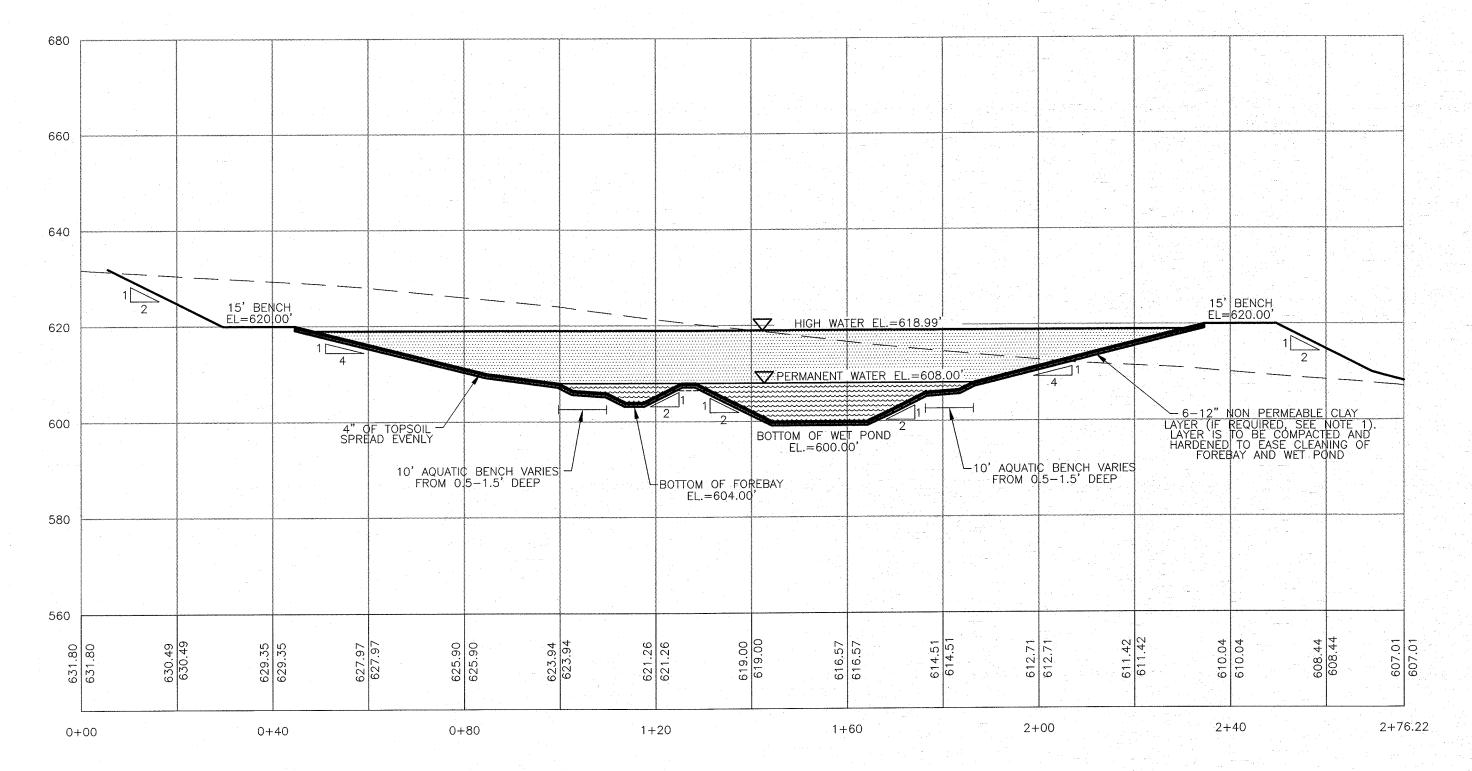


STORMWATER DETENTION POND 5P CROSS-SECTION

SCALE:


HORIZONTAL: 1" = 20'

VERTICAL: 1" = 20'

PROPOSED OUTLET CONTROL STRUCTURE 5P-3 DETAIL N.T.S.

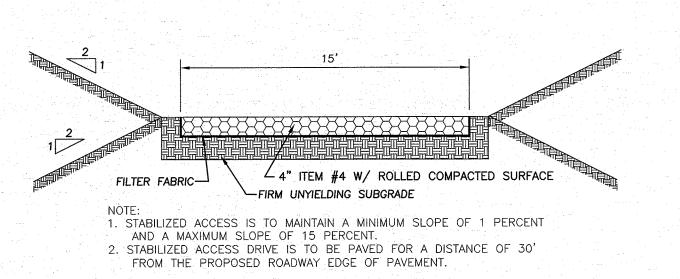

STABILIZED DETENTION POND ACCESS DRIVE DETAIL

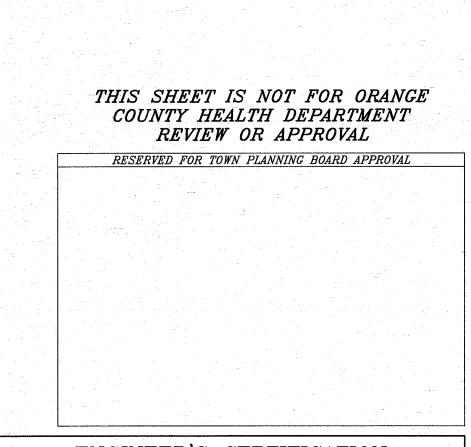

ENGINEER'S CERTIFICATION

THE PROPOSED SEWAGE DISPOSAL SYSTEM(S) AND WATER SUPPLY SYSTEM(S) SHOWN ARE DESIGNED IN ACCORDANCE WITH THE STANDARDS AND REQUIREMENTS ESTABLISHED BY THE NEW YORK STATE DEPARTMENT OF HEALTH AND THE NEW YORK STATE DEPARTMENT OF ENVIRONMENTAL CONSERVATION FOR RESIDENTIAL LOTS. THE DESIGN(S) ARE BASED UPON ACTUAL SOIL AND SITE CONDITIONS FOUND UPON THE LOT(S) AT THE DESIGN LOCATION AT THE TIME OF DESIGN.

ORANGE COUNTY DEPARTMENT
OF PUBLIC WORKS NOTE:


NO SITE PREPARATION OR CONSTRUCTION, INCLUDING UTILITY CONNECTIONS, SHALL COMMENCE UNTIL A VALID HIGHWAY WORK PERMIT HAS BEEN SECURED

FROM THE ORANGE COUNTY DEPARTMENT OF PUBLIC WORKS UNDER SECTION 136 OF THE HIGHWAY LAW.

01–21–16 REVISIONS AS PER 9/2 COMMENT LETTER NR
08–17–15 REVISIONS AS PER 0.C.D.P.W. LETTER NR
06–01–15 REVISIONS AS PER 0.C.D.P.W. LETTER NR
12–15–14 REVISIONS AS PER 12/2 COMMENT LETTER NR
11–18–14 REVISIONS AS PER 10/9 COMMENT LETTER NR
10–01–14 DESIGN PREPARATION DATE NR
12–05–13 CLUSTER SKETCH PLAN PREPARATION DATE JJP
DATE DESCRIPTION INITIALS

REVISIONS

MAP CHECK DATE: 00-00-00 INITIALED BY: -_-

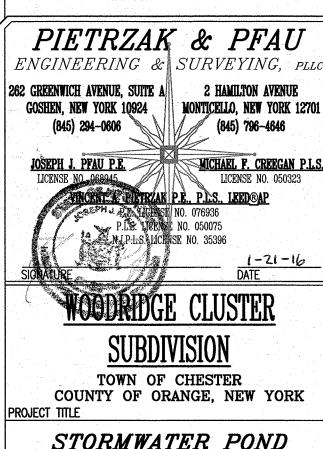

STORMWATER POND

DETAILS

SECTION 8 BLOCK 1 LOT 50.2

SECTION 8 BLOCK 1 LOT 50.2

DRAWING TITLE

UNAUTHORIZED ALTERATION OR ADDITION TO A PLAN BEARING A LICENSED LAND SURVEYOR'S OR PROFESSIONAL ENGINEER'S SEAL IS A VIOLATION OF SECTION 7209, SUB-DIVISION 2 OF THE N.Y. STATE EDUCATION LAW.

O.C.H.D. SHEET NO. D.E.C. SHEET NO. DRAWING NUMBER

<u>N/A</u> OF _____ | <u>N/A</u> OF _____ |

NO SCALE 14102 ENG BASE

14 OF 15

14102.01

CAD REFERENCE PROJECT NUMBER

SCALE:

1. THE CONTRACTOR IS RESPONSIBLE FOR MAINTAINING A VERTICAL SEPARATION OF EIGHTEEN (18) INCHES BETWEEN EXISTING UTILITIES AND ANY PROPOSED UTILITIES. 2. ALL ROAD CROSSINGS ON A COUNTY ROAD ARE REQUIRED TO BE AT 90 DEGREES.

COMPACTION EQUIPMENT NOTES:

ALL FOLLOWING EQUIPMENT IS REQUIRED TO BE ON SITE ON A DAILY BASIS AND FULLY

- 1. VIBRATORY TRENCH ROLLER; PRIMARY COMPACTION EQUIPMENT
 2. JUMPING JACK COMPACTOR; SECONDARY COMPACTION EQUIPMENT FOR USE IN
- TIGHT AREAS, WHERE THE VIBRATORY TRENCH ROLLER CANNOT BE USED. . MECHANICAL SWEEPER
- 4. SIDE-DUMP LOADER OR SKID STEER (I.E. BOBCAT) 5. ASPHALT ROLLER

IF ANY OF THE EQUIPMENT LISTED ABOVE IS NOT OPERATIONAL, NO EXCAVATING SHALL BE PERFORMED UNTIL ALL EQUIPMENT IS FUNCTIONING PROPERLY.

ASPHALT RESTORATION NOTES:

- 1. ALL PAVEMENT IS REQUIRED TO BE RESTORED ON A DAILY BASIS. 2. RAGGED TRENCH EDGES MUST SAW CUT PRIOR TO ANY PAVING (TEMPORARY OR PERMANENT).
- 3. IT WILL BE THE RESPONSIBILITY OF THE CONTRACTOR TO MAINTAIN THE 5" OF BINDER COURSE FLUSH WITH THE EXISTING PAVEMENT SURFACE THROUGHOUT THE DURATION OF THE PROJECT. FINAL ASPHALT RESTORATION IS TO BE COMPLETED
- AT THE COMPLETION OF THE PROJECT. 4. ALL TEMPORARY ASPHALT IS REQUIRED TO BE FIVE (5) INCHES THICK AND PLACED
- IN TWO (2) LIFTS OF 2-1/2 INCHES.

 5. ALL EDGES OF EXISTING ASPHALT ARE REQUIRED TO BE SWEPT AND TACK COATED
- 6. ALL ASPHALT IS REQUIRED TO BE SAW CUT PARALLEL OR PERPENDICULAR TO THE TRENCH OR TO THE EXISTING ASPHALT. NO RAGGED EDGES ARE ACCEPTABLE.
- 7. ALL SAW CUTTING IS REQUIRED TO BE PERFORMED PRIOR TO PLACING ASPHALT BINDER. MILLING OUT THE JAGGED EDGES ON THE TOP COURSE OR FINAL ASPHALT WILL NOT BE ACCEPTED BY ORANGE COUNTY.
- 8. ALL ASPHALT JOINTS ARE REQUIRED TO BE CRACK SEALED UPON COMPLETING FINAL PAVING.

- 1. CONTRACTOR SHALL BE RESPONSIBLE FOR THE REMOVAL AND REPLACEMENT OF SIGNS, GUIDE RAILS, GUIDE POSTS, CULVERT PIPES, MAILBOXES, HEADWALLS, ETC. WHICH MUST BE REMOVED FOR CONSTRUCTION. CONTRACTOR SHALL REINSTALL ANY REMOVED ITEMS ON A DAILY BASIS. ANY ITEMS DAMAGED BY REMOVAL OR REINSTALLATION SHALL BE REPLACED AND REINSTALLED BY THE CONTRACTOR WITH
- 2. NO UTILITY WORK (WATER, SEWER STORM DRAINAGE) IS ALLOWED TO BE PERFORMED BETWEEN NOVEMBER 15 AND MARCH 15 WITHIN THE COUNTY RIGHT
- 3. NO TRACK EQUIPMENT IS ALLOWED ON THE COUNTY ROAD WITHOUT PLACING MATS, PLYWOOD, TIRES, ETC. TO PROTECT THE ASPHALT ROAD.
- 4. NO OPEN TRENCHES ARE ALLOWED TO REMAIN OPEN OVERNIGHT. ALL OPEN TRENCHES ARE REQUIRED TO BE BACKFILLED ON A DAILY BASIS.
- 5. NO ROAD PLATES ARE ALLOWED TO BE USED OVERNIGHT. ROAD PLATES ARE ONLY ALLOWED TO BE USED DURING DAILY OPERATIONS TO MAINTAIN TRAFFIC ON THE ROADWAY AND AT RESIDENTIAL/COMMERCIAL DRIVEWAYS. THE CONTRACTOR IS RESPONSIBLE FOR THE PROPER COORDINATION WITH HOMEOWNERS AND BUSINESSES TO ENSURE THAT THEY CAN ENTER AND EXIT THEIR DRIVEWAYS DURING THE COURSE OF DAY TO DAY OPERATIONS.

- 1. ALL DITCHES AND SWALES ARE REQUIRED TO BE REGRADED TO ENSURE POSITIVE DRAINAGE UPON COMPLETION OF THE INSTALLATION OF THE PROPOSED CULVERT PIPE. NO EXISTING DRAINAGE CHANNEL, SWALE, DITCH, STREAM, OR STRUCTURE AFFECTING THE COUNTY ROAD SHALL BE BLOCKED OR FILLED NOR THE FLOW TO OR FROM AN EXISTING DRAINAGE CHANNEL, SWALE, DITCH STREAM, OR STRUCTURE BE
- MADE WITHOUT AN APPROVED DESIGN. 2. EXISTING DRAINAGE DITCHES ALONG THE COUNTY ROAD WILL BE REALIGNED AFTER ALL WORK IN THE COUNTY RIGHT OF WAY IS COMPLETE.

MAINTENANCE AND PROTECTION OF TRAFFIC NOTES:

- 1. PROVIDE NOTES THAT ALL WORK IS TO BE PERFORMED IN ACCORDANCE WITH ORANGE COUNTY REQUIREMENTS. THE FOLLOWING SIGNS ARE REQUIRED TO BE PLACED IN EACH DIRECTION TO PERFORM THE WORK PER THE APPROVED PLANS: ROAD WORK 1500 FT, ROAD WORK 1000 FT, ROAD WORK 500 FT, ONE LANE ROAD AHEAD, FLAGGER SYMBOL ON EACH APPROACH WHEN TAKING A TRAVEL LANE. 2. WHEN WORK IS PERFORMED ON THE SHOULDER THE FOLLOWING SIGNS ARE
- REQUIRED: ROAD WORK 1500 FT, ROAD WORK 1000 FT, ROAD WORK 500 FT, NO SHOULDER. FLAGGER SYMBOLS ARE REQUIRED TO BE AVAILABLE FOR A NO SHOULDER WORK ZONE IN CASE FLAGGERS ARE USED TO DIRECT TRAFFIC.
- 3. THE MORE STRINGENT SIGN REQUIREMENTS OF ORANGE COUNTY SUPERSEDE ANY
- 4. ALL MAINTENANCE AND PROTECTION OF TRAFFIC CONSTRUCTION SIGNAGE SHALL BE INSTALLED AND IN PLACE PRIOR ANY WORK STARTING. ALL CONSTRUCTION SIGNAGE IS REQUIRED TO MEET THE REQUIREMENTS AS PER THE "NATIONAL MANUAL OF UNIFORM TRAFFIC CONTROL DEVICES FOR STREETS AND HIGHWAYS" AND NYS SUPPLEMENT LATEST EDITION AND REVISIONS. COUNTY REQUIREMENTS ARE MORE STRINGENT WITH REGARD REQUIRED MPT SIGNAGE AND ARE THE STANDARD TO BE ADHERED TO. THE CONSTRUCTION SIGNAGE SHALL BE INSTALLED ON BREAKAWAY POSTS OR ON WIND-MASTERS AND COVERED AND UNCOVERED ON A DAILY BASIS. THE CONTRACTOR MUST HAVE ALL THE NECESSARY CONSTRUCTION SIGNS TO PERFORM THE WORK SAFELY; I.E. ADDITIONAL SIGNAGE: ONE LANE ROAD AHEAD,
- FLAGGER SYMBOL, IF A LANE HAS TO BE CLOSED TO PERFORM WORK.

 5. ALL CONSTRUCTION SIGNAGE IS REQUIRED TO BE 730-05.02 ASTM TYPE III (CLASS B) AS PER NYS STANDARD SPECIFICATIONS: CONSTRUCTION AND MATERIALS. HI-INTENSITY REFLECTIVE SHEETING OFTEN REFERRED TO AS HIGH INTENSITY. IT IS RECOMMENDED FOR HIGHWAY SIGNS, CONSTRUCTION SIGNS, DELINEATORS, AND
- OTHER WORK ZONE DEVICES. 6. WORK ZONE IS REQUIRED TO BE PROPERLY DELINEATED WITH CONES OR
- CONSTRUCTION BARRELS. 7. ORANGE COUNTY RESERVES THE RIGHT TO PRECLUDE ALL WORK AND LANE CLOSURES DURING ANY INCLEMENT WEATHER OR OTHER UNFORESEEN
- CIRCUMSTANCES (I.E. WET, ICY CONDITIONS, REDUCED VISIBILITY, TRAFFIC ACCIDENTS ON STATE, COUNTY, TOWN OR VILLAGE ROAD, OR OTHER EMERGENCIES). 8. NO LANE CLOSURES WILL BE PERMITTED FROM 12 NOON PRIOR TO A HOLIDAY
- AND UNTIL 10 AM THE DAY AFTER THE HOLIDAY.
- 9. FLAGGERS SHALL NOT CONTROL MORE THAN ONE APPROACH AT ANYTIME THROUGHOUT THE DURATION OF THE WORK ZONE. ADDITIONAL FLAGGERS ARE REQUIRED TO CONTROL ALL APPROACHES IN A WORK ZONE.
- 10. EIGHTEEN (18) INCH STOP AND SLOW PADDLES ARE REQUIRED TO DIRECT TRAFFIC. 11. TWO WAY RADIOS ARE REQUIRED FOR FLAGGERS TO COMMUNICATE BETWEEN EACH

OSHA REQUIREMENTS:


ALL OSHA REQUIREMENTS MUST BE ADHERED TO AT ALL TIMES.

2. SHORING: THE CONTRACTOR SHALL BE RESPONSIBLE FOR SHORING ANY TRENCH OR EXCAVATION THAT IS GREATER THAN 5 FEET DEEP OR WHICH, IN THE OPINION OF THE OCDPW INSPECTOR IN THE FIELD POSES A DANGER TO THE CONTRACTOR PERSONNEL ON THE JOB. THE CONTRACTOR HAS THE OPTION OF USING A PREFABRICATED SHORING SYSTEM, INSTALLING A TIMBER-CONSTRUCTED SYSTEM AS PER OSHA SPECIFICATIONS OR A TIMBER SYSTEM DESIGNED AND STAMPED BY A PROFESSIONAL ENGINEER. NO OTHER SHORING SYSTEM WILL BE APPROVED FOR USE ON THIS PROJECT.

WORK HOURS NOTES:

1. THE NORMAL WORKING HOURS FOR THIS PROJECT IS 7:00 AM TO 3:30 PM. ALL TRAFFIC LANES MUST BE BACK IN SERVICE BY 4:30 PM. OCDPW MUST APPROVE ANY CHANGES TO THESE HOURS IN ADVANCE.


2. NO HOLIDAY WORK AS PER ORANGE COUNTY'S APPROVED HOLIDAY SCHEDULE.

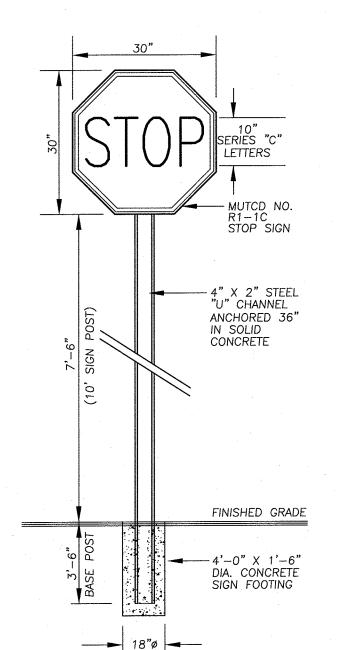


1. ALL SIGNAGE MUST BE MOUNTED ON BREAK-AWAY POSTS. 2. SIGN TO BE 30"x30" 3M HI INTENSITY PRISMATIC GRADE STOP SIGN

- OR APPROVED EQUAL 3. BASE POST SHALL NOT PROJECT MORE THAN 4" ABOVE FINISHED
- 4. BASE POST AND SIGN POST TO BE HOT DIPPED GALVANIZED WITH A
- BREAKING STRENGTH OF 4 LB/FT MIN. 5. ATTACHED TO SIGN POST SHALL BE TWO (2) 36" X 3" WIDE RED HI

INTENSITY PRISMATIC GRADE REFLECTIVE POST PANELS.

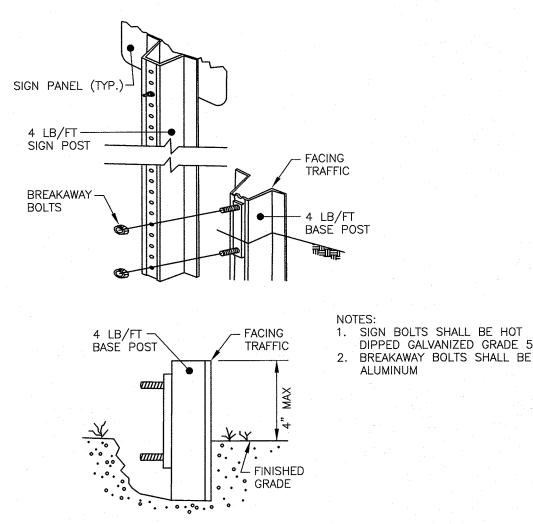


ANCHOR POST ASSEMBLY SIGN SUPPORTS DETAIL

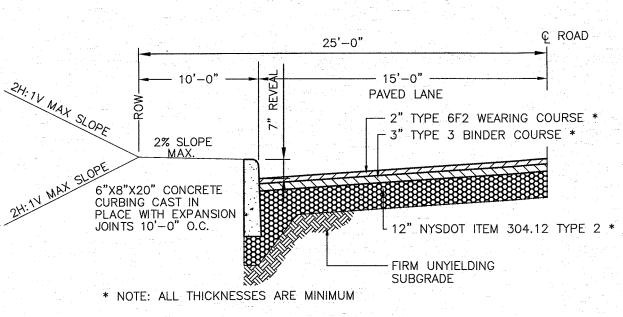

1. PROPOSED ROADWAY ENTRANCE IS TO BE PAVED IN ACCORDANCE WITH THIS DETAIL FOR THE FIRST 50 FEET OF PROPOSED ROADWAY BEGINNING AT THE EDGE OF THE EXISTING TRAVEL LANE (WHITE LINE) OF LAROE ROAD (COUNTY ROAD 45). 2. CURBS WITHIN THE COUNTY ROAD R.O.W. MUST HAVE A 7" REVEAL.

. ANY EXISTING STRIPING THAT IS REMOVED DURING TRENCH EXCAVATION OR DURING MILLING OPERATIONS IS REQUIRED TO BE REPLACED. 4. ALL SLOPES AT THE PROPOSED ENTRANCE SHALL BE 1 ON 3 MINIMUM


O.C.D.P.W. ROAD ENTRANCE DETAIL

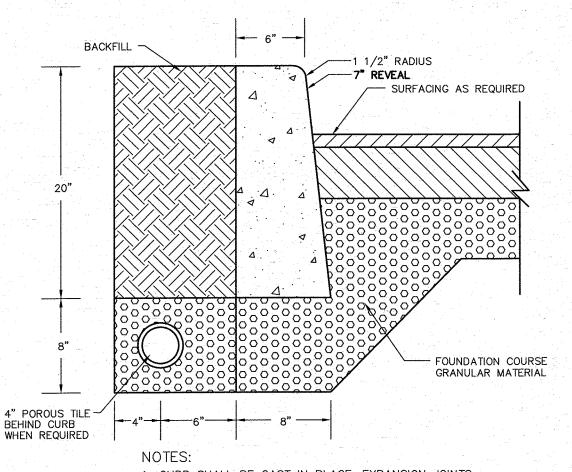

1. CURB SHALL BE CAST IN PLACE. EXPANSION JOINTS OF 3/16"CELLULOSE OR SIMILAR MATERIAL SHALL BE PLACED AT TEN (10) FOOT INTERVALS. CONCRETE TO BE 1:2:3 MIX DESIGN, AIR ENTRAINED WITH DUREX OR EQUAL.

CONCRETE CURB DETAIL

2. CONCRETE TO TEST 4000 PSI AT 28 DAYS

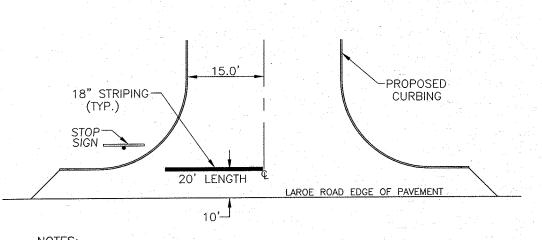


1. REFLECTORIZED PAVEMENT MARKING PAINTS SHALL BE SELECTED FROM THE NYS DOT APPROVED LIST OF WHITE AND YELLOW REFLECTORIZED

- PAVEMENT MARKING PAINTS. 2. IMMEDIATELY FOLLOWING PAINT APPLICATION, REFLECTIVE GLASS BEADS
- SHALL BE UNIFORMLY APPLIED AT A RATE OF 6 LB/GAL OF PAINT.
- 3. THE APPLIED PAVEMENT MARKINGS SHALL HAVE CLEAN-CUT EDGES AND TRUE AND SMOOTH ALIGNMENT.


SPECIFICATIONS.


4. STOP BAR WIDTH IS TO BE 1'-6". 5. PAVEMENT STRIPING SHALL BE IN CONFORMANCE WITH SECTION 640 REFLECTORIZED PAVEMENT MARKING PAINTS OF THE NYSDOT STANDARD

STOP LINE STRIPING DETAIL

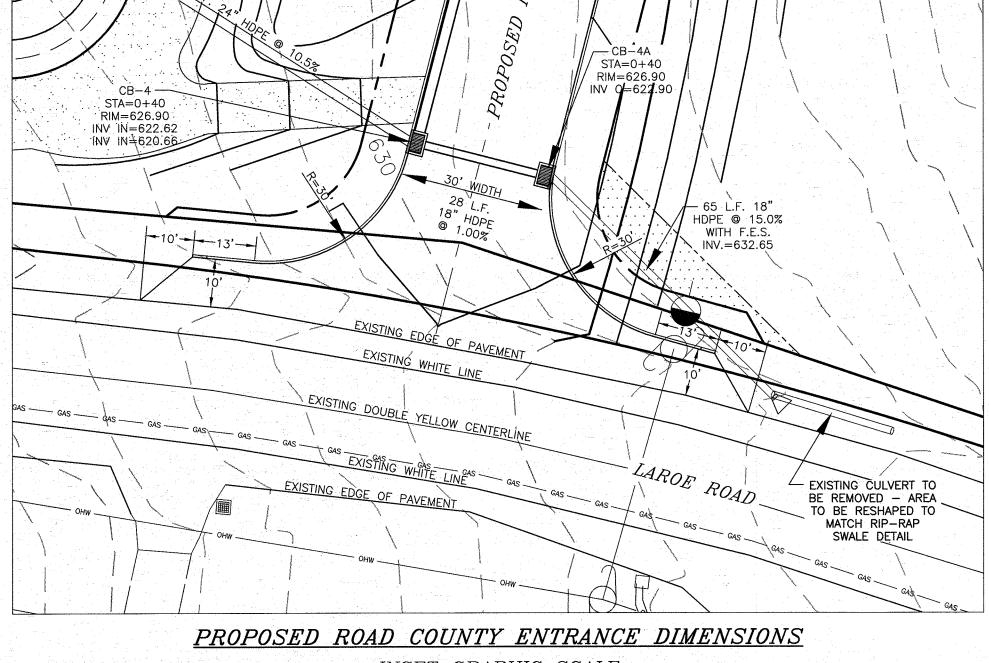

INSET GRAPHIC SCALE

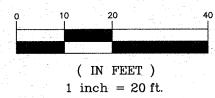

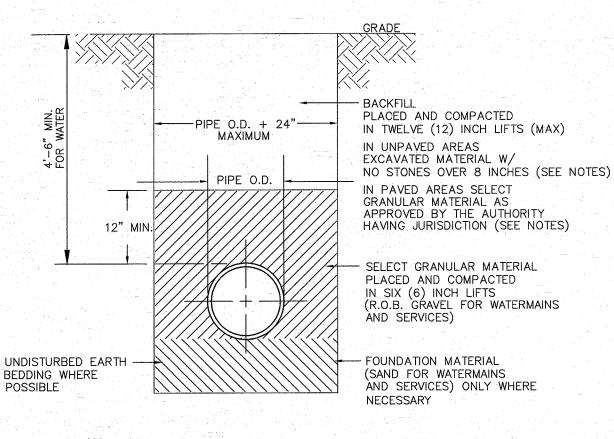


PIPE BEDDING & BACKFILL DETAIL

BACKFILL MATERIAL NOTES:

- 1. ALL BACKFILL IS REQUIRED TO BE BACKFILLED IN TWELVE (12) INCH LIFTS MAXIMUM. 2. DRY K CRETE SHALL BE USED AT ALL ROAD CROSSINGS (TOWN ROADS),
- COMMERCIAL ENTRANCES, AND ALL TRENCHES WITHIN ASPHALT OR AS DIRECTED BY ORANGE COUNTY INSPECTOR.
- 3. ITEM NO. 4: ITEM 304.12 SUBBASE COURSE TYPE 2 IS REQUIRED TO BE USED AS BACKFILL FROM EDGE OF PAVEMENT OUT EIGHT (8) FEET.

INSPECTOR ON A DAILY BASIS FOR ALL MATERIAL USED IN THE COUNTY RIGHT OF

- 4. EXCAVATED MATERIAL IS ALLOWED TO BE USED AS BACKFILL MATERIAL EIGHT (8) FEET BEYOND THE EDGE OF PAVEMENT. NO BOULDERS/ROCKS OVER 12 INCHES
- ARE ALLOWED TO BE USED AS BACKFILL. 5. MATERIAL TICKETS ARE REQUIRED TO BE PROVIDED TO THE ORANGE COUNTY

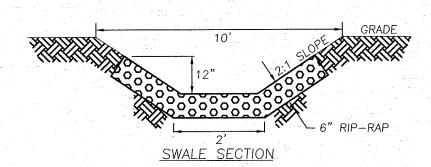

1. ALL EXISTING SWALE RESTORATION IS TO MATCH EXISTING RIP-RAP SWALE CROSS SECTION AND DIMENSIONS. 2. THE SIZE OF THE RIP-RAP FOR RESTORATION PURPOSES IS TO BE REPLACED IN KIND. RIP-RAP SWALE DETAIL

RESERVED FOR TOWN PLANNING BOARD APPROVAL

ORANGE COUNTY DEPARTMENT OF PUBLIC WORKS NOTE.

NO SITE PREPARATION OR CONSTRUCTION, INCLUDING UTILITY CONNECTIONS, SHALL COMMENCE UNTIL A VALID HIGHWAY WORK PERMIT HAS BEEN SECURED FROM THE ORANGE COUNTY DEPARTMENT OF PUBLIC WORKS UNDER SECTION 136 OF THE HIGHWAY LAW.

			1		
	01-21-16	REVISIONS AS PER 9/2 COMMENT LETTER	NR		
	08-17-15	REVISIONS AS PER O.C.D.P.W. LETTER	NR		
	06-01-15	REVISIONS AS PER O.C.D.P.W. LETTER	NR		
	12-15-14	REVISIONS AS PER 12/2 COMMENT LETTER	NR		
	11-18-14	REVISIONS AS PER 10/9 COMMENT LETTER	NR		
	10-01-14	DESIGN PREPARATION DATE	NR		
	12-05-13	CLUSTER SKETCH PLAN PREPARATION DATE	JJP		
4.12	DATE	DESCRIPTION	INITIALS		
	REVISIONS				
	MAP CHEC	K DATE: 00-00-00 INITIALED BY:			

PIETRZAK & PFAU ENGINEERING & SURVEYING, PLL 262 GREENWICH AVENUE, SUITE A 2 HAMILTON AVENUE MONTICELLO, NEW YORK 12701

GOSHEN, NEW YORK 10924 (845) 294-0606 **(845) 796-4646** MICHAEL F. CREEGAN P.L.S. JOSEPH J. PFAU P.E. LICENSE NO. 068945

VINCENT A SETTEZAN P.E., P.LS., LEED®AP PA RCENSI NO. 076936
PAS PAGENS NO. 050075 EERSE NO. 35396

WOODRIDGE CLUSTEF

TOWN OF CHESTER COUNTY OF ORANGE, NEW YORK

O.C.D.P.W. DETAILS

SECTION 8 BLOCK 1 LOT 50.2

UNAUTHORIZED ALTERATION OR ADDITION TO A PLAN BEARING A LICENSED LAND SURVEYOR'S OR PROFESSIONAL ENGINEER'S SEAL IS A VIOLATION OF SECTION 7209, SUB-DIVISION 2 OF THE N.Y. STATE EDUCATION LAW. O.C.H.D. SHEET NO. D.E.C. SHEET NO. DRAWING NUMBER <u> 15</u> OF <u>15</u> <u>N/A</u> OF ____ <u>N/A</u> OF ____

CAD REFERENCE | PROJECT NUMBER NO SCALE 14102 ENG BASE 14102.01

STOP SIGN DETAIL