



<u>EROSION CONTROL SEQUENCE</u>

MEASURES SHALL BE TAKEN TO PREVENT SOIL EROSION DURING PROJECT CONSTRUCTION. ALL FRESHLY DISTURBED AREAS THAT WILL REMAIN DISTURBED FOR MORE THAN A PERIOD OF FOURTEEN (14) DAYS SHALL BE STABILIZED BY TEMPORARY SEEDING AS INDICATED ON THE TEMPORARY SEEDING SCHEDULE. DISTURBED AREAS SHALL BE MINIMAL IN SIZE AND SHALL NOT EXCEED THE APPROVED CLEARING AND GRADING LIMITS. THE FOLLOWING MEASURES SHALL BE IMPLEMENTED AS CONSTRUCTION PROGRESSES.

- A. PRIOR TO COMMENCING CONSTRUCTION ACTIVITIES, THE LIMITS OF CLEARING AND GRADING SHALL BE MARKED. FILTER FABRIC SEDIMENTATION BARRIERS (SILT FENCE) SHALL BE PLACED ALONG THE DOWNGRADE PERIMETER OF THE SITE AND ANY OTHER AREAS WHERE SILT FENCE IS INDICATED AS TO BE INSTALLED "PRIOR TO CONSTRUCTION" ON THE APPROVED PLANS. INSTALLATION IS TO BEGIN AT THE DOWNSTREAM PORTIONS OF THE SITE THEN WORKING UPSTREAM.
- STABILIZED CONSTRUCTION ENTRANCES SHALL BE BUILT IN THE AREAS SHOWN ON THE APPROVED PLANS AND WHEREVER A CONSTRUCTION ACCESS ROAD INTERSECTS ANY PUBLIC THROUGHFARE. STABILIZED ENTRANCES SHALL BE BUILT IN ACCORDANCE WITH THE STABILIZED CONSTRUCTION ENTRANCE DETAIL.
- UPON COMPLETION OF CLEARING AND GRUBBING ACTIVITIES, TOPSOIL SHALL BE STRIPPED AND STOCKPILED FROM ALL AREAS TO BE DISTURBED. STOCKPILED TOPSOIL SHALL BE STABILIZED BY TEMPORARY SEEDING AND SURROUNDED WITH A PERIMETER SILT FENCE.
- TEMPORARY EROSION CONTROL DEVICES SHALL BE INSTALLED PRIOR TO COMMENCING EARTH MOVING ACTIVITIES. THIS INCLUDES SEDIMENTATION TRAPS, TYPE "B" DIVERSION SWALES (WITH CHECK DAMS IF APPLICABLE) AND SILT FENCE IN AREAS NOT DESIGNATED TO BE GRADED. INSTALLATION SHALL BEGIN AT DOWNSTREAM PORTIONS OF THE SITE THEN WORKING UPSTREAM. INFILTRATION AND FILTERING PRACTICES, SUCH AS SAND FILTERS AND BIORETENTION PONDS SHALL NOT HAVE INFILTRATION AND FILTER MEDIA INSTALLED UNTILL ALL TRIBUTARY AREAS HAVE BEEN SUBSTANTIALLY STABILIZED.
- E. IMMEDIATELY AFTER COMPLETION OF ROUGH GRADING, REMAINING TEMPORARY EROSION CONTROL SHALL BE INSTALLED AS SPECIFIED ON THE APPROVED PLANS. THIS INCLUDES ANY REMAINING SILT FENCE AND TYPE "A" DIVERSION SWALES (WITH CHECK DAMS IF APPLICABLE). AREAS NOT REQUIRING FURTHER EARTHWORK SHALL BE FINE GRADED, TOPSOILED, AND STABILIZED AS EARLY AS POSSIBLE.
- F. ANY PROPOSED STORM DRAINAGE SHALL BE INSTALLED AND INCORPORATED INTO EROSION CONTROL AS SPECIFIED ON THE APPROVED PLANS. STORM DRAINAGE COMPONENTS SHALL BE PROTECTED FROM SILTATION AS
- G. UPON COMPLETION OF CONSTRUCTION ACTIVITES, REMAINING AREAS SHALL BE FINE GRADED, TOPSOILED, AND STABILIZED. PERMANENT VEGETATION AND LANDSCAPING SHALL BE ESTABILISHED
- H. TEMPORARY EROSION CONTROL DEVICES SHALL BE REMOVED ONCE UPSTREAM AREAS HAVE BEEN PERMANENTLY STABILIZED. REMOVAL OF TEMPORARY EROSION CONTROL DEVICES SHALL BEGIN WITH THE MOST UPSTREAM PORTIONS OF THE SITE THEN WORKING DOWNSTREAM.
- I. ALL NEWLY SEEDED VEGETATIVE COVER SHALL BE MAINTAINED. WASHOUTS OR POORLY GROWING AREAS SHALL BE CORRECTED AS THEY OCCUR.

GENERAL EROSION CONTROL NOTES

- FILTER FABRIC IS TO BE MIRAFI 140 AS MANUFACTURED BY THE CELANESE CORPORATION OR APPROVED EQUAL. WHEREVER FEASIBLE, NATURAL VEGETATION SHOULD BE RETAINED AND PROTECTED. ONLY THE SMALLEST PRACTICAL AREA OF LAND SHOULD BE EXPOSED AT ANY ONE TIME DURING DEVELOPMENT. . WHEN LAND IS EXPOSED DURING DEVELOPMENT, THE EXPOSURE SHALL BE KEPT TO THE SHORTEST PRACTICAL
- 5. ALL WORK SHALL BE IN ACCORDANCE WITH ALL OF THE ATTACHED DRAWINGS.

MAINTENANCE REQUIREMENTS

1. THE MAINTENANCE OF EROSION CONTROL DEVICES WILL BE THE RESPONSIBILITY OF THE CONTRACTOR. THE JOB SUPERINTENDENT WILL MONITOR THE CONDITION OF ALL THE DEVICES, CLEAN AND REPLACE STRUCTURES AS CLIMATIC CONDITIONS REQUIRE, THE DEVELOPER WILL ALSO BE SUBJECT TO THE DIRECTIVE OF THE DESIGN ENGINEER AND TOWN REPRESENTATIVES TO INCLUDE TOWN ENGINEER, HIGHWAY SUPERINTENDENT AND BUILDING

2. GENERAL CONTRACTOR AND ALL CONTRACTORS SHALL PERFORM ALL WORK IN ACCORDANCE WITH THE

- APPROVED PLANS AND MAY BE SUBJECT TO ADDITIONAL EROSION CONTROL REQUIREMENTS AS CONDITIONS MAY ARISE IN THE FIELD OR AS DIRECTED BY THE DESIGN ENGINEER. THE CONTRACTOR SHALL MAINTAIN ALL EROSION CONTROL DEVICES IN ACCORDANCE WITH THE APPROVED PLANS. MANUFACTURER'S RECOMMENDATIONS, AS DIRECTED BY THE DESIGN ENGINEER AND TOWN REPRESENTATIVES
- INCLUDING TOWN ENGINEER, HIGHWAY SUPERINTENDENT AND BUILDING INSPECTOR. 4. NO EROSION CONTROL STRUCTURES SHALL BE REMOVED UNTIL ALL WORK UPSTREAM THEREFROM HAS BEEN COMPLETED, INCLUDING STABILIZATION AND APPROVED BY THE DESIGN ENGINEER AND TOWN REPRESENTATIVES.
- CONSTRUCTION ACTIVITIES TO BE LIMITED TO THE PERIOD OF 7:00 AM TO 7:00 PM. 5. ALL CONSTRUCTION EQUIPMENT SHALL HAVE PROPERLY SIZED MAINTAINED MUFFLERS. 7. ALL CONSTRUCTION EQUIPMENT SHALL BE TURNED OFF WHEN NOT IN USE.

<u>SLOPE STABILIZATION, SEEDING METHOD & MULCHING</u>

- SLOPES SHALL BE HYDROSEEDED WITH THE MIXTURES AND RATES INDICATED IN THE PERMANENT SEEDING MIXTURE SCHEDULE. STRAW OR HAY MULCH SHALL BE APPLIED AT A RATE OF 2000 LBS/ACRE. STRAW OR HAY MULCH SHALL BE ANCHORED WITH BIOD-Mesh60 NETTING AS MANUFACTURED BY ROLÁNKA INTERNATIONAL OR APPROVED EQUIVALENT. NETTING TO BE INSTALLED PER MANUFACTURER SPECIFICATIONS
- GENTLE SLOPES AND FLAT AREAS

 AREAS SHALL BE SEEDED BY HYDROSEEDING OR BROADCASTING WITH THE MIXTURES AND RATES INDICATED ON THE PERMANENT SEEDING MIXTURE AND RATES INDICATED ON THE PERMANENT SEEDING MIXTURE SCHEDULE. HYDROSEEDED AREAS SHALL BE MULCHED WITH A WOOD FIBER MULCH APPLIED AT A RATE OF 500 LBS/ACRES. BROADCAST AREAS SHALL BE MULCHED WITH HAY OR STRAW AT A RATE OF 2000 LBS/ACRE. AREAS SEEDED BY BROADCASTING SHALL BE LIGHTLY RAKED AND PACKED PRIOR TO PLACING MULCH.

STREAMS, DRAINAGE SWALES AND EMBANKMENTS

WITH TEMPORARY EROSIION CONTROL STRUCTURES AS SHOWN IN DETAIL, LOCATED IMMEDIATELY DOWNSTREAM FROM SUCH ACTIVITY. THESE STRUCTURES ARE TO BE IN PLACE AS SHOWN PRIOR TO THE START OF ANY UPSTREAM CONSTRUCTION ACTIVITY. CONSTRUCTION EQUIPMENT SHALL NOT UNNECESSARILY CROSS LIVE STREAMS OR DRAINAGE SWALES EXCEPT BY

1. ALL CONSTRUCTION ACTIVITIES IN OR EXISTING AROUND DRAINAGE SWALES OR WETLANDS ARE TO BE PROVIDED.

- MEANS OF BRIDGES AND CULVERTS OR OTHER APPROVED METHODS.
- ALL EMBANKMENTS TO BE GRADED AND SEEDED IMMEDIATELY UPON BEING LAID BACK . STABILIZATION OF THE SWALES WILL INCLUDE SEEDING AND STRAW MULCH ON SLOPES LESS THAN 5% AND
- JUTE NETTING OR EQUAL ON SLOPES EXCEEDING 5%. TOPSOIL AND/OR EARTH STOCKPILE SHALL BE LOCATED OUTSIDE OF EXISTING DRAINAGE SWALES, WETLANDS AND ADJACENT AREAS. SILT FENCE WILL BE PLACED ALONG THE TOE OF THE PILES AND PILES SHALL RECEIVE

SOIL RESTORATION NOTE:

TEMPORARY SEEDING.

TO INCREASE INFILTRATION OF STORM WATER AND IMPROVE DIRECT GROUNDWATER RECHARGE FROM RAIN EVENTS, SOIL RESTORATION PRACTICES, AS OUTLINED IN CHAPTER 5.1.6 OF THE NEW YORK STATE STORMWATER MANAGEMENT DESIGN MANUAL, SHOULD BE APPLIED TO THE SITE. AERATION AND DEEP RIPPING PROCEDURES SHALL BE AS DESCRIBED IN APPENDIX 8 OF SWPPP, AND SHALL BE APPLIED TO ALL FLAT TO MODERATELY SLOPED AREAS OF SOIL DISTURBANCE WHICH ARE PROPOSED TO REMAIN PERVIOUS.

SEEDBED PREPARATION & AMENDMENTS

MODERATE TO STEEP SLOPES AND LOW MAINTENANCE AREAS

-SCARIFY SOIL TO DEPTH OF 4" TO 6" IF COMPACTED.

-REMOVED LARGE STONES AND STUMPS ALLOWING ROCKS, ROOTS

CLODS AND OTHER NATURAL DEBRIS TO REMAIN. -ROUGHEN SLOPE FACES BY MAKING GROVES 2"-3" DEEP, PERPENDICULAR

TO THE SLOPE WITH DISK OR YORK RAKE.

-LIME AS REQUIRED TO ACHIEVE A pH OF 6.0.

-FERTILIZE AT A RATE OF 600 LBS/ACRE OF 5-10-10 FERTILIZER OR

AS RECOMMENDED BY SOIL TESTS.

-INCORPORATE LIME AND FERTILIZER INTO TOP 4" OF SOIL BY ROUGHENING.

GENERAL RECREATION AREAS AND LAWNS

-PLACE TOPSOIL TO A MINIMUM DEPTH OF 4" -SCARIFY SOIL TO A DEPTH OF 4"-6" IF COMPACTED

-REMOVE ALL STONES OVER 1" IN DIAMETER, STICKS AND FOREIGN MATTER FROM THE SURFACE. -LIME AS REQUIRED TO ACHIEVE A pH OF 6.5.

-FERTILIZE AT A RATE OF 850 LBS/ACRE OF 5-10-10 OR EQUIVALENT FERTILIZER OR AS RECOMMENDED BY SOIL TESTS. -INCORPORATE LIME AND FERTILIZER INTO TOP 2"-4" OF TOPSOIL -SMOOTH AND FIRM THE SEEDBED.


TEMPORARY SEEDING SPECIFICATIONS


-SCARIFY SOILS IF COMPACTED -LIME TO pH OF 6.0 IF REQUIRED

-FERTILIZE WITH 600 LBS/ACRE 5-10-10 FERTILIZER IF REQ.. -SEED WITH SPECIES AND RATE SHOWN BELOW -MULCH WITH HAY OR STRAW AT A RATE OF 2000 LBS/ACRE. ANCHOR MULCH WITH NETTING OF WOOD FIBER OR JUTE IF

STEEP SLOPE OR HIGH POTENTIAL FOR EROSION.

APPLICATION RATE RYEGRASS (ANNUAL OR PERENNIAL) 30 LBS/ACRE (USE WINTER RYE IF SEEDING IN OCT./NOV.) (0.7 LBS/1000 SF)

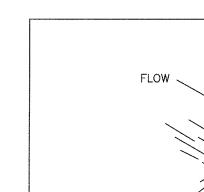

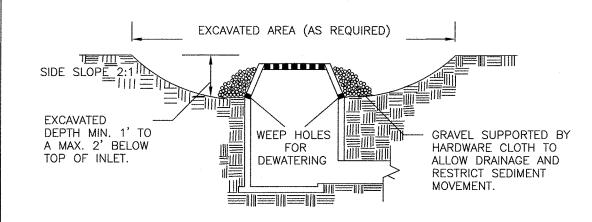


CONSTRUCTION SPECIFICATIONS

- 1. CLEAR THE AREA OF ALL DEBRIS THAT WILL HINDER EXCAVATION. 2. GRADE APPROACH TO THE INLET UNIFORMLY AROUND THE BASIN.
- 3. WEEP HOLES SHALL BE PROTECTED BY GRAVEL.
- 4. UPON STABILIZATION OF CONTRIBUTING DRAINAGE AREA, SEAL WEEP HOLES, FILL BASIN WITH STABLE SOIL TO FINAL GRADE, COMPACT IT PROPERLY AND STABILIZE WITH PERMANENT SEEDING.

MAXIMUM DRAINAGE AREA 1 ACRE

U.S. DEPARTMENT OF AGRICULTURE NATURAL RESOURCES CONSERVATION SERVICE NEW YORK STATE DEPARTMENT OF ENVIRONMENTAL CONSERVATION NEW YORK STATE SOIL & WATER CONSERVATION COMMITTEE


EXCAVATED DROP INLET PROTECTION

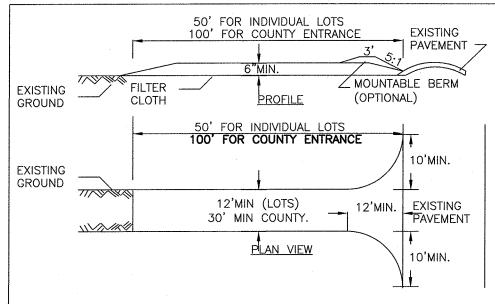

CONSTRUCTION SPECIFICATIONS

- 1. STONE SIZE USE 2" STONE, OR RECLAIMED OR RECYCLED CONCRETE EQUIVALENT. 2. LENGTH - NOT LESS THAN 50 FEET (EXCEPT ON A SINGLE RESIDENCE LOT WHERE
- A 30 FOOT MINIMUM LENGTH WOULD APPLY). 3. THICKNESS - NOT LESS THAN SIX (6) INCHES.
- 4. WIDTH TWELVE (12) FOOT MINIMUM, BUT NOT LESS THAN THE FULL WIDTH AT POINTS WHERE INGRESS OR EGRESS OCCURS. TWENTY-FOUR (24) FOOT IF SINGLE ENTRANCE TO SITE.
- 5. FILTER CLOTH WILL BE PLACED OVER THE ENTIRE AREA PRIOR TO PLACING
- 6. SURFACE WATER ALL SURFACE WATER FLOWING OR DIVERTED TOWARD CON-STRUCTION ENTRANCES SHALL BE PIPED ACROSS THE ENTRANCE. IF PIPING IS IMPRACTICAL, A MOUNTABLE BERM WITH 5:1 SLOPES WILL BE PERMITTED.
- . MAINTENANCE THE ENTRANCE SHALL BE MAINTAINED IN A CONDITION WHICH WILL PREVENT TRACKING OR FLOWING OF SEDIMENT ONTO PUBLIC RIGHTS-OF-WAY, ALL SEDIMENT SPILLED, DROPPED, WASHED OR TRACTED ONTO PUBLIC RIGHTS-OF-WAY
- 8. WHEN WASHING IS REQUIRED, IT SHALL BE DONE ON A AREA STABILIZED WITH
- STONE AND WHICH DRAINS INTO AN APPROVED SEDIMENT TRAPPING DEVICE. 9. PERIODIC INSPECTION AND NEEDED MAINTENANCE SHALL BE PROVIDED AFTER EACH

U.S. DEPARTMENT OF AGRICULTURE STABILIZED NATURAL RESOURCES CONSERVATION SERVICE CONSTRUCTION NEW YORK STATE DEPARTMENT OF ENVIRONMENTAL CONSERVATION NEW YORK STATE SOIL & WATER CONSERVATION COMMITTEE ENTRANCE

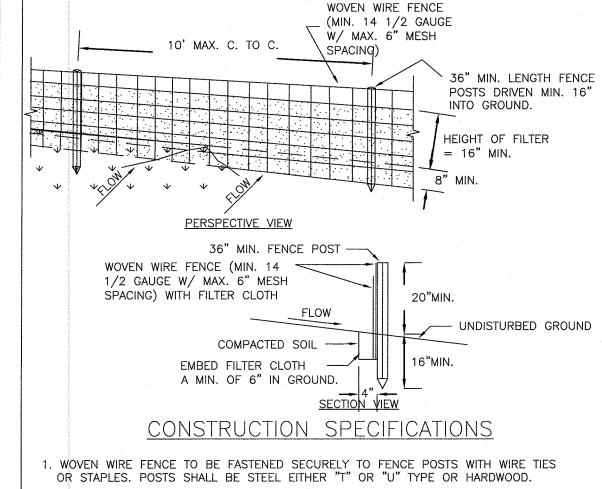

2. FILTER CLOTH TO BE TO BE FASTENED SECURELY TO WOVEN WIRE FENCE WITH TIES SPACED EVERY 24" AT TOP AND MID SECTION. FENCE SHALL BE WOVEN WIRE, 12 1/2 GAUGE, 6" MAXIMUM MESH OPENING.

. WHEN TWO SECTIONS OF FILTER CLOTH ADJOIN EACH OTHER THEY SHALL BE OVER-LAPPED BY SIX INCHES AND FOLDED. FILTER CLOTH SHALL BE EITHER FILTER X, MIRAFI 100X, STABILINKA T140N, OR APPROVED EQUIVALENT.


4. PREFABRICATED UNITS SHALL BE GEOFAB, ENVIROFENCE, OR APPROVED EQUIVALENT. MAINTENANCE SHALL BE PERFORMED AS NEEDED AND MATERIAL REMOVED WHEN "BULGES" DEVELOP IN THE SILT FENCE.

U.S. DEPARTMENT OF AGRICULTURE NATURAL RESOURCES CONSERVATION SERVICE SILT FENCE NEW YORK STATE DEPARTMENT OF ENVIRONMENTAL CONSERVATION NEW YORK STATE SOIL & WATER CONSERVATION COMMITTEE

SPILLWAY CREST TOP ELEV. ____ FREEBOARD 1' MIN. →=""=""=""="" - ELEV. ____ RISER INVFRT 2' MIN. ANTI-FLOTATION-CUTOFF-BLOCK TRENCH 4' MIN. DIAM. OF PRINCIPAL - ANTI-SEEP STABILIZED -SPILLWAY BARREL COLLAR PRINCIPAL SPILLWAY PROFILE MAXIMUM DRAINAGE AREA = 100 ACRES BOTTOM WIDTH FLOOD POOL TOP OF DAM FREEBOARD 1' MIN. __ ELEV. ____ APPROACH EXIT SECTION — BERM LEVEL SECTION - EXIT SECTION -20'MINIMUM **EMBANKMENT** PROFILE ALONG C <u>OF SPILLWAY</u> BOTTOM WIDTH 3 MIN. <u>SPILLWAY PLAN VIEW</u> UTILIZE PROPOSED DETENTION CONTROL SECTION POND FOR SEDIMENT BASIN. SEDIMENT BASIN SIZE TABLE DRAINAGE | REQUIRED VOLUME | REQUIRED | PROVIDED PER TRIB ACRE | BASIN VOLUME | BASIN VOLUME BASIN # AREA (ACRE) (CU.FT.) (CU.FT.) (CU.FT.) 3,600 40,716 216,640 POND U.S. DEPARTMENT OF AGRICULTUR

NATURAL RESOURCES CONSERVATION SERVICE NEW YORK STATE DEPARTMENT OF ENVIRONMENTAL CONSERVATION NEW YORK STATE SOIL & WATER CONSERVATION COMMITTEE


SEDIMENT BASIN DETAILS

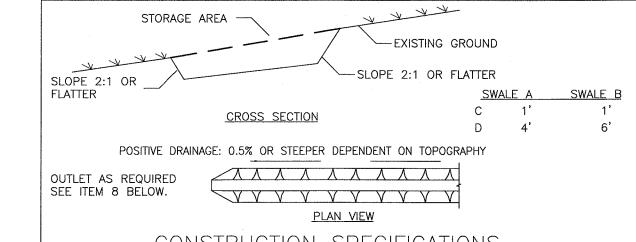


CONSTRUCTION SPECIFICATIONS

- 1. ALL TEMPORARY SWALES SHALL HAVE UNINTERUPTED POSITIVE GRADE TO AN OUTLET. 2. DIVERTED RUNOFF FROM A DISTURBED AREA SHALL BE CONVEYED TO A SEDIMENT
- 5. DIVERTED RUNOFF FROM AN UNDISTURBED AREA SHALL OUTLET DIRECTLY INTO AN UNDISTURBED STABILIZED AREA AT NON-EROSIVE VELOCITY.
- 4. ALL TREES, BRUSH, STUMPS, OBSTRUCTIONS, AND OTHER OBJECTIONABLE MATERIAL SHALL BE REMOVED AND DISPOSED OF SO AS NOT TO INTERFERE WITH THE PROPER FUNCTIONING OF THE SWALE.
- 5. THE SWALE SHALL BE EXCAVATED OR SHAPED TO LINE, GRADE, AND CROSS SECTION AS REQUIRED TO MEET THE CRITERIA SPECIFIED HEREIN AND BE FREE OF BANK PROJECTIONS OR OTHER IRREGULARITIES WHICH WILL IMPEDE NORMAL FLOW.
- 6. FILLS SHALL BE COMPACTED BY EARTH MOVING EQUIPMENT. 7. ALL EARTH REMOVED AND NOT NEEDED FOR CONSTRUCTION SHALL BE PLACED SO THAT IT WILL NOT INTERFERE WITH THE FUNCTIONING OF THE SWALE.
- 8. STABILIZATION SHALL BE AS PER THE FLOW CHANNEL STABILIZATION CHART BELOW: A(5 AC. OR LESS) TREATMENT GRADE B(5 AC -10AC)
- SEED AND STRAW MULCH 0.5 - 3.0%SEED AND STRAW MULCH 3.1-5.0% SEED AND STRAW MULCH SEED USING JUTE OR EXCELSIOR 5.1-8.0% SEED WITH JUTE OR EXCELSIOR, SOD LINED WITH 4-8" RIP-RAP OR RECYCLED CONCRETE EQUIVALENT 8.1-20.% LINED WITH 4-8" RIP-RAP ENGINEERED DESIGN
- . PERIODIC INSPECTION AND REQUIRED MAINTENANCE MUST BE PROVIDED AFTER EACH RAIN FVENT

U.S. DEPARTMENT OF AGRICULTURE **TEMPORARY** NATURAL RESOURCES CONSERVATION SERVICE NEW YORK STATE DEPARTMENT OF ENVIRONMENTAL CONSERVATION SWALE NEW YORK STATE SOIL & WATER CONSERVATION COMMITTEE

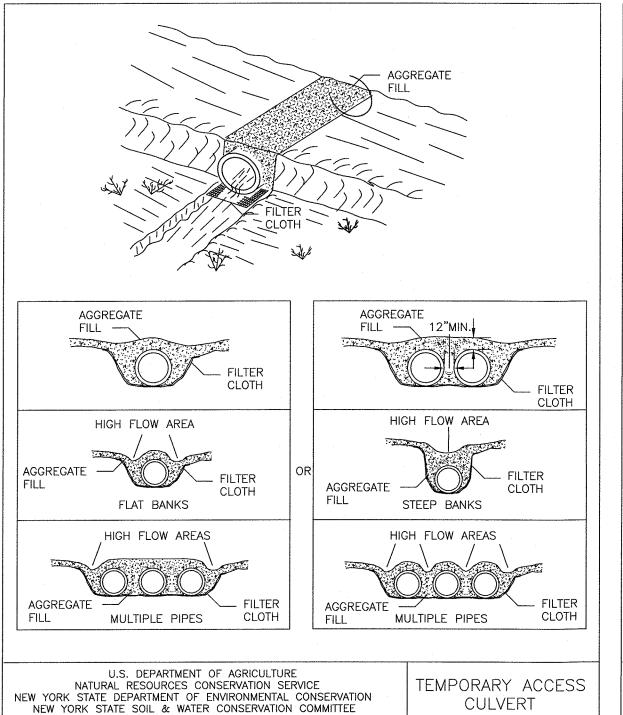

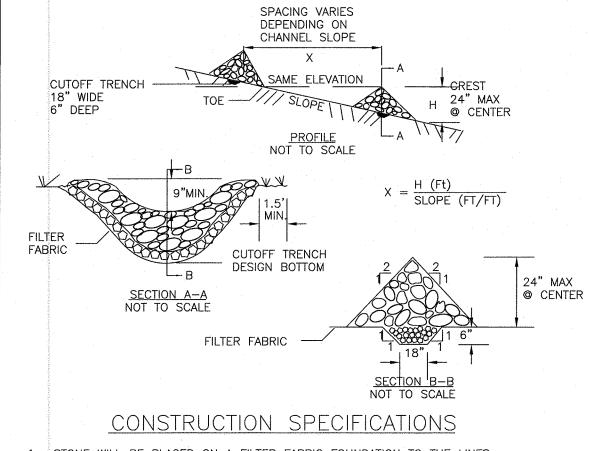

1. STONE WILL BE PLACED ON A FILTER FABRIC FOUNDATION TO THE LINES, GRADES AND LOCATIONS SHOWN IN THE PLAN.

2. SET SPACING OF CHECK DAMS TO ASSUME THAT THE ELEVATIONS OF THE CREST OF THE DOWNSTREAM DAM IS AT THE SAME ELEVATION OF THE TOE OF THE UPSTREAM DAM 3. EXTEND THE STONE A MINIMUM OF 1.5 FEET BEYOND THE DITCH BANKS TO

PREVENT CUTTING AROUND THE DAM.

PROTECT THE CHANNEL DOWNSTREAM OF THE LOWEST CHECK DAM FROM SCOUR SAND EROSION WITH STONE OR LINER AS APPROPRIATE. ENSURE THAT CHANNEL APPURTENANCES SUCH AS CULVERT ENTRANCES BELOW

CHECK DAMS ARE NOT SUBJECT TO DAMAGE OR BLOCKAGE FROM DISPLACED STONE.

MAXIMUM DRAINAGE AREA 2 ACRES. U.S. DEPARTMENT OF AGRICULTURE NATURAL RESOURCES CONSERVATION SERVICE NEW YORK STATE DEPARTMENT OF ENVIRONMENTAL CONSERVATION NEW YORK STATE SOIL & WATER CONSERVATION COMMITTEE

CHECK DAM


THIS SHEET IS NOT FOR ORANGE

COUNTY HEALTH DEPARTMENT

REVIEW OR APPROVAL

RESERVED FOR TOWN PLANNING BOARD APPROVAL

ORANGE COUNTY DEPARTMENT OF PUBLIC WORKS NOTE: NO SITE PREPARATION OR CONSTRUCTION, INCLUDING UTILITY CONNECTIONS, SHALL COMMENCE UNTIL A VALID HIGHWAY WORK PERMIT HAS BEEN SECURED FROM THE ORANGE COUNTY DEPARTMENT OF PUBLIC WORKS UNDER SECTION 136 OF THE HIGHWAY LAW. 106-28-16 REVISIONS AS PER O.C.H.D. COMMENT LETTER NR 03-28-16 O.C.H.D. PREPARATION DATE 01-21-16 REVISIONS AS PER 9/2 COMMENT LETTER 08-17-15 REVISIONS AS PER O.C.D.P.W. LETTER NR 06-01-15 REVISIONS AS PER O.C.D.P.W. LETTER 12-15-14 REVISIONS AS PER 12/2 COMMENT LETTER NR 11-18-14 REVISIONS AS PER 10/9 COMMENT LETTER NR 10-01-14 DESIGN PREPARATION DATE NR 12-05-13 CLUSTER SKETCH PLAN PREPARATION DATE DESCRIPTION INITIALS REVISIONS MAP CHECK DATE: 03-31-16 | INITIALED BY: NR

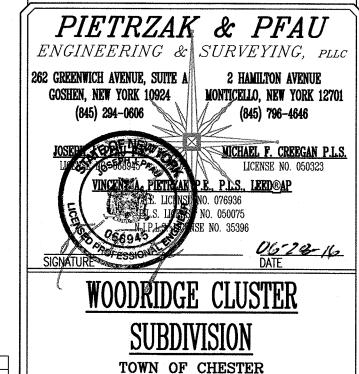

COUNTY OF ORANGE, NEW YORK EROSION CONTROL

<u>DETAILS</u> SECTION 8 BLOCK 1 LOT 50.2 UNAUTHORIZED ALTERATION OR ADDITION TO A PLAN BEARING A LICENSED

LAND SURVEYOR'S OR PROFESSIONAL ENGINEER'S SFAL IS A VIOLATION OF SECTION 7209, SUB-DIVISION 2 OF THE N.Y. STATE EDUCATION LAW. O.C.H.D. SHEET NO. | D.E.C. SHEET NO. | DRAWING NUMBER N/A OF 6 N/A OF ____ __10__0F__15_ CAD REFERENCE | PROJECT NUMBER NO SCALE | 14102 ENG BASE | 14102.01

PERMANENT SEEDING MIXTURES

MODERATE TO STEEP SLOPES AND LOW MAINTENANCE AREAS APPLICATION RATE <u>SPECIES</u>

8 LBS/ACRE EMPIRE BIRDSFOOT TREFOIL TALL FESCUE 20 LBS/ACRE RYEGRASS 5 LBS/ACRE

GENERAL RECREATION AREAS AND LAWNS

APPLICATION RATE SUNNY SITES (WELL, MODERATELY WELL AND SOMEWHAT POORLY DRAINED SOILS)

65% KENTUCKY BLUEGRASS BLEND 85-114 LBS/ACRE 20% PERENNIAL RYEGRASS 26-35 LBS/ACRE 19-26 LBS/ACRE 15% FINE FESCUE

SUNNY DROUGHTY SITES (SOMEWHAT EXCESSIVELY TO EXCESSIVELY DRAINED SOILS)


65% FINE FESCUE 114-143 LBS/ACRE 15% PERENNIAL RYEGRASS 26-33 LBS/ACRE 20% KENTUCKY BLUEGRASS BLEND 35-44 LBS/ACRE

SHADY DRY SITES (WELL TO SOMEWHAT POORLY DRAINED SOILS)


80% SHADE TOLERANT KENTUCKY 105-138 LBS/ACRE BLUEGRASS BLEND 20% PERENNIAL RYEGRASS 25-37 LBS/ACRE


SHADY WET SITES (SOMEWHAT POOR TO POORLY DRAINED SOILS)

60-91 LBS/ACRE 70% ROUGH BLUFGRASS 80% SHADE TOLERANT KENTUCKY 25-39 LBS/ACRE BLUEGRASS BLEND

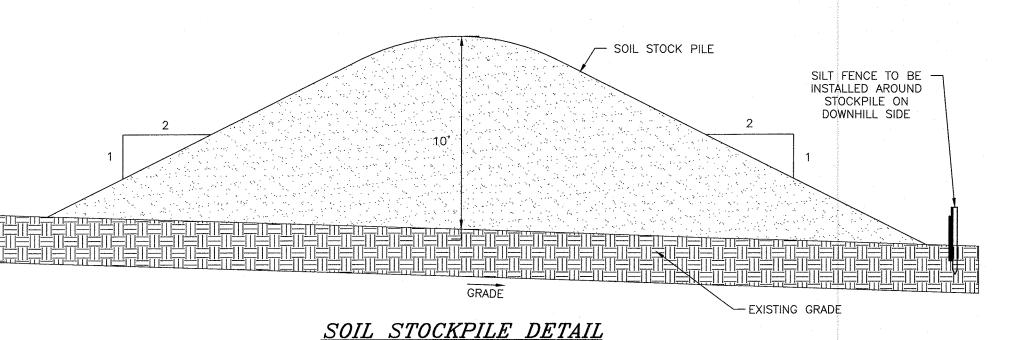

SOIL STOCKPILE DETAIL

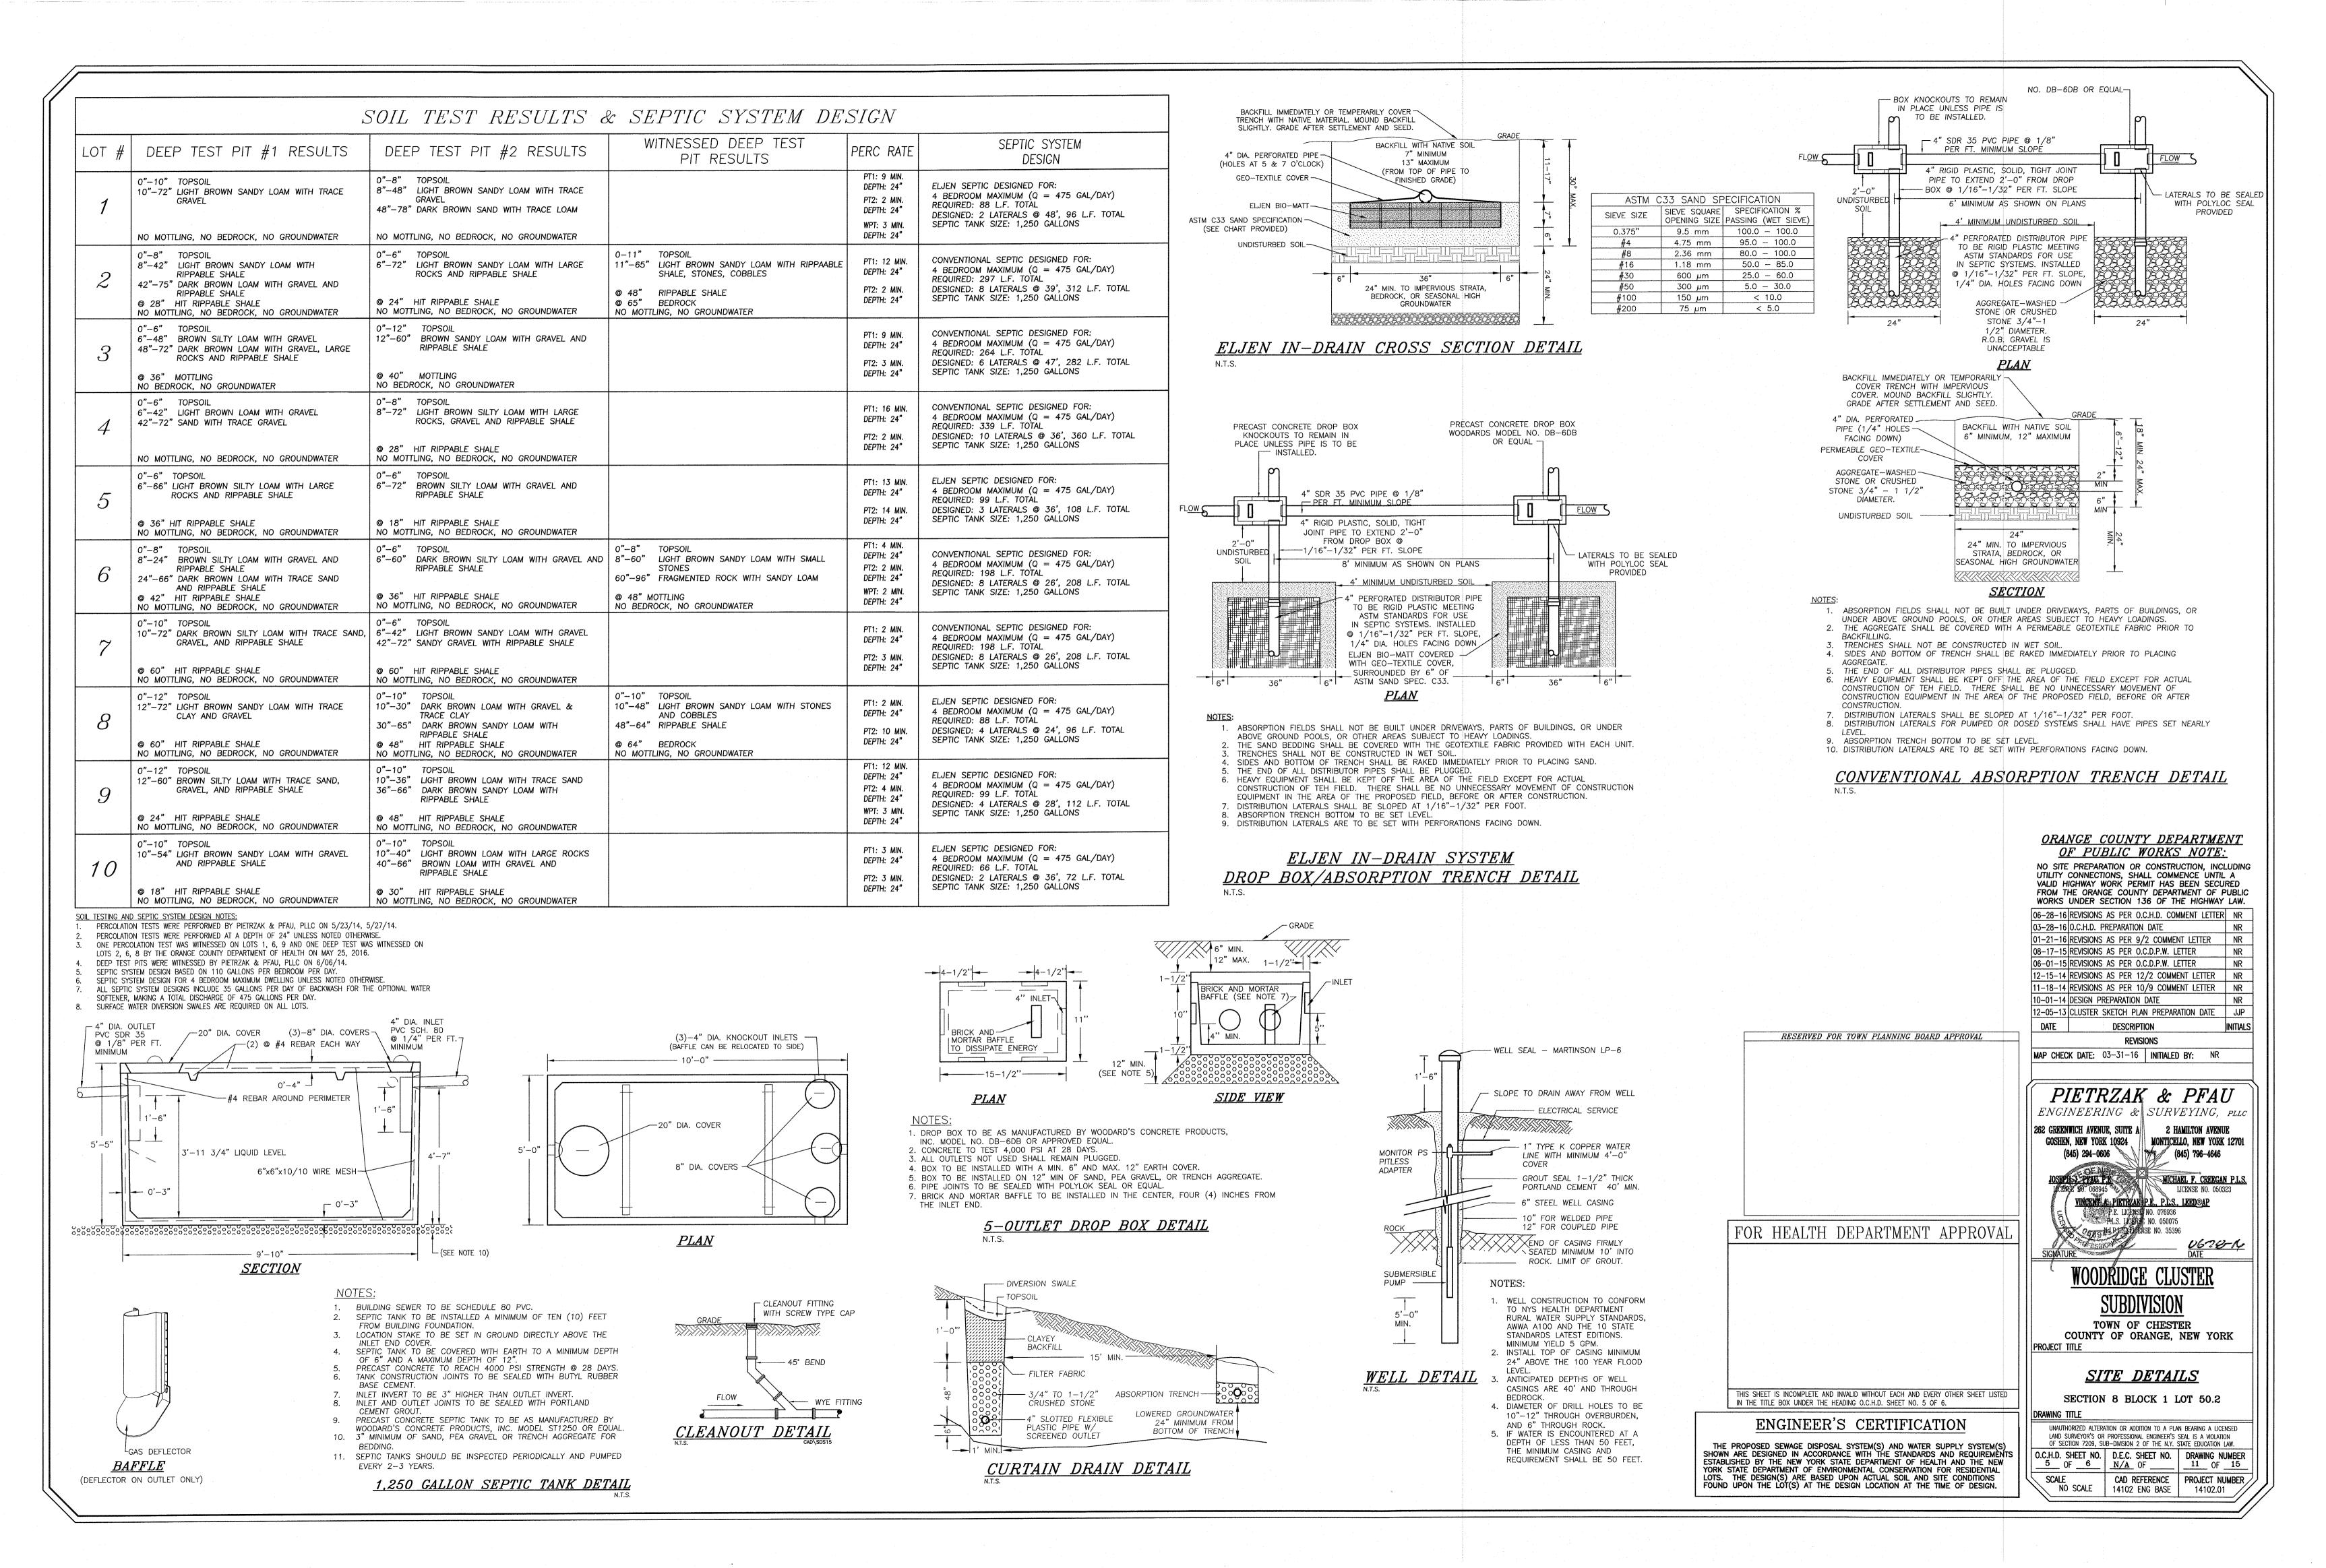

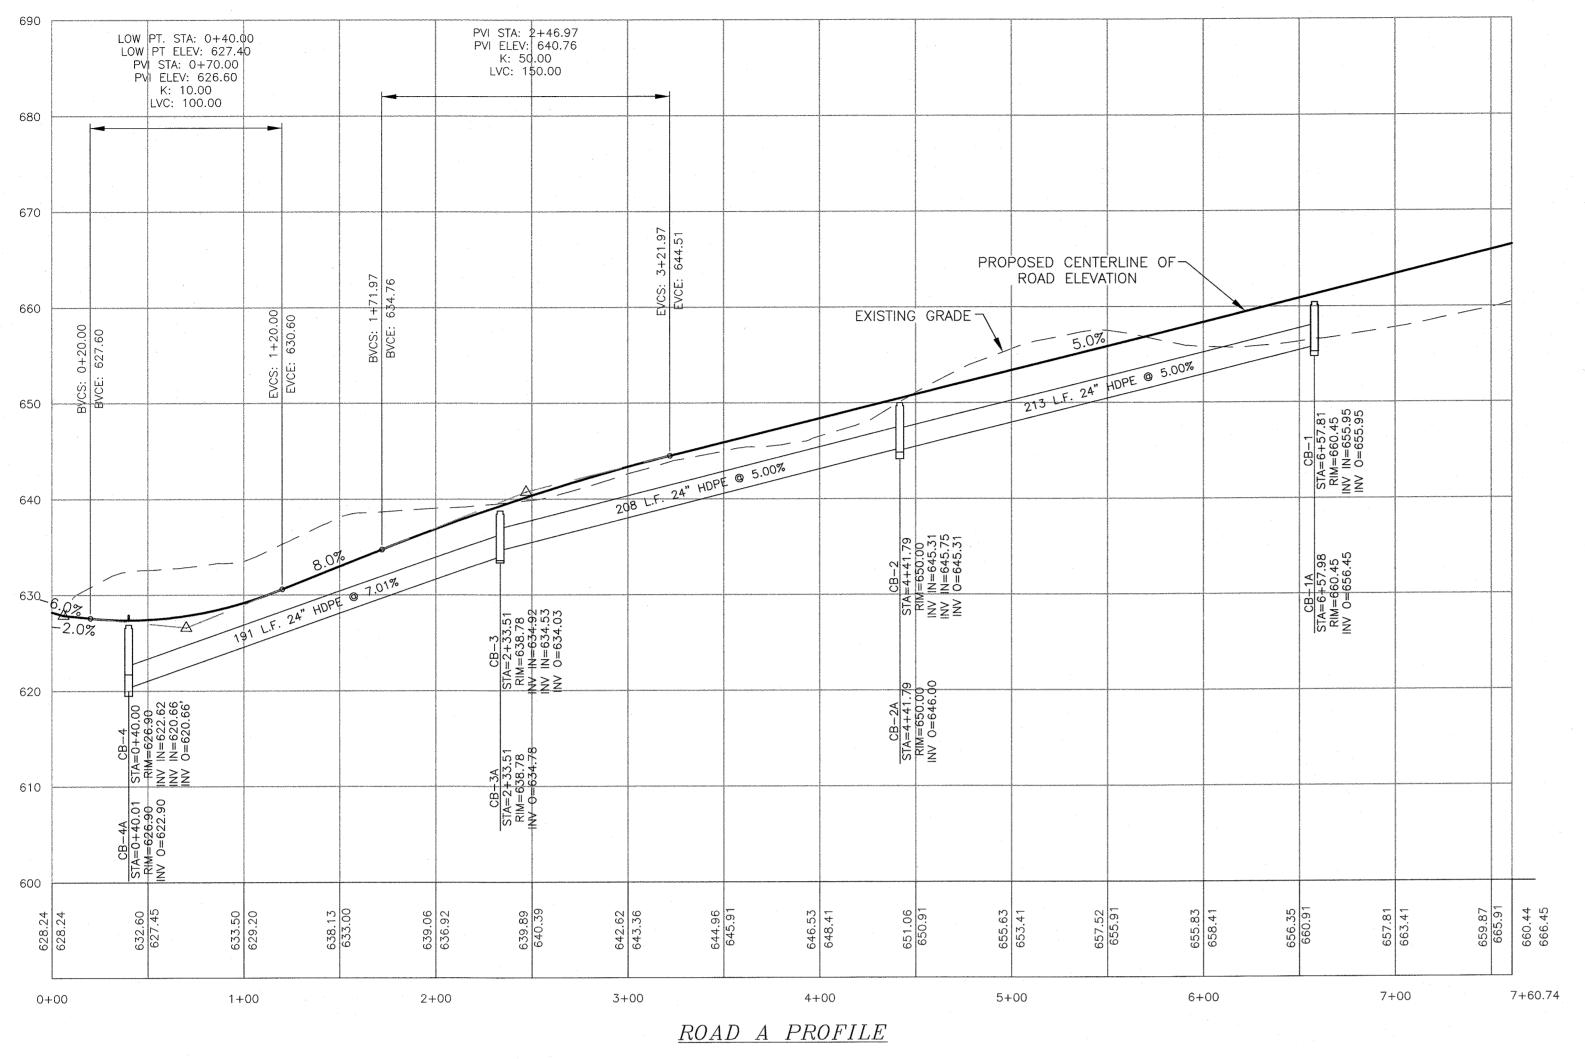

PROPERTY LINE (TYP.) 15' MIN. (INTERIOR SUBDIVISION LINE) 50' MIN. (EXTERIOR SUBDIVISION LINÉ) — 100' MIN. (WELL UPHILL OF SDS) 200' MIN. (WELL DOWNHILL OF SDS) HOUSE __/ 50% EXPANSION CURTAIN DRAIN (RUN TO DAYLIGHT WITH SCREEN STREET TYPICAL SEPARATION DISTANCE REQUIREMENTS GENERAL NOTES - SEWAGE SYSTEMS

1. SEPTIC SYSTEMS TO CONFORM TO THE MINIMUM REQUIREMENTS OF THE N.Y.S. HEALTH DEPARTMENT STANDARDS/CODES FOR INDIVIDUAL DISPOSAL SYSTEMS,

APPENDIX 75-A, AND THE AUTHORITY HAVING JURISDICTION. 2. THE SANITARY FACILITIES ON THESE PLANS SHALL BE INSPECTED FOR COMPLIANCE, WITH THE APPROVED PLANS, AT THE TIME OF CONSTRUCTION, BY A LICENSED PROFESSIONAL ENGINEER. WRITTEN CERTIFICATION TO THAT EFFECT SHALL BE SUBMITTED TO THE COUNTY HEALTH DEPARTMENT AND THE LOCAL BUILDING CODE ENFORCEMENT OFFICER PRIOR TO OCCUPANCY, AND SHALL INDICATE THAT ANY JOINTS HAVE BEEN SEALED AND TESTED FOR WATER TIGHTNESS AND THAT THE TANK IS INSTALLED IN ACCORDANCE WITH APPENDIX

75-A AND THE MANUFACTURERS INSTRUCTIONS. 3. SEPTIC FIELDS AND WELLS SHALL NOT BE RELOCATED.

4. ALL PERCOLATION TESTS TAKEN AT 24" - 30" UNLESS OTHERWISE NOTED. 5. SEPTIC SYSTEM DESIGNS ARE BASED ON THE SLOWEST PERCOLATION RATE FOUND WITHIN THE AREA OF THE SYSTEM.

6. LAUNDRY WASTE IS TO BE DISCHARGED INTO THE SEPTIC SYSTEM. 7. HOUSE SEWER AND SEWER RUNS SHALL NOT EXCEED 75' BETWEEN POINTS OF POSSIBLE CLEANOUT, AT LEAST ONE CLEANOUT IS TO BE PROVIDED. BENDS ARE TO BE AVOIDED BUT WHERE REQUIRED AN ADDITIONAL CLEANOUT SHALL BE

8. THE MAXIMUM LENGTH OF ABSORPTION LINES USED IN CONJUNCTION WITH GRAVITY DISTRIBUTION SHALL BE 60 FEET.

9. FOOTING DRAINS ARE NOT TO DISCHARGE INTO THE SEPTIC SYSTEM. FOOTING DRAINS ARE TO RUN TO DAYLIGHT WITH RODENT SCREEN.

10. UNLESS OTHERWISE INDICATED ON THESE PLANS, INDIVIDUAL SEPTIC TANKS ARE NOT DESIGNED TO ACCOMMODATE GARBAGE GRINDERS.

11. TRENCHES SHALL NOT BE CONSTRUCTED IN WET SOILS. 12. SIDES AND BOTTOM OF TRENCHES SHALL BE RAKED IMMEDIATELY PRIOR TO

PLACING SAND. 13. THE END OF ALL DISTRIBUTOR PIPES SHALL BE PLUGGED.

14. HEAVY EQUIPMENT SHALL BE KEPT OFF THE AREA OF THE TILE FIELD EXCEPT FOR THE ACTUAL CONSTRUCTION OF THE FIELD. THERE SHALL BE NO UNNECESSARY MOVEMENT OF CONSTRUCTION EQUIPMENT IN THE AREA OF THE PROPOSED FIELD BEFORE, DURING AND AFTER CONSTRUCTION. EXTREME CARE MUST BE TAKEN DURING THE ACTUAL CONSTRUCTION SO AS TO AVOID ANY UNDUE COMPACTION THAT COULD RESULT IN A CHANGE OF THE ABSORPTION

CAPACITY OF THE SOIL ON WHICH THE DESIGN WAS BASED. 15. THERE IS NO REGRADING ALLOWED IN THE AREA OF THE ABSORPTION FIELD.

16. NO SWIMMING POOLS, DRIVEWAYS, OR STRUCTURES WHICH MAY COMPACT THE SOIL SHALL BE LOCATED OVER ANY PORTION OF THE ABSORPTION FIELD 17. THIS SYSTEM WAS NOT DESIGNED TO ACCOMMODATE GARBAGE GRINDERS, OR "JACUZZI" TYPE SPA TUBS OVER 100 GALLONS. AS SUCH, THESE ITEMS SHALL NOT BE INSTALLED UNLESS THE SDS IS REDESIGNED TO ACCOUNT FOR THEM

AND REAPPROVED BY THE ORANGE COUNTY DEPARTMENT OF HEALTH. 18. THERE MUST BE AN UNINTERRUPTED POSITIVE SLOPE FROM THE SEPTIC TANK (OR ANY PUMPING OR DOSING CHAMBER) TO THE HOUSE, ALLOWING SEPTIC GASES TO DISCHARGE THROUGH THE STACK VENT.

GENERAL NOTES - WATER SYSTEMS

1. WELL CONSTRUCTION SHALL CONFORM TO THE MINIMUM REQUIREMENTS OF THE N.Y.S. HEALTH DEPARTMENT STANDARDS.

2. TREATMENT FOR HARDNESS SHOULD BE CONSIDERED ONLY IF EXCESSIVE HARDNESS IS FOUND (GREATER THAN 150 MG/L).

3. THE DESIGN AND LOCATION OF SANITARY FACILITIES (WATER AND SEWER SYSTEMS) SHALL NOT BE CHANGED.

4. FOOTING DRAINS WITHIN 25 FEET OF A WELL MUST BE WATERTIGHT. 5. WELLS ARE TO BE INSTALLED 100 FEET FROM ANY SEPTIC SYSTEM, AND 200 FEET FROM

ANY SEPTIC SYSTEM UPHILL FROM THE WELL 6. WELL CASING IS TO BE INSTALLED 10 FEET INTO IMPERVIOUS BEDROCK.

7. NEW YORK STATE SANITARY CODE, PART 5, APPENDIX 5-B REQUIRES A 50% INCREASE IN SEPARATION DISTANCES OR 50' MINIMUM WELL CASING IF AQUIFER WATER ENTERS THE WELL LESS THAN 50' BELOW GRADE.

SCALE:

HORIZONTAL: 1" = 50

VERTICAL: 1" = 10

1. HEAVY DUTY CURB TYPE CATCH BASIN

FRAME AND GRATE TO BE CAMPBELL

2. PRECAST CONCRETE TO BE 4000 PSI AT

28 DAYS W/ 6"X6"X6" W.W. MESH

REINFORCEMENT

VARIES

MANHOLE STEP

PRECAST CONCRETE CURB INLET DETAIL

PLAN

∠ TOP OF PIPE TO BE SAME

EL. WHERE INLET IS

FRONT ELEVATION

(AS REQUIRED) ,

SMALLER THAN OUTLET


INLET


- TOP OF CURB

FOUNDRY NO. 2541 & 2548 AS REQUIRED


CRUSHED STONE

SECTION

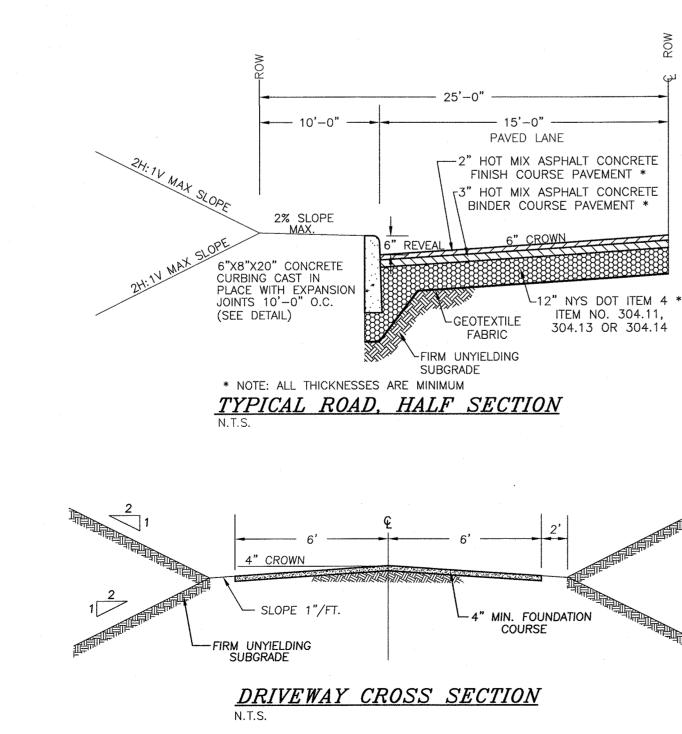

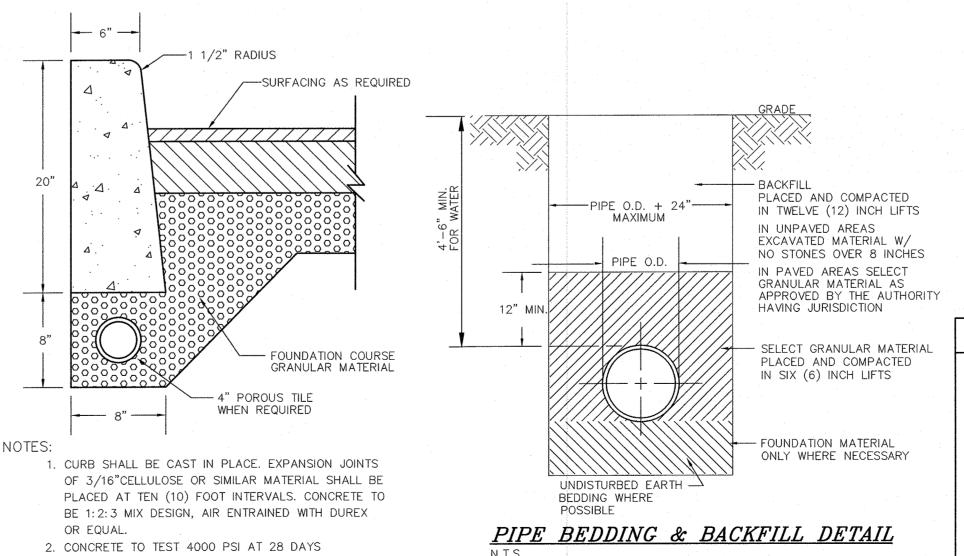

CONCRETE CURB DETAIL

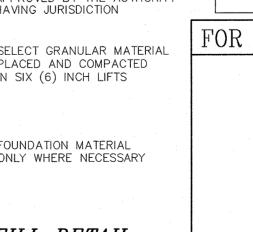


ENGINEER'S CERTIFICATION

IN THE TITLE BOX UNDER THE HEADING O.C.H.D. SHEET NO. 6 OF 6.

THIS SHEET IS INCOMPLETE AND INVALID WITHOUT EACH AND EVERY OTHER SHEET LISTED

THE PROPOSED SEWAGE DISPOSAL SYSTEM(S) AND WATER SUPPLY SYSTEM(S) SHOWN ARE DESIGNED IN ACCORDANCE WITH THE STANDARDS AND REQUIREMENTS ESTABLISHED BY THE NEW YORK STATE DEPARTMENT OF HEALTH AND THE NEW YORK STATE DEPARTMENT OF ENVIRONMENTAL CONSERVATION FOR RESIDENTIAL LOTS. THE DESIGN(S) ARE BASED UPON ACTUAL SOIL AND SITE CONDITIONS FOUND UPON THE LOT(S) AT THE DESIGN LOCATION AT THE TIME OF DESIGN.

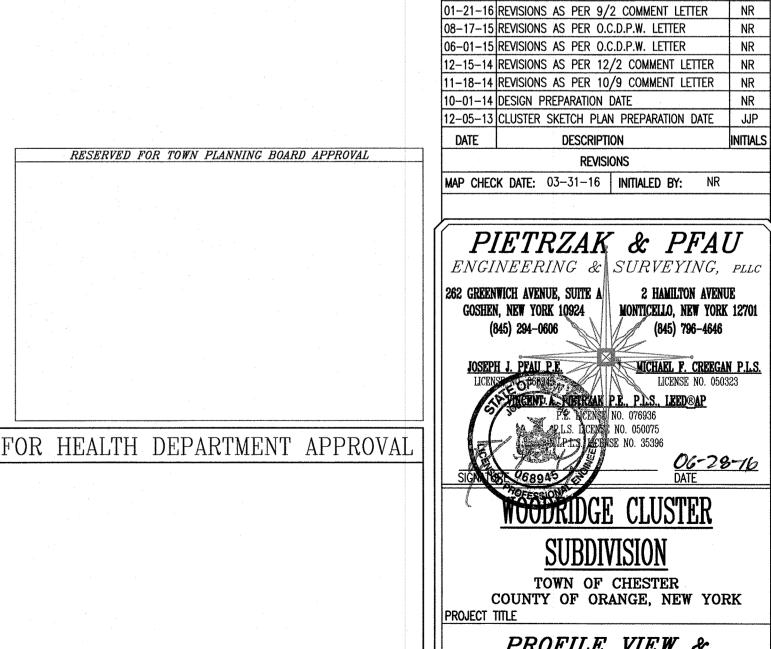

PROFILE VIEW & SITE DETAILS SECTION 8 BLOCK 1 LOT 50.2

ORANGE COUNTY DEPARTMENT

OF PUBLIC WORKS NOTE:

NO SITE PREPARATION OR CONSTRUCTION, INCLUDING UTILITY CONNECTIONS, SHALL COMMENCE UNTIL A VALID HIGHWAY WORK PERMIT HAS BEEN SECURED FROM THE ORANGE COUNTY DEPARTMENT OF PUBLIC

WORKS UNDER SECTION 136 OF THE HIGHWAY LAW.

06-28-16 REVISIONS AS PER O.C.H.D. COMMENT LETTER NR


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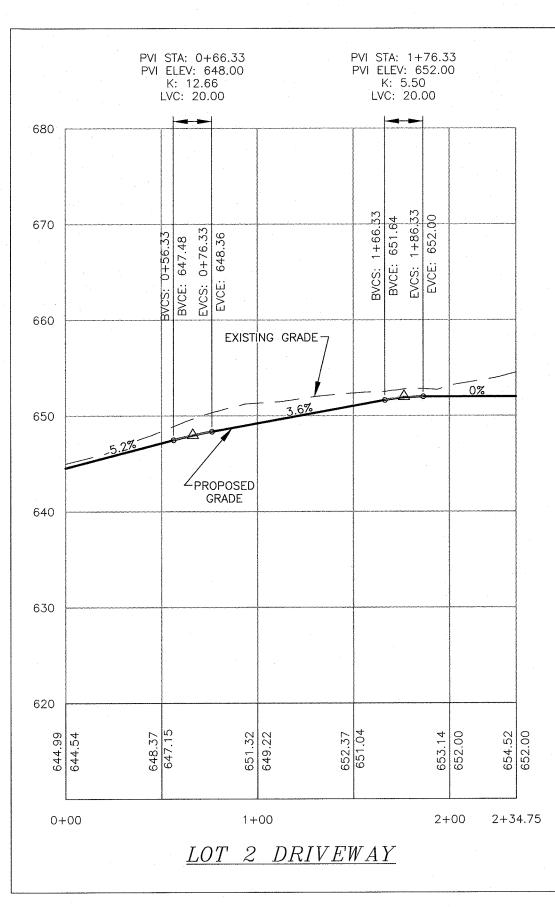
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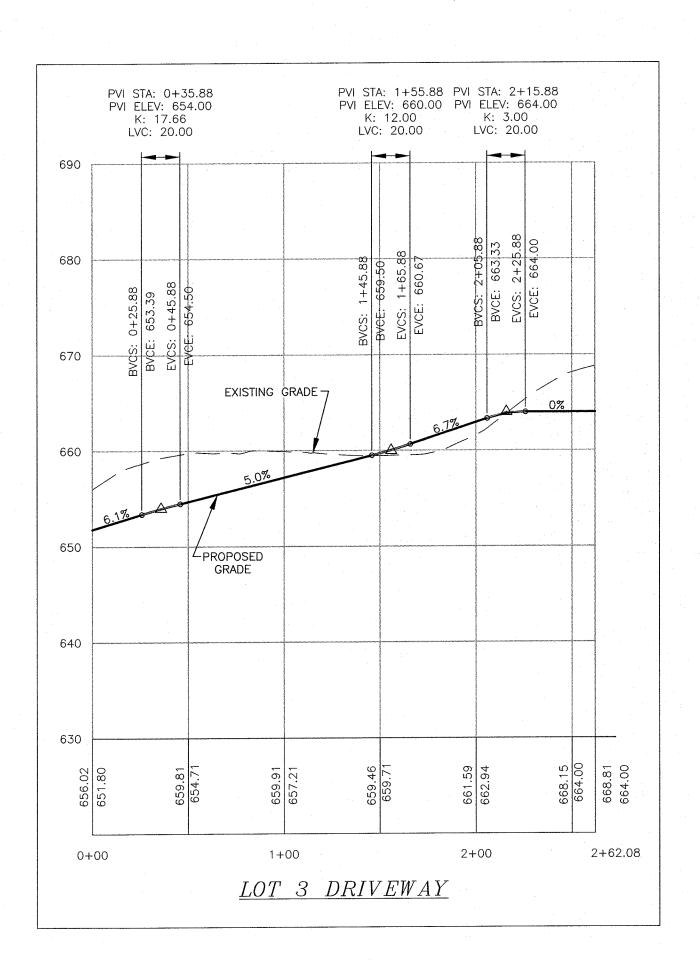
03-28-16 O.C.H.D. PREPARATION DATE


UNAUTHORIZED ALTERATION OR ADDITION TO A PLAN BEARING A LICENSED LAND SURVEYOR'S OR PROFESSIONAL ENGINEER'S SEAL IS A VIOLATION OF SECTION 7209, SUB-DIVISION 2 OF THE N.Y. STATE EDUCATION LAW. O.C.H.D. SHEET NO. | D.E.C. SHEET NO. | DRAWING NUMBER 6 OF 6 N/A OF ____ 12 OF 15 CAD REFERENCE | PROJECT NUMBER AS SHOWN 14102 ENG BASE


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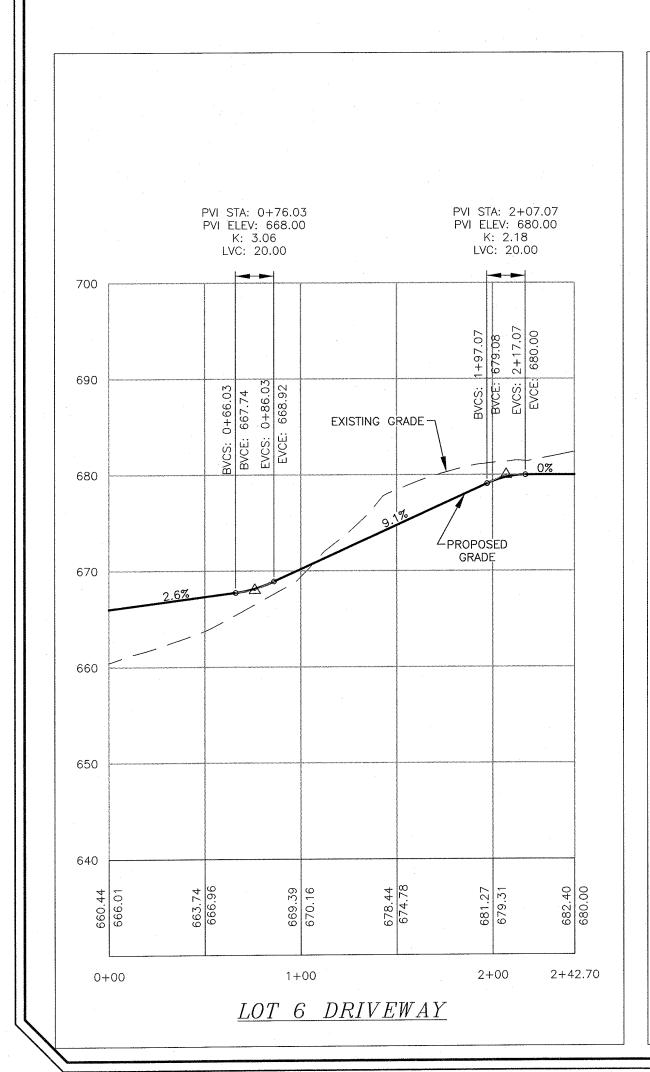








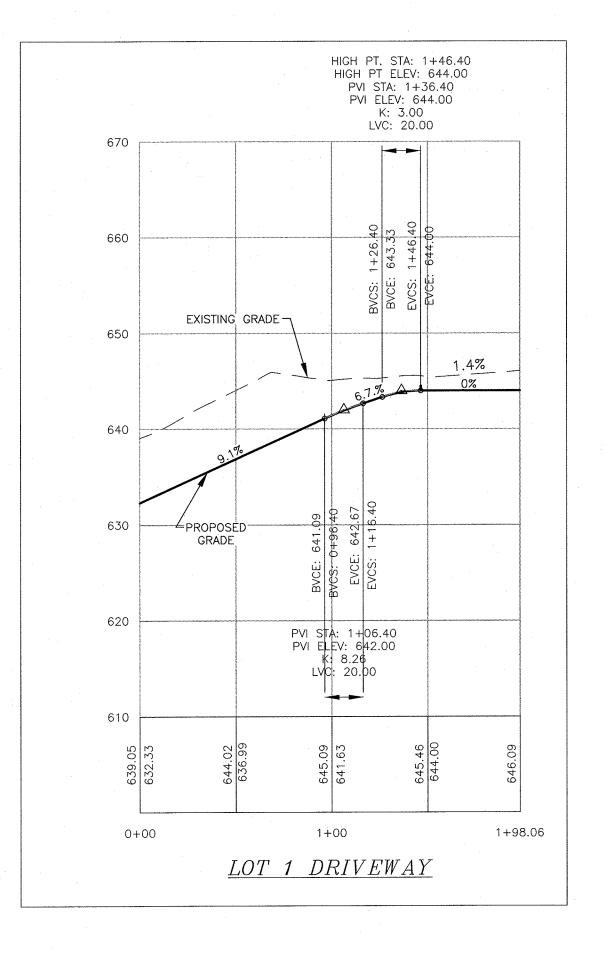


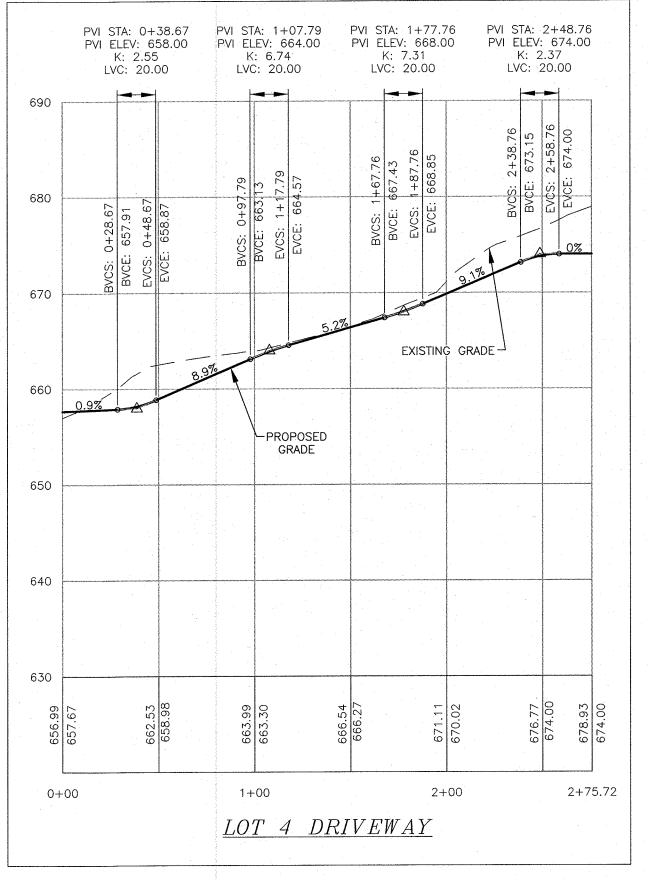


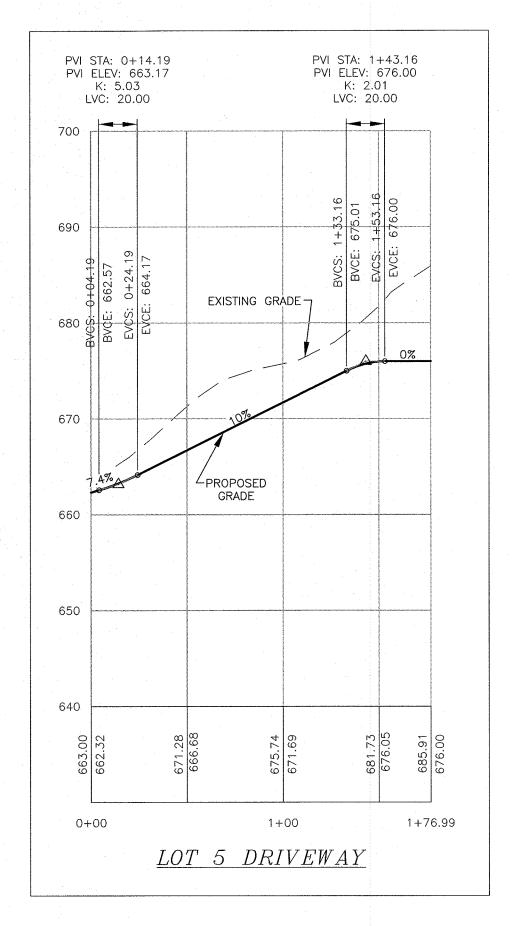

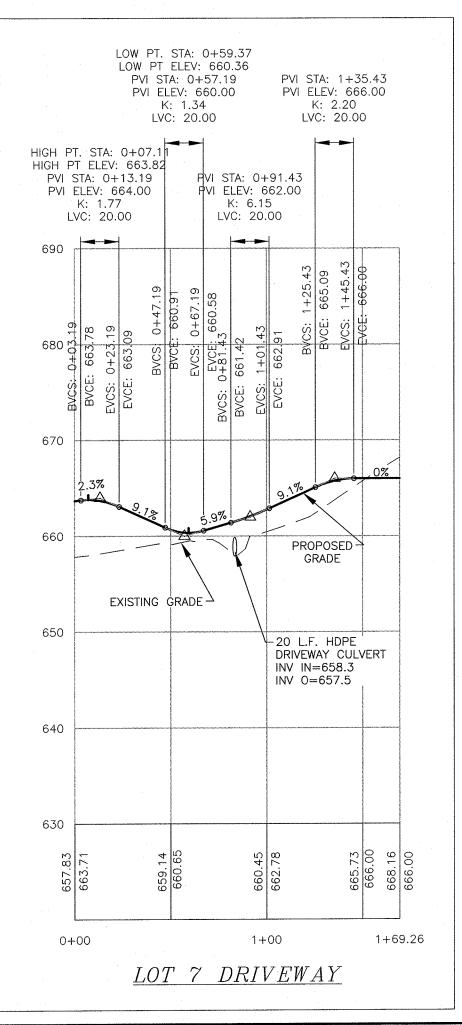

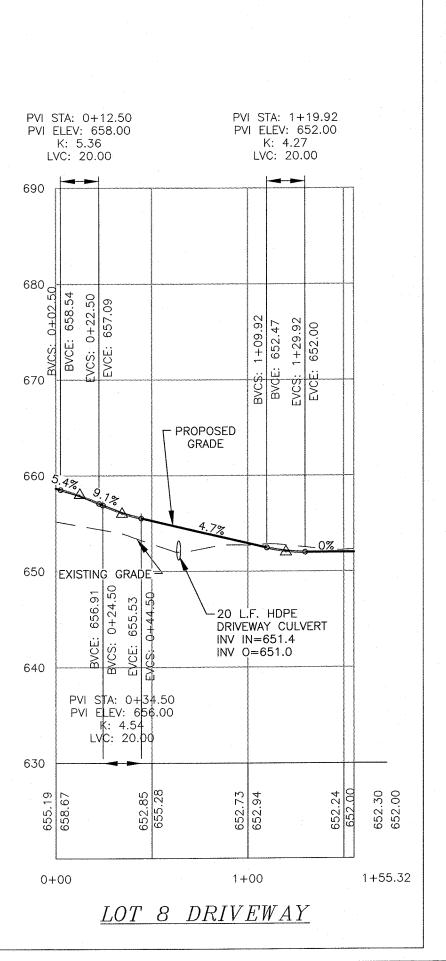

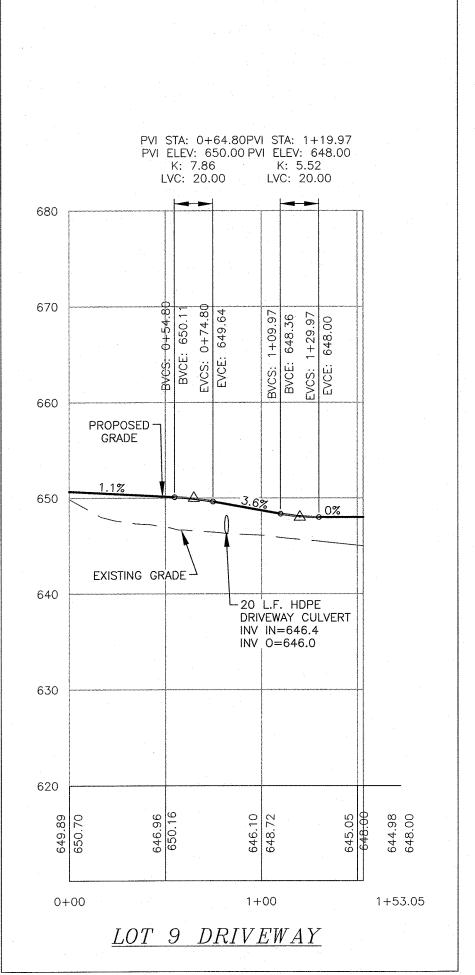

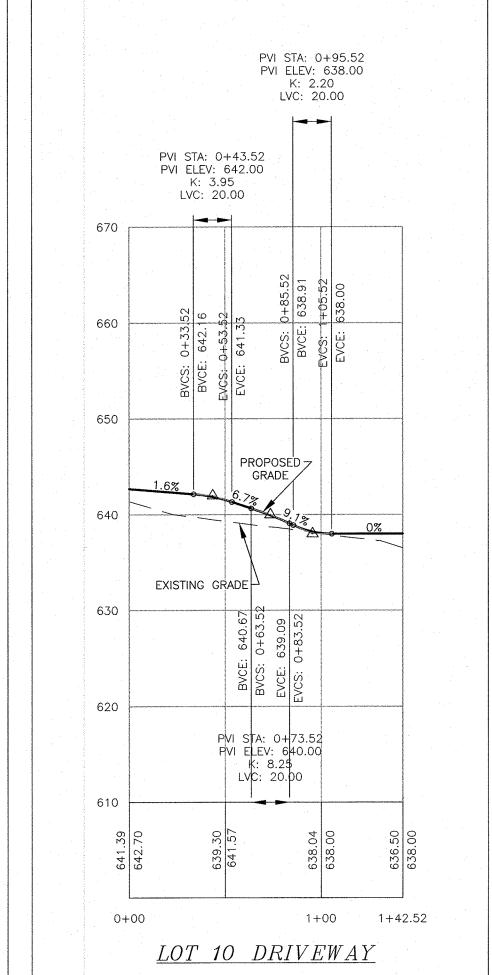

06-28-16 REVISIONS AS PER O.C.H.D. COMMENT LETTER NR 03-28-16 O.C.H.D. PREPARATION DATE 08-17-15 REVISIONS AS PER O.C.D.P.W. LETTER 06-01-15 REVISIONS AS PER O.C.D.P.W. LETTER 12-15-14 REVISIONS AS PER 12/2 COMMENT LETTER NR 11-18-14 REVISIONS AS PER 10/9 COMMENT LETTER 10-01-14 DESIGN PREPARATION DATE 12-05-13 CLUSTER SKETCH PLAN PREPARATION DATE | JJP DESCRIPTION REVISIONS MAP CHECK DATE: 03-31-16 INITIALED BY: NR PIETRZAK & PFAU ENGINEERING & SURVEYING, PLLC 262 GREENWICH AVENUE, SUITE A GOSHEN, NEW YORK 10924 (845) 294-0606 SCALE: HORIZONTAL: 1" = 50VERTICAL: 1" = 10'RESERVED FOR TOWN PLANNING BOARD APPROVAL TOWN OF CHESTER COUNTY OF ORANGE, NEW YORK PROJECT TITLE DRIVEWAY PROFILES SECTION 8 BLOCK 1 LOT 50.2 UNAUTHORIZED ALTERATION OR ADDITION TO A PLAN BEARING A LICENSED LAND SURVEYOR'S OR PROFESSIONAL ENGINEER'S SEAL IS A VIOLATION

THIS SHEET IS NOT FOR ORANGE COUNTY HEALTH DEPARTMENT REVIEW OR APPROVAL

ORANGE COUNTY DEPARTMENT OF PUBLIC WORKS NOTE:

NO SITE PREPARATION OR CONSTRUCTION, INCLUDING UTILITY CONNECTIONS, SHALL COMMENCE UNTIL A

VALID HIGHWAY WORK PERMIT HAS BEEN SECURED

FROM THE ORANGE COUNTY DEPARTMENT OF PUBLIC

WORKS UNDER SECTION 136 OF THE HIGHWAY LAW.

NR

NR

NR

NR

MONTICELLO, NEW YORK 12701

WICHAEL F. CREEGAN P.L.S.

LICENSE NO. 050323

(845) 796-4646

P.L.S., LEED®AP


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OF SECTION 7209, SUB-DIVISION 2 OF THE N.Y. STATE EDUCATION LAW.

 O.C.H.D. SHEET NO.
 D.E.C. SHEET NO.
 DRAWING NUMBER

 N/A
 OF
 13
 OF
 15

SCALE CAD REFERENCE PROJECT NUMBER
AS SHOWN 14102 ENG BASE 14102.01

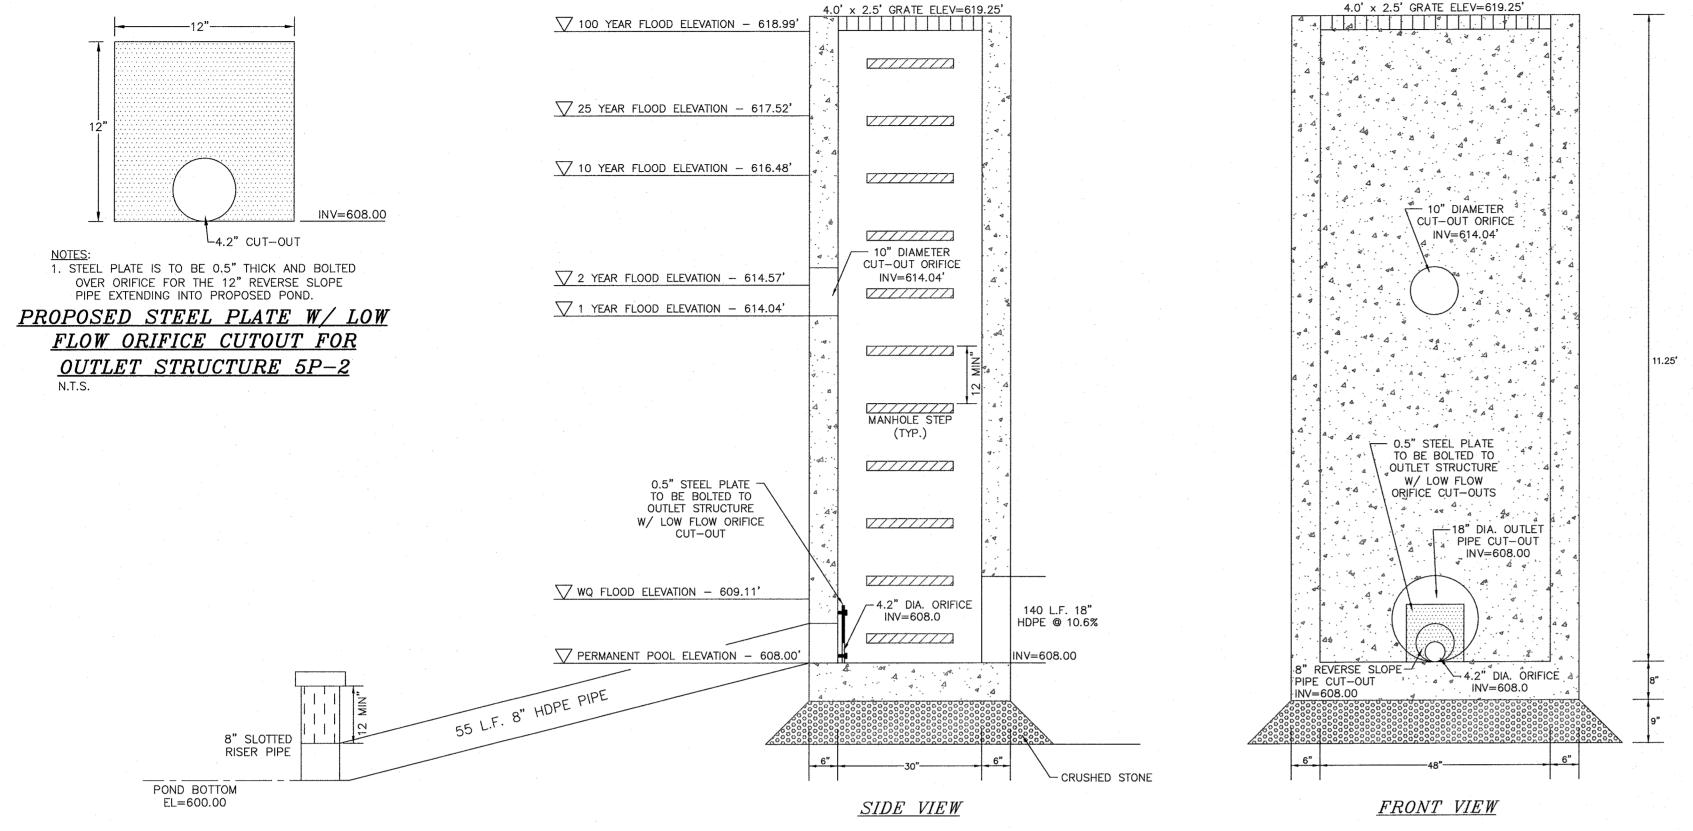

STORMWATER POND NOTES:

FOREBAY AND WET POND.

1. SOIL TESTING IN THE DETENTION POND AREA IS TO BE CONDUCTED AT THE

SIGNIFICANT INFILTRATION WILL OCCUR, THE PROPOSED POND IS TO BE CONSTRUCTED WITH A 6 TO 12 INCH NON-PERMEABLE CLAY LAYER (OR APPROVED EQUAL). THIS LAYER IS TO BE PROVIDED WITH AN UNDERLYING LAYER OF GEOTEXTILE FILTER FABRIC AND IS TO BE COMPACTED AND HARDENED TO EASE MAINTENANCE AND CLEANING OF

2. A 4 INCH LAYER OF TOPSOIL IS TO BE SPREAD EVENLY FROM THE TOP

TO BETTER PROMOTE VEGETATION ESTABLISHMENT.

OF THE POND TO 2 FEET BELOW THE PERMANENT WATER ELEVATION

TIME OF POND CONSTRUCTION. IF THIS TESTING REVEALS THAT

- 22" DIAMETER CUT-OUT ORIFICE ∑ 2 YEAR FLOOD ELEVATION − 614.57' INV=614.04' √ 1 YEAR FLOOD ELEVATION - 614.04' (TYP.) 24" DIA. OUTLET < PIPE CUT-OUT INV=608.00 √ WQ FLOOD ELEVATION − 609.11' HDPE @ 6.0% PERMANENT POOL ELEVATION - 608.00' FRONT VIEW SIDE VIEW PROPOSED OUTLET CONTROL STRUCTURE 5P-3 DETAIL

√ 100 YEAR FLOOD ELEVATION - 618.99'


∑ 25 YEAR FLOOD ELEVATION − 617.52'

√ 10 YEAR FLOOD ELEVATION — 616.48'

7777777

7//////

PROPOSED OUTLET CONTROL STRUCTURE 5P-2 DETAIL

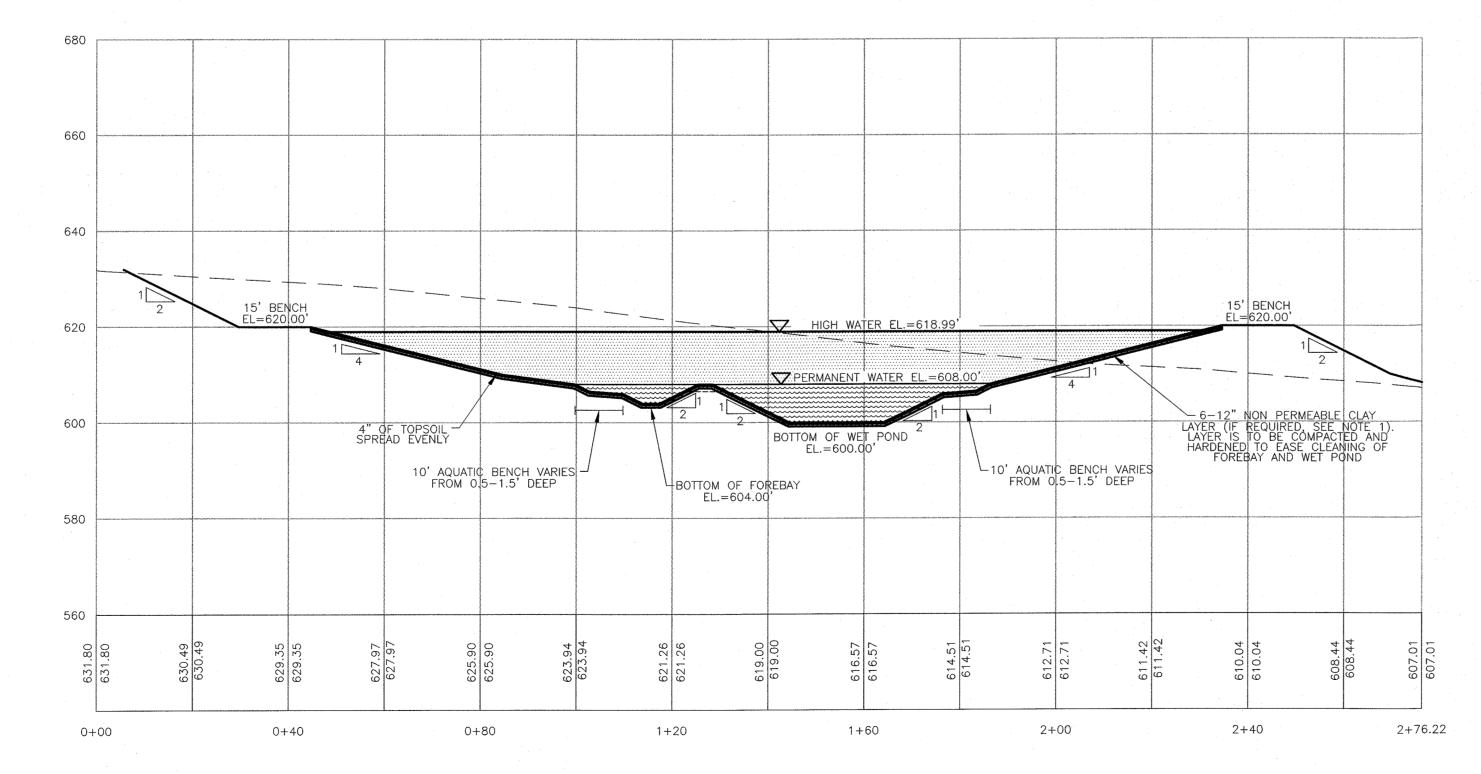


STORMWATER DETENTION POND 5P CROSS-SECTION

SCALE:

HORIZONTAL: 1" = 20'

VERTICAL: 1" = 20'

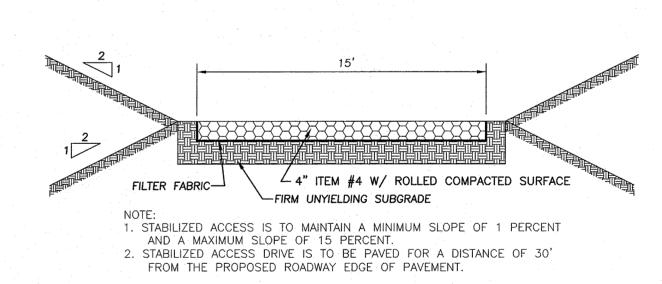

STABILIZED DETENTION POND ACCESS DRIVE DETAIL


THIS SHEET IS NOT FOR ORANGE
COUNTY HEALTH DEPARTMENT
REVIEW OR APPROVAL
RESERVED FOR TOWN PLANNING BOARD APPROVAL

4.0' x 2.5' GRATE ELEV=619.25'

INV=614.04'

ENGINEER'S CERTIFICATION

THE PROPOSED SEWAGE DISPOSAL SYSTEM(S) AND WATER SUPPLY SYSTEM(S) SHOWN ARE DESIGNED IN ACCORDANCE WITH THE STANDARDS AND REQUIREMENTS ESTABLISHED BY THE NEW YORK STATE DEPARTMENT OF HEALTH AND THE NEW YORK STATE DEPARTMENT OF ENVIRONMENTAL CONSERVATION FOR RESIDENTIAL LOTS. THE DESIGN(S) ARE BASED UPON ACTUAL SOIL AND SITE CONDITIONS FOUND UPON THE LOT(S) AT THE DESIGN LOCATION AT THE TIME OF DESIGN.

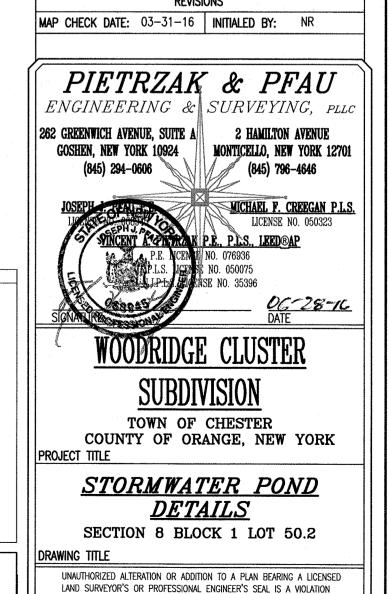

OF SECTION 7209, SUB-DIVISION 2 OF THE N.Y. STATE EDUCATION LAW.

O.C.H.D. SHEET NO. | D.E.C. SHEET NO. | DRAWING NUMBER

N/A OF 6 N/A OF _____ 14 OF 15

NO SCALE | 14102 ENG BASE | 14102.01

CAD REFERENCE PROJECT NUMBER

ORANGE COUNTY DEPARTMENT
OF PUBLIC WORKS NOTE:

NO SITE PREPARATION OR CONSTRUCTION, INCLUDING UTILITY CONNECTIONS, SHALL COMMENCE UNTIL A VALID HIGHWAY WORK PERMIT HAS BEEN SECURED FROM THE ORANGE COUNTY DEPARTMENT OF PUBLIC WORKS UNDER SECTION 136 OF THE HIGHWAY LAW.

106-28-16 REVISIONS AS PER O.C.H.D. COMMENT LETTER NR

1-21-16 REVISIONS AS PER 9/2 COMMENT LETTER NR

12-15-14 REVISIONS AS PER 12/2 COMMENT LETTER NR
11-18-14 REVISIONS AS PER 10/9 COMMENT LETTER NR

NR

NR

NR

JJP

INITIALS

03-28-16 O.C.H.D. PREPARATION DATE

10-01-14 DESIGN PREPARATION DATE

08-17-15 REVISIONS AS PER O.C.D.P.W. LETTER

06-01-15 REVISIONS AS PER O.C.D.P.W. LETTER

12-05-13 CLUSTER SKETCH PLAN PREPARATION DATE

DESCRIPTION

1. THE CONTRACTOR IS RESPONSIBLE FOR MAINTAINING A VERTICAL SEPARATION OF EIGHTEEN (18) INCHES BETWEEN EXISTING UTILITIES AND ANY PROPOSED UTILITIES. 2. ALL ROAD CROSSINGS ON A COUNTY ROAD ARE REQUIRED TO BE AT 90 DEGREES.

COMPACTION EQUIPMENT NOTES:

ALL FOLLOWING EQUIPMENT IS REQUIRED TO BE ON SITE ON A DAILY BASIS AND FULLY

- VIBRATORY TRENCH ROLLER; PRIMARY COMPACTION EQUIPMENT
- 2. JUMPING JACK COMPACTOR; SECONDARY COMPACTION EQUIPMENT FOR USE IN TIGHT AREAS, WHERE THE VIBRATORY TRENCH ROLLER CANNOT BE USED.
- 4. SIDE-DUMP LOADER OR SKID STEER (I.E. BOBCAT)
- 5. ASPHALT ROLLER
- IF ANY OF THE EQUIPMENT LISTED ABOVE IS NOT OPERATIONAL, NO EXCAVATING SHALL BE PERFORMED UNTIL ALL EQUIPMENT IS FUNCTIONING PROPERLY.

ASPHALT RESTORATION NOTES:

- ALL PAVEMENT IS REQUIRED TO BE RESTORED ON A DAILY BASIS. 2. RAGGED TRENCH EDGES MUST SAW CUT PRIOR TO ANY PAVING (TEMPORARY OR
- 3. IT WILL BE THE RESPONSIBILITY OF THE CONTRACTOR TO MAINTAIN THE 5" OF BINDER COURSE FLUSH WITH THE EXISTING PAVEMENT SURFACE THROUGHOUT THE DURATION OF THE PROJECT. FINAL ASPHALT RESTORATION IS TO BE COMPLETED
- AT THE COMPLETION OF THE PROJECT. 4. ALL TEMPORARY ASPHALT IS REQUIRED TO BE FIVE (5) INCHES THICK AND PLACED
- IN TWO (2) LIFTS OF 2-1/2 INCHES.

 5. ALL EDGES OF EXISTING ASPHALT ARE REQUIRED TO BE SWEPT AND TACK COATED
- 6. ALL ASPHALT IS REQUIRED TO BE SAW CUT PARALLEL OR PERPENDICULAR TO THE
- TRENCH OR TO THE EXISTING ASPHALT. NO RAGGED EDGES ARE ACCEPTABLE. 7. ALL SAW CUTTING IS REQUIRED TO BE PERFORMED PRIOR TO PLACING ASPHALT BINDER. MILLING OUT THE JAGGED EDGES ON THE TOP COURSE OR FINAL ASPHALT
- WILL NOT BE ACCEPTED BY ORANGE COUNTY. 8. ALL ASPHALT JOINTS ARE REQUIRED TO BE CRACK SEALED UPON COMPLETING

FINAL PAVING.

- 1. CONTRACTOR SHALL BE RESPONSIBLE FOR THE REMOVAL AND REPLACEMENT OF SIGNS, GUIDE RAILS, GUIDE POSTS, CULVERT PIPES, MAILBOXES, HEADWALLS, ETC. WHICH MUST BE REMOVED FOR CONSTRUCTION. CONTRACTOR SHALL REINSTALL ANY REMOVED ITEMS ON A DAILY BASIS. ANY ITEMS DAMAGED BY REMOVAL OR REINSTALLATION SHALL BE REPLACED AND REINSTALLED BY THE CONTRACTOR WITH
- 2. NO UTILITY WORK (WATER, SEWER STORM DRAINAGE) IS ALLOWED TO BE PERFORMED BETWEEN NOVEMBER 15 AND MARCH 15 WITHIN THE COUNTY RIGHT
- 3. NO TRACK EQUIPMENT IS ALLOWED ON THE COUNTY ROAD WITHOUT PLACING MATS, PLYWOOD, TIRES, ETC. TO PROTECT THE ASPHALT ROAD.
- 4. NO OPEN TRENCHES ARE ALLOWED TO REMAIN OPEN OVERNIGHT. ALL OPEN TRENCHES ARE REQUIRED TO BE BACKFILLED ON A DAILY BASIS.
- 5. NO ROAD PLATES ARE ALLOWED TO BE USED OVERNIGHT. ROAD PLATES ARE ONLY ALLOWED TO BE USED DURING DAILY OPERATIONS TO MAINTAIN TRAFFIC ON THE ROADWAY AND AT RESIDENTIAL/COMMERCIAL DRIVEWAYS. THE CONTRACTOR IS RESPONSIBLE FOR THE PROPER COORDINATION WITH HOMEOWNERS AND BUSINESSES TO ENSURE THAT THEY CAN ENTER AND EXIT THEIR DRIVEWAYS DURING THE COURSE OF DAY TO DAY OPERATIONS.

- 1. ALL DITCHES AND SWALES ARE REQUIRED TO BE REGRADED TO ENSURE POSITIVE DRAINAGE UPON COMPLETION OF THE INSTALLATION OF THE PROPOSED CULVERT PIPE. NO EXISTING DRAINAGE CHANNEL, SWALE, DITCH, STREAM, OR STRUCTURE AFFECTING THE COUNTY ROAD SHALL BE BLOCKED OR FILLED NOR THE FLOW TO OR FROM AN EXISTING DRAINAGE CHANNEL, SWALE, DITCH STREAM, OR STRUCTURE BE MADE WITHOUT AN APPROVED DESIGN.
- 2. EXISTING DRAINAGE DITCHES ALONG THE COUNTY ROAD WILL BE REALIGNED AFTER ALL WORK IN THE COUNTY RIGHT OF WAY IS COMPLETE.


MAINTENANCE AND PROTECTION OF TRAFFIC NOTES:

- 1. PROVIDE NOTES THAT ALL WORK IS TO BE PERFORMED IN ACCORDANCE WITH ORANGE COUNTY REQUIREMENTS. THE FOLLOWING SIGNS ARE REQUIRED TO BE PLACED IN EACH DIRECTION TO PERFORM THE WORK PER THE APPROVED PLANS: ROAD WORK 1500 FT, ROAD WORK 1000 FT, ROAD WORK 500 FT, ONE LANE ROAD AHEAD, FLAGGER SYMBOL ON EACH APPROACH WHEN TAKING A TRAVEL LANE. 2. WHEN WORK IS PERFORMED ON THE SHOULDER THE FOLLOWING SIGNS ARE
- REQUIRED: ROAD WORK 1500 FT, ROAD WORK 1000 FT, ROAD WORK 500 FT, NO SHOULDER. FLAGGER SYMBOLS ARE REQUIRED TO BE AVAILABLE FOR A NO
- SHOULDER WORK ZONE IN CASE FLAGGERS ARE USED TO DIRECT TRAFFIC. THE MORE STRINGENT SIGN REQUIREMENTS OF ORANGE COUNTY SUPERSEDE ANY MUTCD REQUIREMENTS.
- 4. ALL MAINTENANCE AND PROTECTION OF TRAFFIC CONSTRUCTION SIGNAGE SHALL BE INSTALLED AND IN PLACE PRIOR ANY WORK STARTING. ALL CONSTRUCTION SIGNAGE IS REQUIRED TO MEET THE REQUIREMENTS AS PER THE "NATIONAL MANUAL OF UNIFORM TRAFFIC CONTROL DEVICES FOR STREETS AND HIGHWAYS" AND NYS SUPPLEMENT LATEST EDITION AND REVISIONS. COUNTY REQUIREMENTS ARE MORE STRINGENT WITH REGARD REQUIRED MPT SIGNAGE AND ARE THE STANDARD TO BE ADHERED TO. THE CONSTRUCTION SIGNAGE SHALL BE INSTALLED ON BREAKAWAY POSTS OR ON WIND-MASTERS AND COVERED AND UNCOVERED ON A DAILY BASIS THE CONTRACTOR MUST HAVE ALL THE NECESSARY CONSTRUCTION SIGNS TO PERFORM THE WORK SAFELY; I.E. ADDITIONAL SIGNAGE: ONE LANE ROAD AHEAD, FLAGGER SYMBOL, IF A LANE HAS TO BE CLOSED TO PERFORM WORK.
- 5. ALL CONSTRUCTION SIGNAGE IS REQUIRED TO BE 730-05.02 ASTM TYPE III (CLASS B) AS PER NYS STANDARD SPECIFICATIONS: CONSTRUCTION AND MATERIALS. HI-INTENSITY REFLECTIVE SHEETING OFTEN REFERRED TO AS HIGH INTENSITY. IT IS RECOMMENDED FOR HIGHWAY SIGNS, CONSTRUCTION SIGNS, DELINEATORS, AND OTHER WORK ZONE DEVICES.
- 6. WORK ZONE IS REQUIRED TO BE PROPERLY DELINEATED WITH CONES OR
- CONSTRUCTION BARRELS. 7. ORANGE COUNTY RESERVES THE RIGHT TO PRECLUDE ALL WORK AND LANE CLOSURES DURING ANY INCLEMENT WEATHER OR OTHER UNFORESEEN CIRCUMSTANCES (I.E. WET, ICY CONDITIONS, REDUCED VISIBILITY, TRAFFIC
- ACCIDENTS ON STATE, COUNTY, TOWN OR VILLAGE ROAD, OR OTHER EMERGENCIES). 8. NO LANE CLOSURES WILL BE PERMITTED FROM 12 NOON PRIOR TO A HOLIDAY
- AND UNTIL 10 AM THE DAY AFTER THE HOLIDAY. 9. FLAGGERS SHALL NOT CONTROL MORE THAN ONE APPROACH AT ANYTIME
- THROUGHOUT THE DURATION OF THE WORK ZONE. ADDITIONAL FLAGGERS ARE REQUIRED TO CONTROL ALL APPROACHES IN A WORK ZONE.
- 10. EIGHTEEN (18) INCH STOP AND SLOW PADDLES ARE REQUIRED TO DIRECT TRAFFIC. 11. TWO WAY RADIOS ARE REQUIRED FOR FLAGGERS TO COMMUNICATE BETWEEN EACH

OSHA REQUIREMENTS:


ALL OSHA REQUIREMENTS MUST BE ADHERED TO AT ALL TIMES. 2. SHORING: THE CONTRACTOR SHALL BE RESPONSIBLE FOR SHORING ANY TRENCH OR EXCAVATION THAT IS GREATER THAN 5 FEET DEEP OR WHICH, IN THE OPINION OF THE OCDPW INSPECTOR IN THE FIELD POSES A DANGER TO THE CONTRACTOR PERSONNEL ON THE JOB. THE CONTRACTOR HAS THE OPTION OF USING A PREFABRICATED SHORING SYSTEM, INSTALLING A TIMBER-CONSTRUCTED SYSTEM AS PER OSHA SPECIFICATIONS OR A TIMBER SYSTEM DESIGNED AND STAMPED BY A PROFESSIONAL ENGINEER. NO OTHER SHORING SYSTEM WILL BE APPROVED FOR USE ON THIS PROJECT.

1. THE NORMAL WORKING HOURS FOR THIS PROJECT IS 7:00 AM TO 3:30 PM. ALL TRAFFIC LANES MUST BE BACK IN SERVICE BY 4:30 PM. OCDPW MUST APPROVE ANY CHANGES TO THESE HOURS IN ADVANCE. 2. NO HOLIDAY WORK AS PER ORANGE COUNTY'S APPROVED HOLIDAY SCHEDULE.

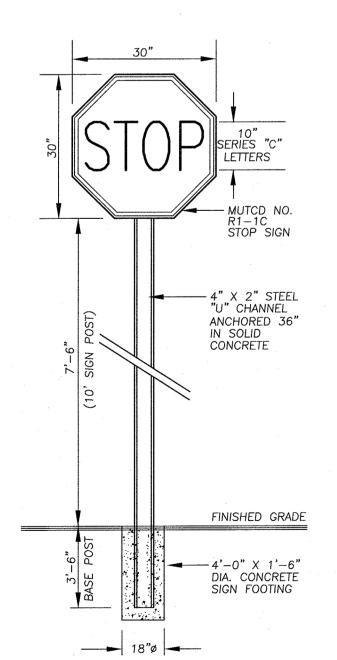


- 1. ALL SIGNAGE MUST BE MOUNTED ON BREAK-AWAY POSTS. 2. SIGN TO BE 30"x30" 3M HI INTENSITY PRISMATIC GRADE STOP SIGN
- OR APPROVED EQUAL 3. BASE POST SHALL NOT PROJECT MORE THAN 4" ABOVE FINISHED
- 4. BASE POST AND SIGN POST TO BE HOT DIPPED GALVANIZED WITH A
- BREAKING STRENGTH OF 4 LB/FT MIN. 5. ATTACHED TO SIGN POST SHALL BE TWO (2) 36" X 3" WIDE RED HI INTENSITY PRISMATIC GRADE REFLECTIVE POST PANELS.

STOP SIGN DETAIL

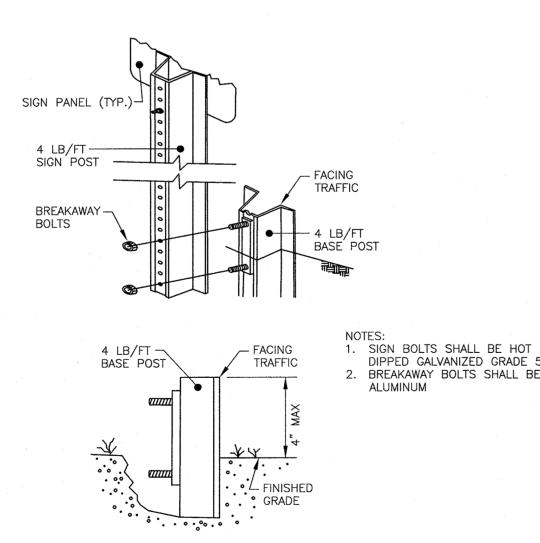


ANCHOR POST ASSEMBLY SIGN SUPPORTS DETAIL

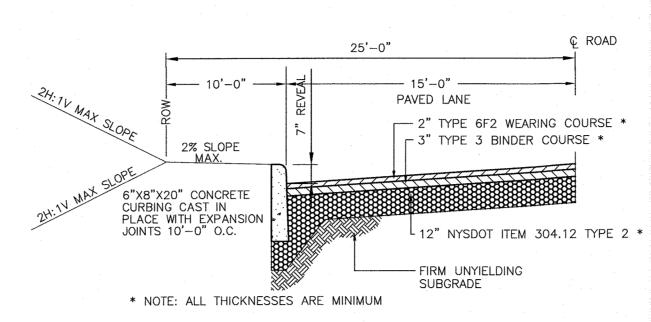

1. PROPOSED ROADWAY ENTRANCE IS TO BE PAVED IN ACCORDANCE WITH THIS DETAIL FOR THE FIRST 50 FEET OF PROPOSED ROADWAY BEGINNING AT THE EDGE OF THE EXISTING TRAVEL LANE (WHITE LINE) OF LAROE ROAD (COUNTY ROAD 45).

2. CURBS WITHIN THE COUNTY ROAD R.O.W. MUST HAVE A 7" REVEAL. 3. ANY EXISTING STRIPING THAT IS REMOVED DURING TRENCH EXCAVATION OR DURING MILLING OPERATIONS IS REQUIRED TO BE REPLACED. 4. ALL SLOPES AT THE PROPOSED ENTRANCE SHALL BE 1 ON 3 MINIMUM

O.C.D.P.W. ROAD ENTRANCE DETAIL

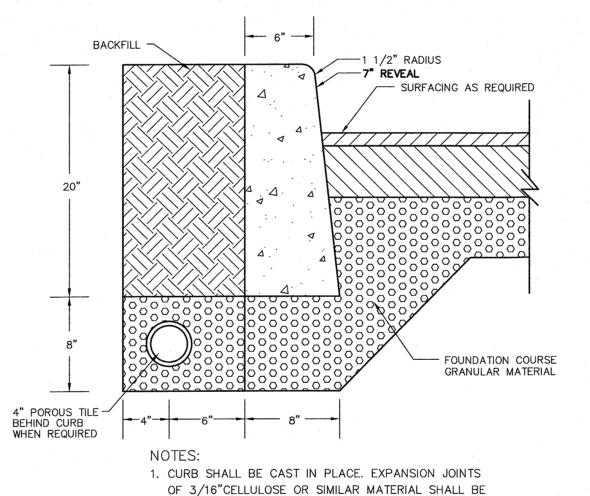


2. CONCRETE TO TEST 4000 PSI AT 28 DAYS CONCRETE CURB DETAIL

OR EQUAL.


PLACED AT TEN (10) FOOT INTERVALS. CONCRETE TO

BE 1:2:3 MIX DESIGN, AIR ENTRAINED WITH DUREX

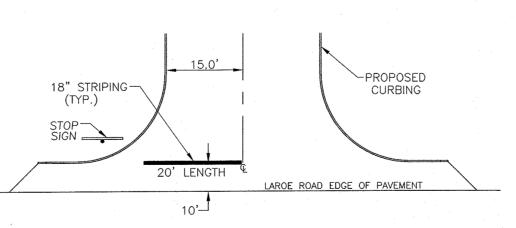


- 1. REFLECTORIZED PAVEMENT MARKING PAINTS SHALL BE SELECTED FROM THE NYS DOT APPROVED LIST OF WHITE AND YELLOW REFLECTORIZED PAVEMENT MARKING PAINTS.
- 2. IMMEDIATELY FOLLOWING PAINT APPLICATION, REFLECTIVE GLASS BEADS SHALL BE UNIFORMLY APPLIED AT A RATE OF 6 LB/GAL OF PAINT. 3. THE APPLIED PAVEMENT MARKINGS SHALL HAVE CLEAN-CUT EDGES AND TRUE AND SMOOTH ALIGNMENT.
- 4. STOP BAR WIDTH IS TO BE 1'-6". PAVEMENT STRIPING SHALL BE IN CONFORMANCE WITH SECTION 640 REFLECTORIZED PAVEMENT MARKING PAINTS OF THE NYSDOT STANDARD SPECIFICATIONS.

STOP LINE STRIPING DETAIL

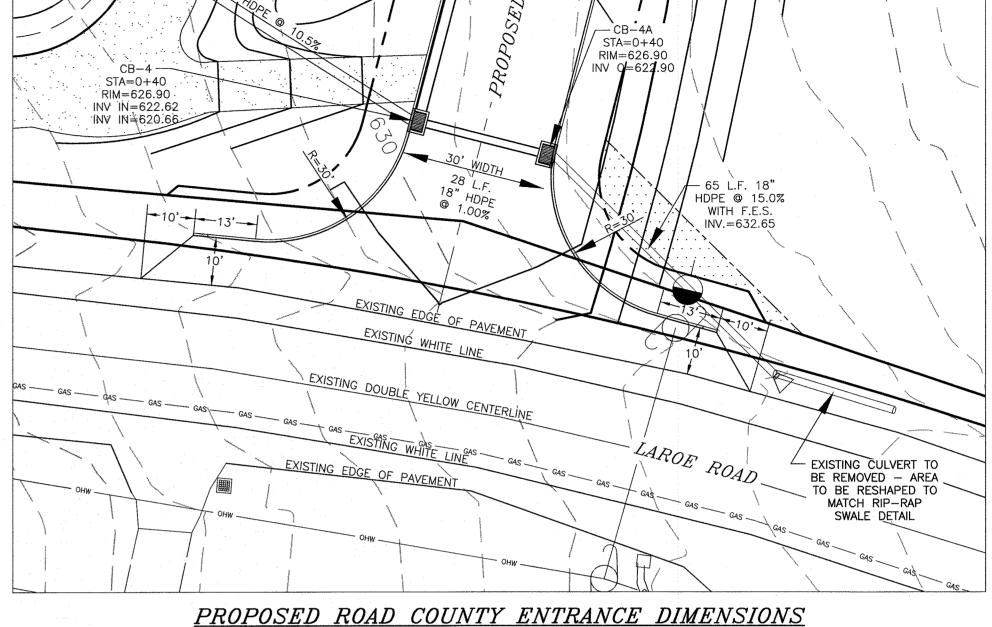


PROPOSED ROAD COUNTY ENTRANCE DIMENSIONS

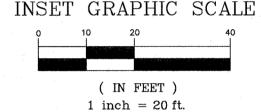

THIS SHEET IS NOT FOR ORANGE

COUNTY HEALTH DEPARTMENT


REVIEW OR APPROVAL RESERVED FOR TOWN PLANNING BOARD APPROVAL

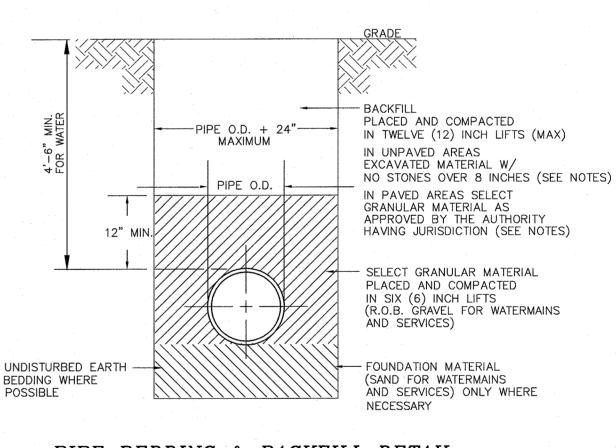

<u>PIPE BEDDING & BACKFILL DETAIL</u>

BACKFILL MATERIAL NOTES:

- 1. ALL BACKFILL IS REQUIRED TO BE BACKFILLED IN TWELVE (12) INCH LIFTS MAXIMUM. 2. DRY K CRETE SHALL BE USED AT ALL ROAD CROSSINGS (TOWN ROADS), COMMERCIAL ENTRANCES, AND ALL TRENCHES WITHIN ASPHALT OR AS DIRECTED BY
- ORANGE COUNTY INSPECTOR. 3. ITEM NO. 4: ITEM 304.12 SUBBASE COURSE TYPE 2 IS REQUIRED TO BE USED AS
- BACKFILL FROM EDGE OF PAVEMENT OUT EIGHT (8) FEET.
- 4. EXCAVATED MATERIAL IS ALLOWED TO BE USED AS BACKFILL MATERIAL EIGHT (8) FEET BEYOND THE EDGE OF PAVEMENT. NO BOULDERS/ROCKS OVER 12 INCHES ARE ALLOWED TO BE USED AS BACKFILL.
- 5. MATERIAL TICKETS ARE REQUIRED TO BE PROVIDED TO THE ORANGE COUNTY INSPECTOR ON A DAILY BASIS FOR ALL MATERIAL USED IN THE COUNTY RIGHT OF

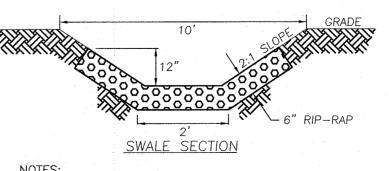

1. ALL EXISTING SWALE RESTORATION IS TO MATCH EXISTING RIP-RAP SWALE CROSS SECTION AND DIMENSIONS.

2. THE SIZE OF THE RIP-RAP FOR RESTORATION PURPOSES IS TO BE REPLACED IN KIND. RIP-RAP SWALE DETAIL

ORANGE COUNTY DEPARTMENT OF PUBLIC WORKS NOTE:

NO SITE PREPARATION OR CONSTRUCTION, INCLUDING UTILITY CONNECTIONS, SHALL COMMENCE UNTIL A VALID HIGHWAY WORK PERMIT HAS BEEN SECURED FROM THE ORANGE COUNTY DEPARTMENT OF PUBLIC WORKS UNDER SECTION 136 OF THE HIGHWAY LAW. 06-28-16 REVISIONS AS PER O.C.H.D. COMMENT LETTER NR 03-28-16|0.C.H.D. PREPARATION DATE 01-21-16 REVISIONS AS PER 9/2 COMMENT LETTER 08-17-15 REVISIONS AS PER O.C.D.P.W. LETTER NR 06-01-15 REVISIONS AS PER O.C.D.P.W. LETTER NR 12-15-14 REVISIONS AS PER 12/2 COMMENT LETTER NR 11-18-14 REVISIONS AS PER 10/9 COMMENT LETTER | NR

110-01-14 DESIGN PREPARATION DATE 12-05-13 CLUSTER SKETCH PLAN PREPARATION DATE DESCRIPTION

NR

JJP

INITIALS

REVISIONS MAP CHECK DATE: 03-31-16 INITIALED BY: NR

PIETRZAK & PFAU ENGINEERING & SURVEYING, plice 262 GREENWICH AVENUE, SUITE A 2 HAMILTON AVENUE GOSHEN, NEW YORK 10924 | | MONTICELLO, NEW YORK 12701 **(845)** 796–4646 (845) 294-0606 MICHAEL F. CREEGAN P.L.S LICENSE NO. 050323

TOWN OF CHESTER COUNTY OF ORANGE, NEW YORK

O.C.D.P.W. DETAILS

SECTION 8 BLOCK 1 LOT 50.2

UNAUTHORIZED ALTERATION OR ADDITION TO A PLAN BEARING A LICENSED LAND SURVEYOR'S OR PROFESSIONAL ENGINEER'S SEAL IS A VIOLATION OF SECTION 7209, SUB-DIVISION 2 OF THE N.Y. STATE EDUCATION LAW. O.C.H.D. SHEET NO. | D.E.C. SHEET NO. | DRAWING NUMBER 15 OF 15 <u>N/A</u> OF <u>6</u> <u>N/A</u> OF ____

NO SCALE | 14102 ENG BASE |

CAD REFERENCE PROJECT NUMBER 14102.01