# ELKAY DRIVE COMMERCIAL BUILDING SITE PLAN

TOWN OF CHESTER ORANGE COUNTY, NEW YORK

> PROPOSED STORMWATER FACILITIES

LOCATION

PROPOSED 30,500 sq.ft.
LIGHT INDUSTRIAL
BUILDING

PROPOSED

PROPOSED

SANITARY

**FACILITIES** 

60' FRONT YARD SETBACK

RETAINING WALL WITH 6'-HIGH CHAIN LINK FENCE

(SEE DETAILS)

N/F AL-TAKIQ

6-1-72

SINGH / KHANDUJA 6-1-69.3

### **GENERAL NOTES:**

- 1. PARCEL OF LAND TO BE DEVELOPED IS LOCATED IN THE TOWN OF CHESTER, SECTION 6 BLOCK 1 LOT 69.4.
- 2. TOTAL AREA OF PARCEL: 2.77± ACRES.
- 3. PARCEL IS LOCATED IN THE IP INDUSTRIAL PARK ZONING DISTRICT.
- 4. PROPOSED USE IS LIGHT INDUSTRIAL USES, INCLUDING MANUFACTURING, ASSEMBLY, CONVERTING, ALTERING, FINISHING, CLEANING OR ANY OTHER PROCESSING OF MATERIALS INVOLVING THE USE OF ONLY OIL, GAS, ELECTRICITY OR THE EQUIVALENT.
- 5. TOTAL BUILDING SQUARE FOOTAGE IS 30,500 sq.ft.
- 6. TOTAL NUMBER OF PARKING SPACES IS 27 PARKING SPACES.
- 7. TOTAL NUMBER OF LOADING DOCKS IS 2.
- 8. FACILITY TO BE SERVED BY CENTRAL WATER AND SEWER FACILITIES.
- 9. ENTIRE PARCEL IS WITHIN THE CHESTER UNION FREE SCHOOL DISTRICT.
- 10. ENTIRE PARCEL IS WITHIN THE MECHANICSTOWN FIRE DISTRICT. 11. THERE ARE NO N.Y.S.D.E.C. WETLANDS OR FEDERAL WETLANDS ONSITE.
- 12. BUILDING DIMENSIONS AND AREAS ARE APPROXIMATE. FINAL DIMENSIONS AND AREAS WILL BE DEVELOPED AS PART OF THE FINAL BUILDING PLANS.
- 13. MAXIMUM NUMBER OF EMPLOYEES PER MAX SHIFT IS 24.
- 14. MAP REFERENCE: "SURVEY & TOPOGRAPHY OF PROPERTY FOR 1657 MANAGEMENT, LLC DATED JULY 27, 2018 AND PREPARED BY JAMES A. DILLON, PLS

- 1. PRIOR TO ANY CONSTRUCTION, CONTRACTOR IS TO CONTACT ALL UTILITY COMPANIES FOR UTILITY MARK OUTS. CONTRACTOR IS TO ASSUME FULL RESPONSIBILITY FOR MAINTAINING CONTINUOUS UTILITY SERVICE AND REPAIRS TO UTILITIES IN THE EVENT
- 2. PRIOR TO ANY CONSTRUCTION, CONTRACTOR IS TO FIELD LOCATE AND VERIFY ALL EXISTING UTILITIES LOCATIONS, ELEVATIONS, INVERTS, ETC. AND NOTIFY THE DESIGN
- ENGINEER OF ANY DISCREPANCIES ON THIS PLAN. 3. CONTRACTOR IS TO COORDINATE NEW UTILITY SERVICES WITH ALL UTILITY COMPANIES.
- 4. CONTRACTOR IS TO BE RESPONSIBLE FOR ALL TRAFFIC MAINTENANCE.

  5. CONTRACTOR IS TO BE RESPONSIBLE FOR ALL PROJECT SAFETY REQUIREMENTS.




KEAVCO 6-1-69.5


HANDICAP PROPOSED WELL LOCATION

N/F SURESKY STORAGE LOT, LLC.

6-1-70.12

(SEE DETAIL)

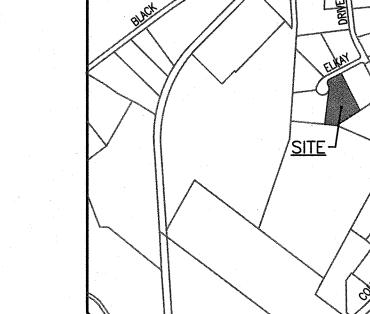

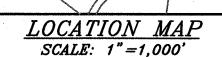

#### RECORD OWNER 1657 MANAGEMENT LLC P.O. BOX 96 MONROE, NEW YORK 10949

RECORD APPLICANT 1657 MANAGEMENT LLC P.O. BOX 96 MONROE, NEW YORK 10949

#### BULK REQUIREMENTS ZONE IP (INDUSTRIAL PARK DISTRICT) USE GROUP (12) LIGHT INDUSTRIAL USES

MIN. REQUIRED	<u>PROVIDE</u>
2	2.77
200	266
60	60
<i>50</i>	50
".) 100	100
50	50
	2 200 60 50 7.) 100

<u>M</u> .	AX. PERMITT	ED .
BLDG. HEIGHT (FT).	<i>65</i>	<65
BUILDING COVERAGE (%	) 40	25.3


### PLAN INDEX


	4 4-4 + + + + + + + + + + + + + + + + +
SHEET	NO. <u>TITLE</u>
1	COVER SHEET/SITE PLAN
2	EXISTING CONDITIONS PLAN
3	GRADING PLAN
4	UTILITY PLAN
5	EROSION CONTROL PLAN
6	EROSION CONTROL DETAILS
7	LIGHTING PLAN
8	LANDSCAPING PLAN
9	SITE DETAILS 1
10	SITE DETAILS 2
11	SANITARY & WATER SUPPLY DETAILS

## PARKING CALCULATIONS


INDUSTRIAL/MANUFACTURING USE 2 SPACES PER 3 EMPLOYEES ON THE 2 LARGEST CONSECUTIVE SHIFTS ASSUME 24 EMPLOYEES PER MAX SHIFT:


2 SPACES/3 EMPL. x 24 EMPLOYEES = 16.0 SPACES MIN. NUMBER OF SPACES REQUIRED = 16 SPACES TOTAL NUMBER OF SPACES PROVIDED = 27 SPACES

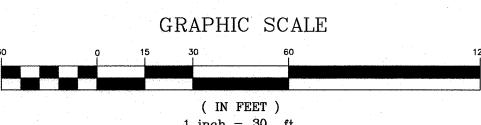


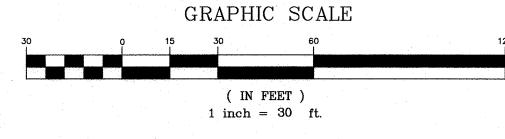



BEFORE YOU DIG, DRILL OR BLAST!
-CALL TOLL FREE 1-800-962-7962 -NY INDUSTRIAL CODE RULE 753 REQUIRES NO LESS THAN TWO WORKING DAYS NOTICE, BUT NOT MORE THAN TEN DAYS NOTICE.

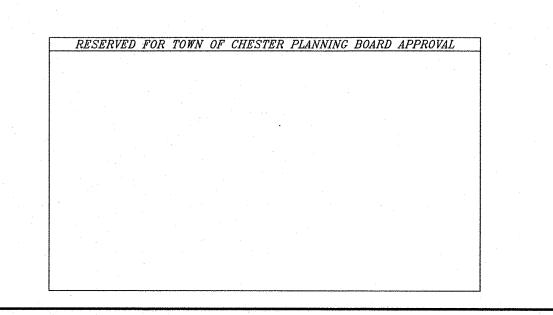

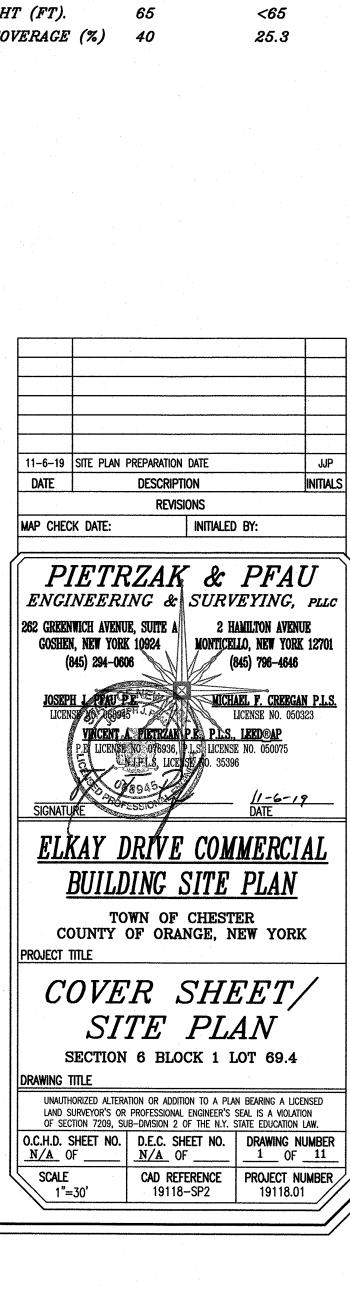

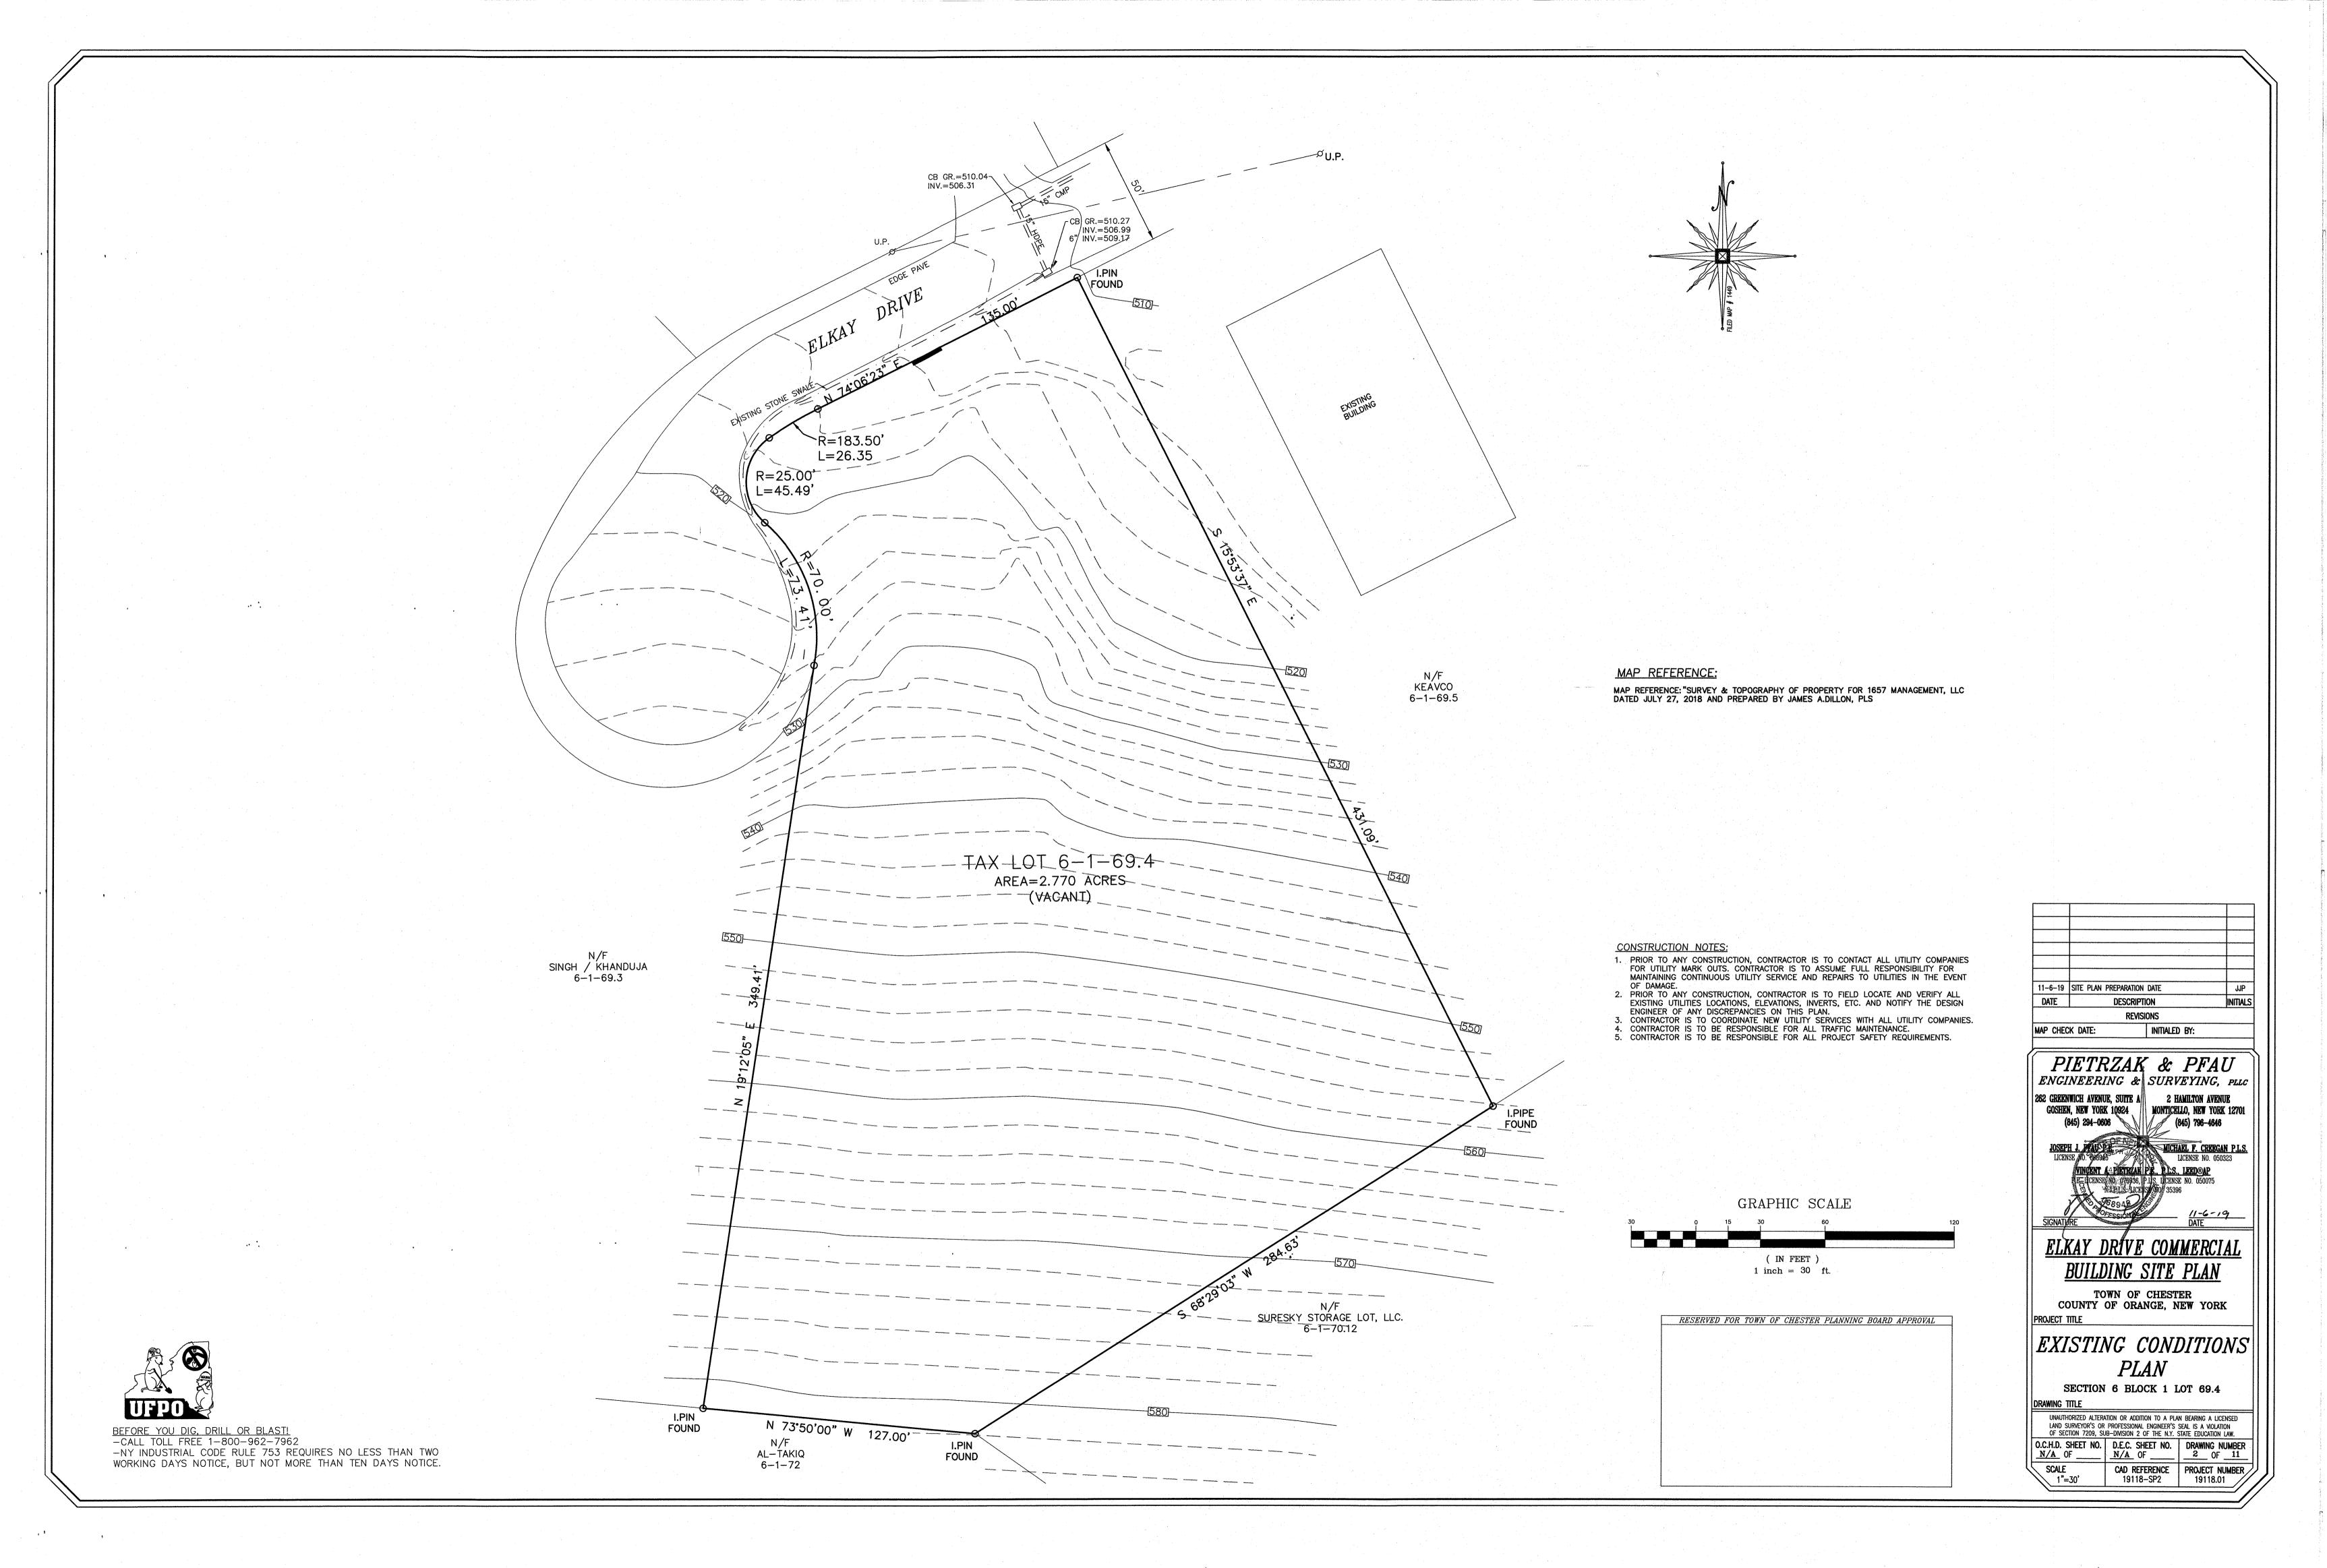

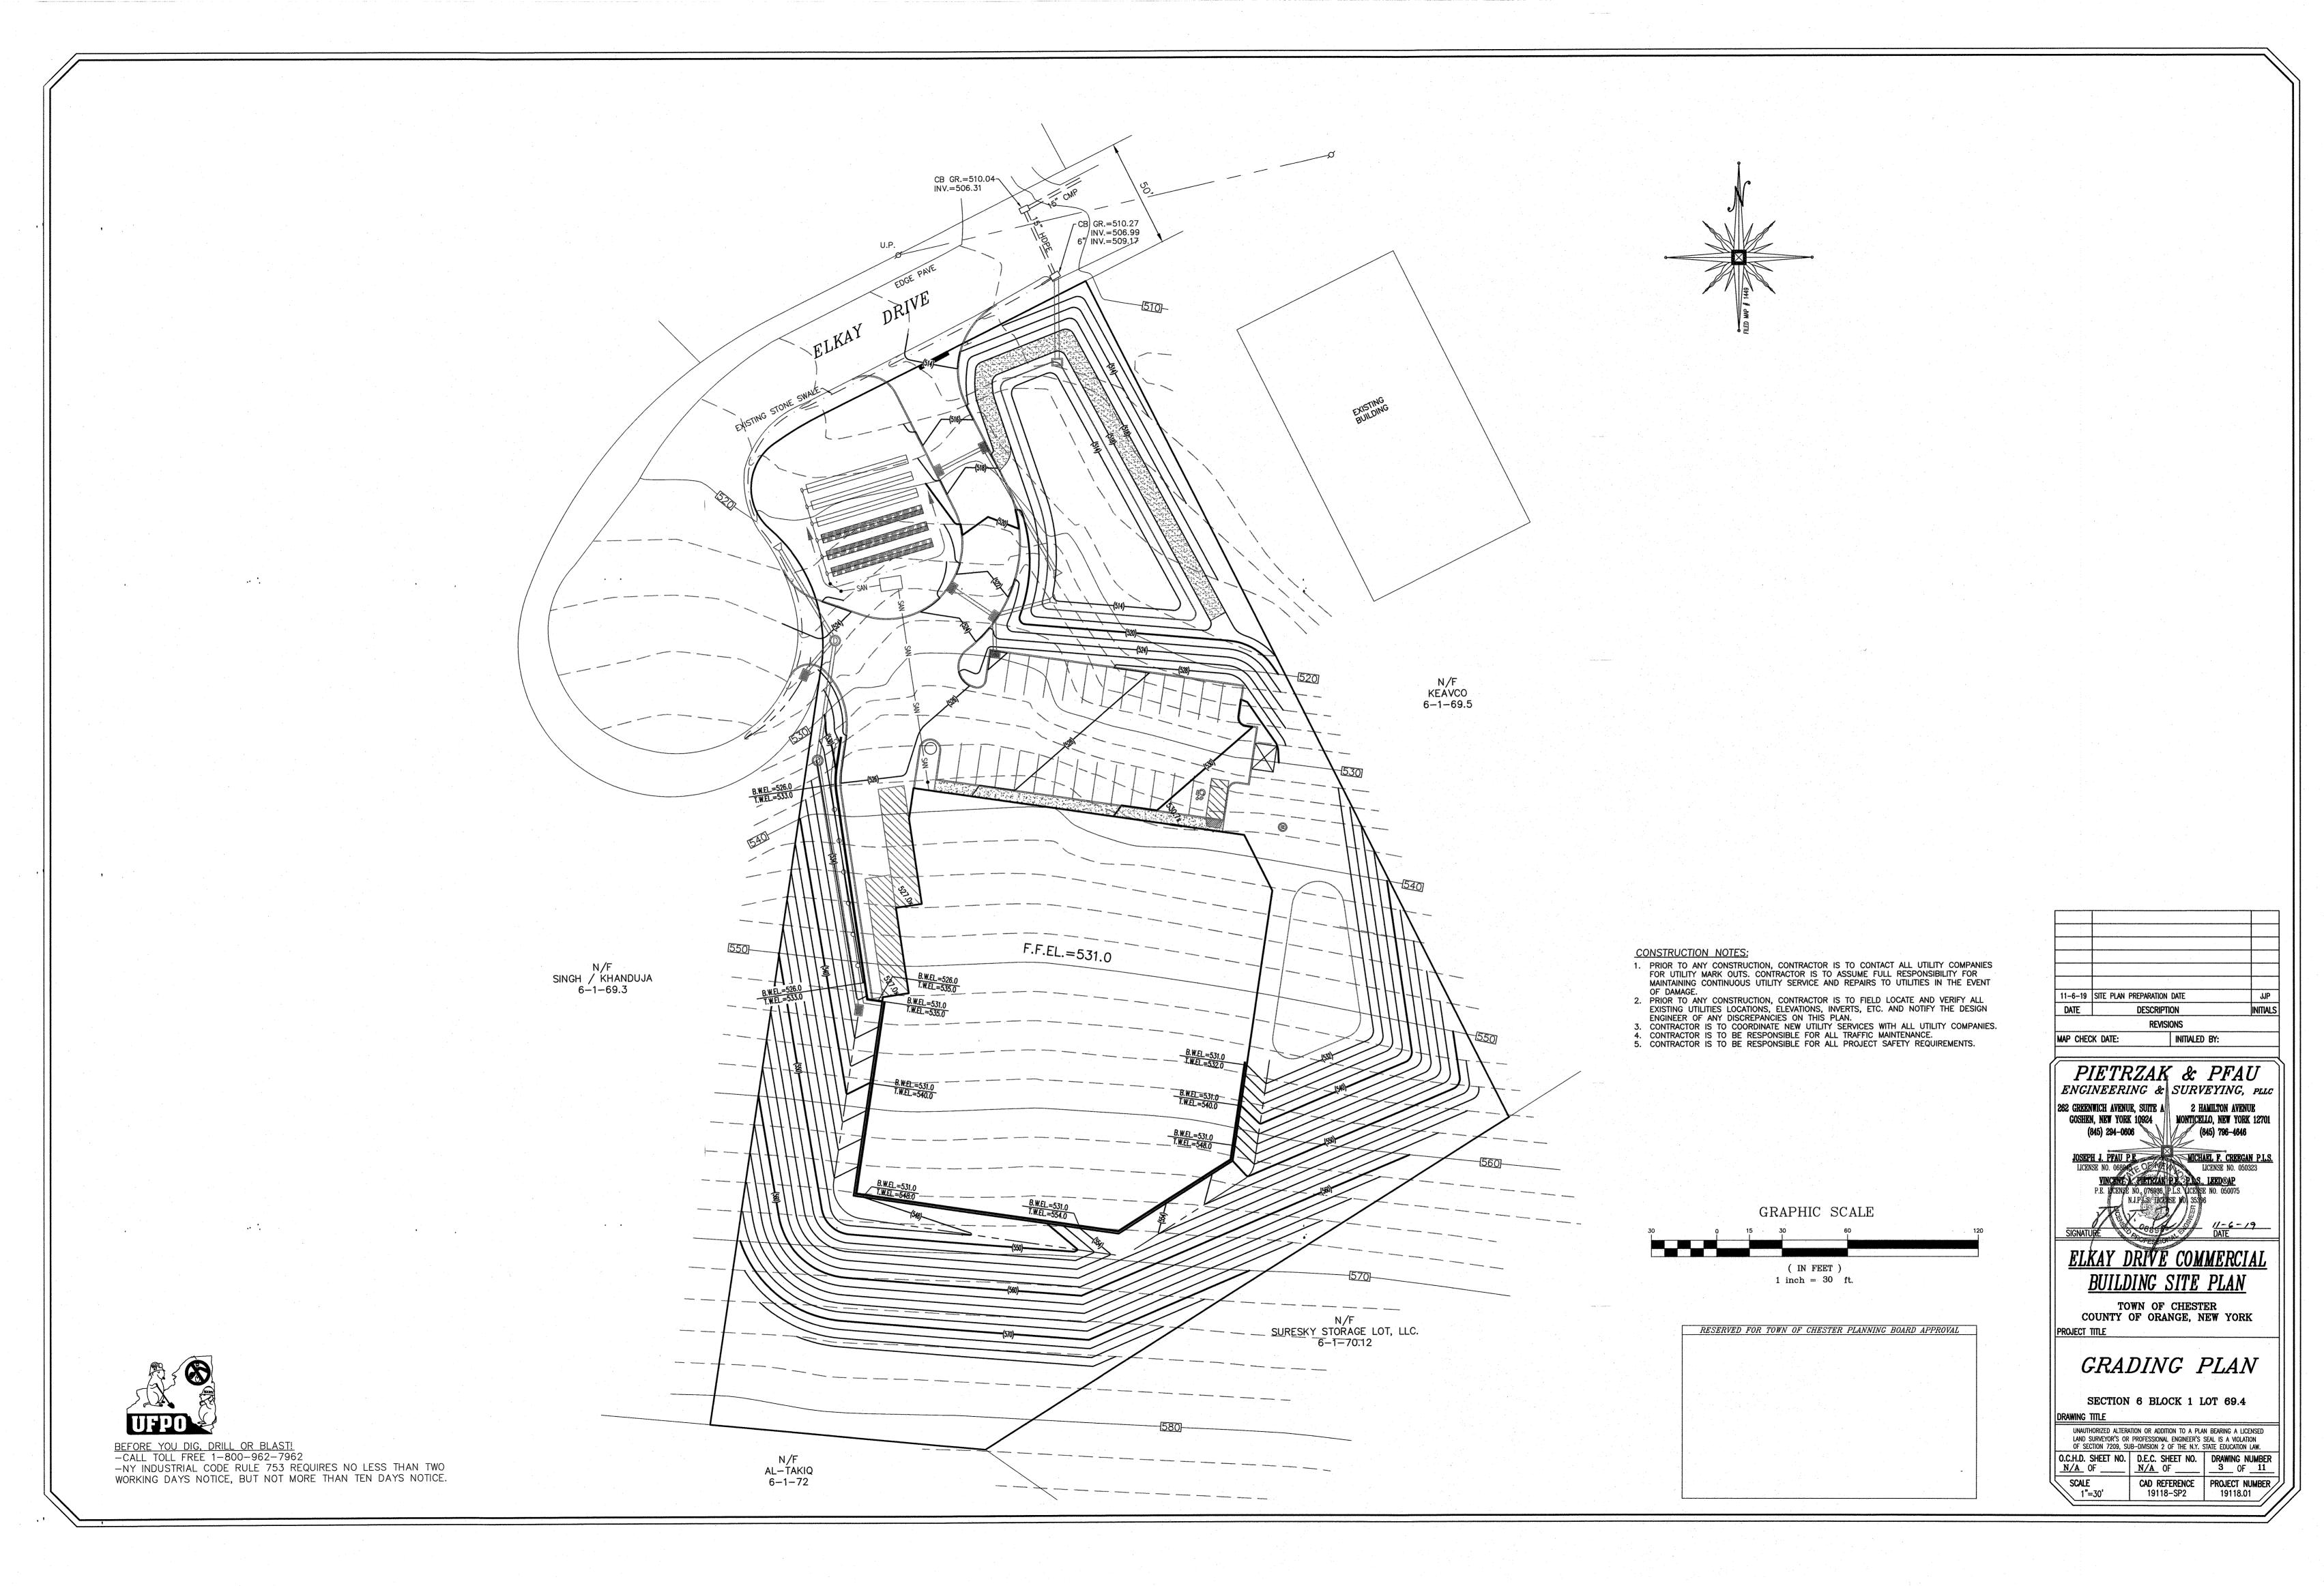

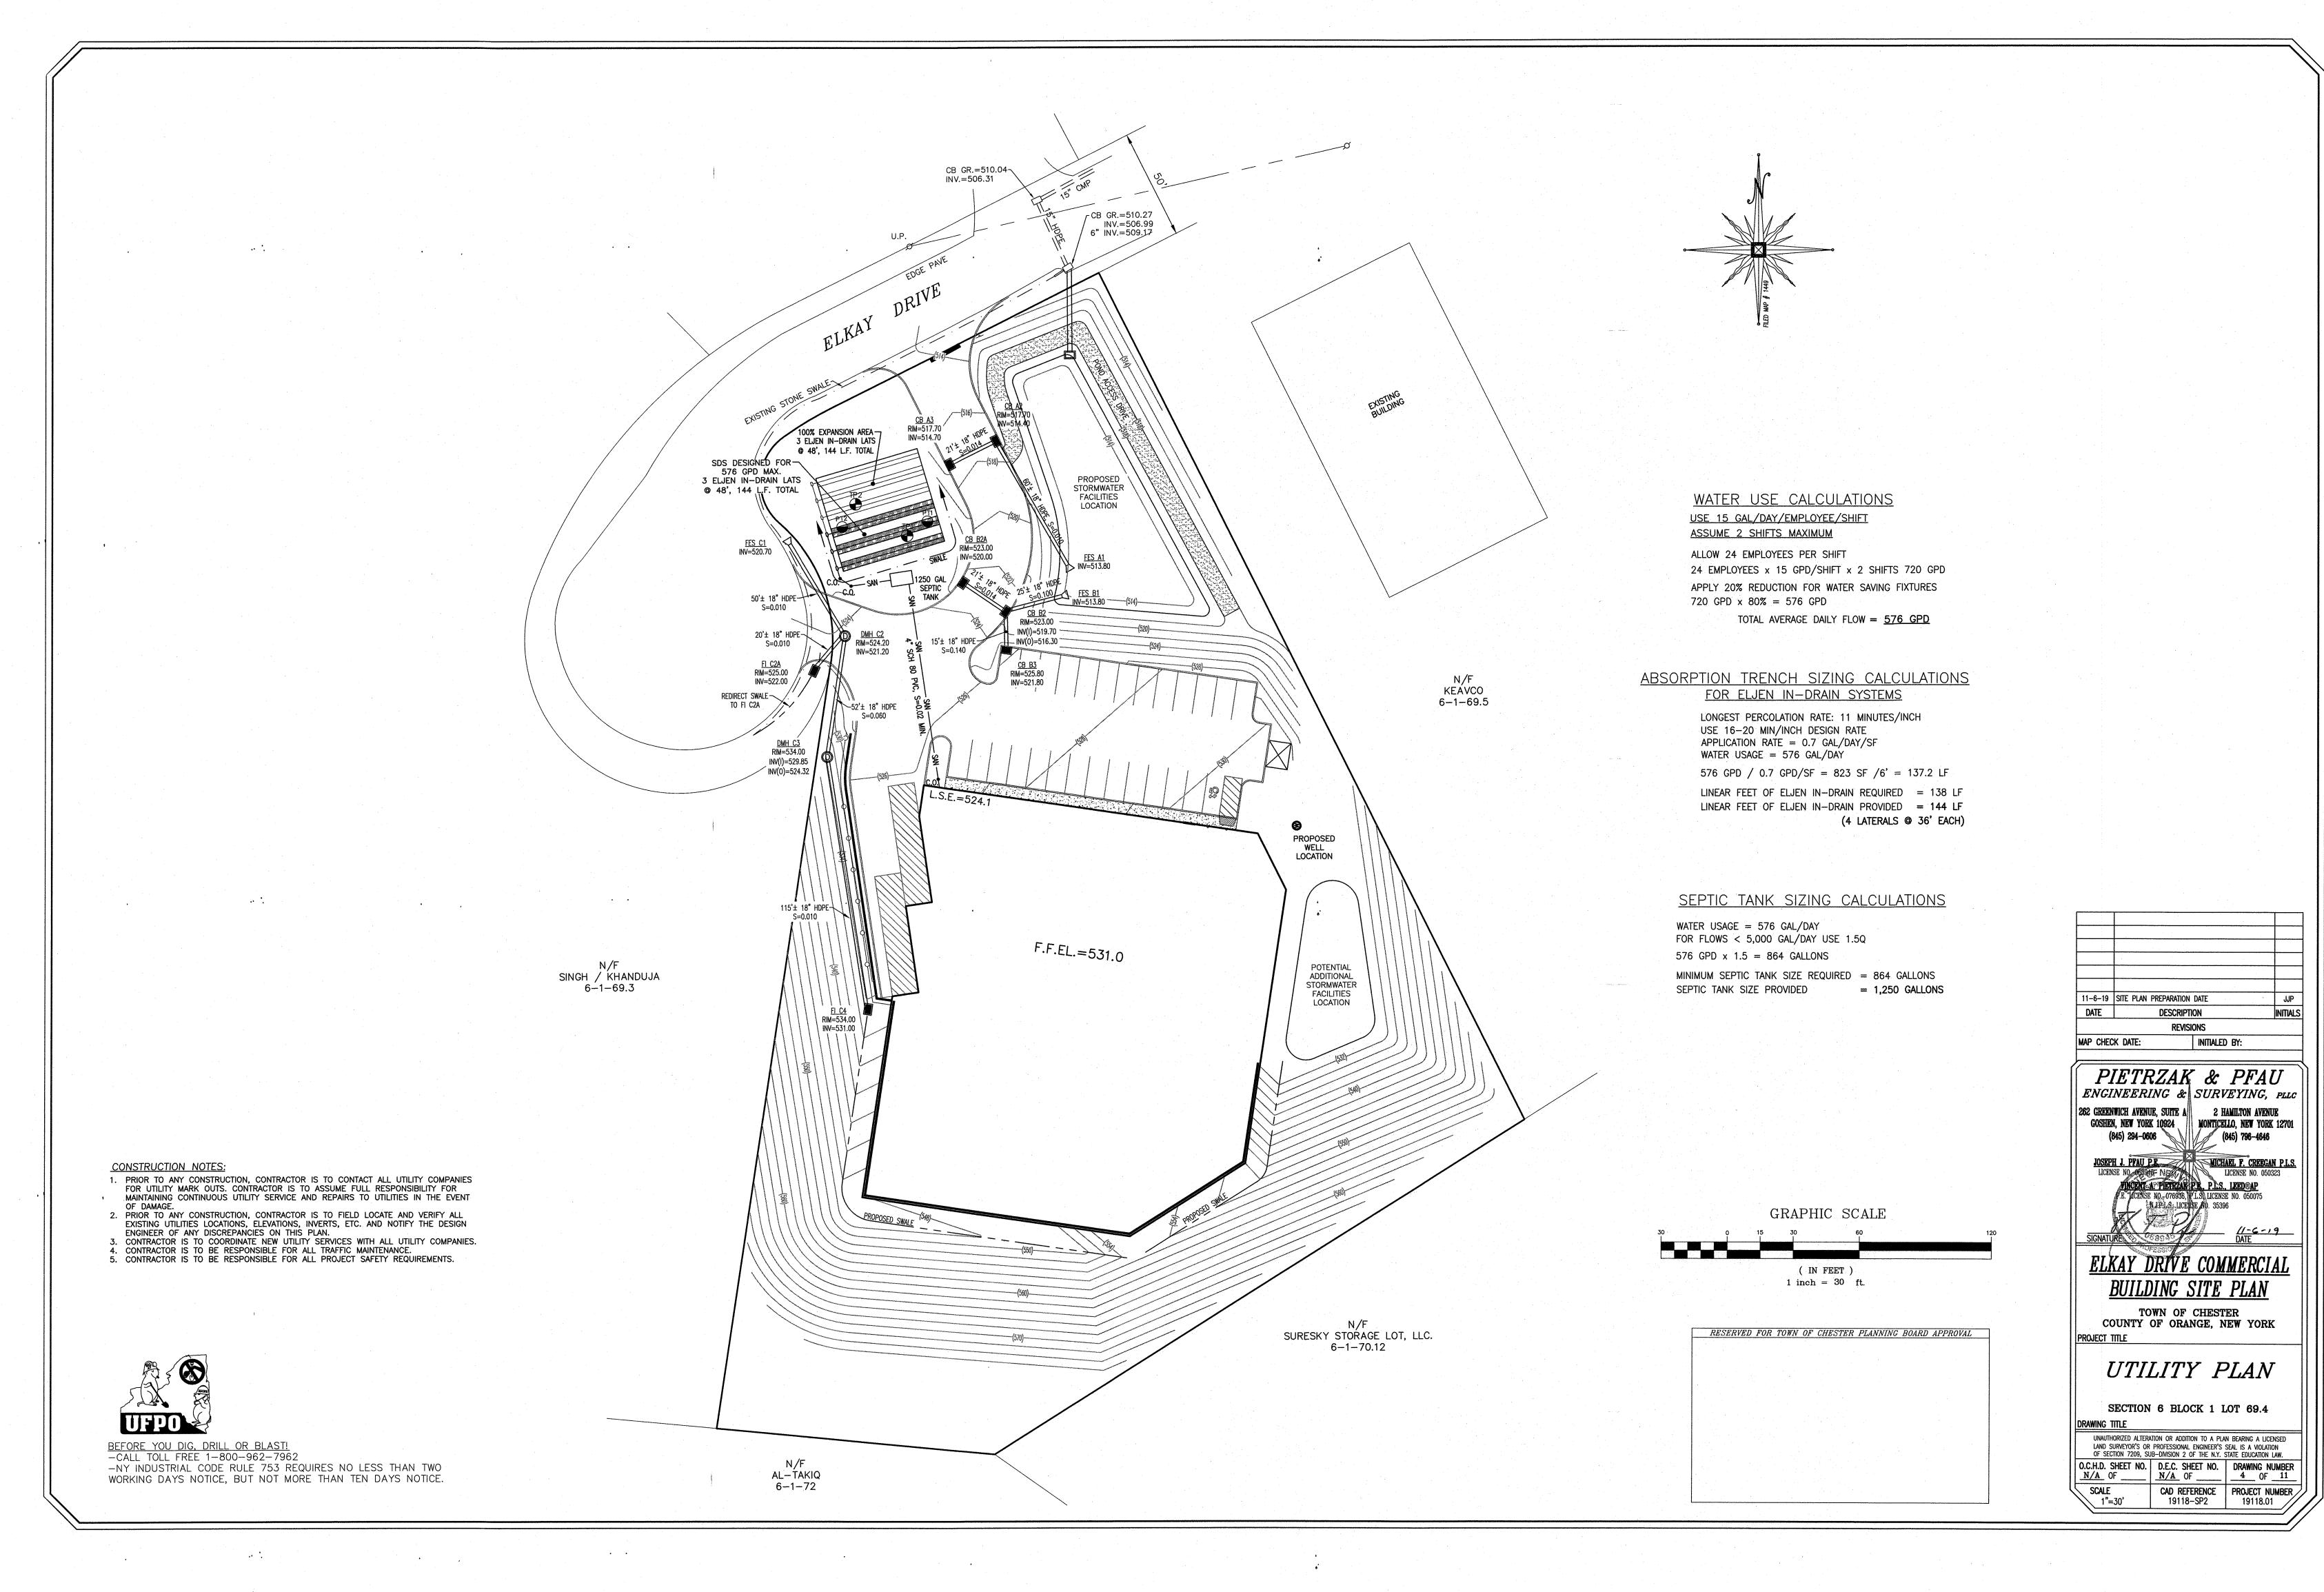

# EROSION CONTROL & CONSTRUCTION SEQUENCE.

MEASURES SHALL BE TAKEN TO PREVENT SOIL EROSION DURING PROJECT CONSTRUCTION. ALL FRESHLY DISTURBED AREAS THAT WILL REMAIN DISTURBED FOR MORE THAN A PERIOD OF FOURTEEN (14) DAYS SHALL BE STABILIZED BY TEMPORARY SEEDING AS INDICATED ON THE TEMPORARY SEEDING SCHEDULE. DISTURBED AREAS SHALL BE MINIMAL IN SIZE AND SHALL NOT EXCEED THE APPROVED CLEARING AND GRADING LIMITS. THE FOLLOWING MEASURES SHALL BE IMPLEMENTED AS

- A. A MEETING WITH TOWN REPRESENTATIVES, INCLUDING THE TOWN ENGINEER, AS WELL AS PROJECT AND SITE CONTRACTORS, PROJECT MANAGER, AND FOREMAN IS
- B. THE OWNER OR OPERATOR MUST MAINTAIN A COPY OF THE NOI, NOI ACKNOWLEDGEMENT LETTER, SWPPP AND INSPECTION REPORTS AT THE CONSTRUCTION SITE. THE DOCUMENTS MUST BE MAINTAINED IN A SECURE LOCATION, SUCH AS A JOB TRAILER, ON-SITE CONSTRUCTION OFFICE, OR MAILBOX WITH LOCK; THAT IS ACCESSIBLE DURING NORMAL WORKING HOURS TO A PERSON PERFORMING A COMPLIANCE INSPECTION.

TO TAKE PLACE A MINIMUM OF ONE WEEK PRIOR TO CONSTRUCTION.

- PRIOR TO COMMENCING CONSTRUCTION ACTIVITIES, THE LIMITS OF CLEARING AND GRADING SHALL BE MARKED. FILTER FABRIC SEDIMENTATION BARRIERS (SILT FENCE) SHALL BE PLACED ALONG THE DOWNGRADE PERIMETER OF THE SITE AND ANY OTHER AREAS WHERE SILT FENCE IS INDICATED AS TO BE INSTALLED "PRIOR TO CONSTRUCTION" ON THE APPROVED PLANS. INSTALLATION IS TO BEGIN AT THE DOWNSTREAM PORTIONS OF THE SITE THEN WORKING UPSTREAM.
- STABILIZED CONSTRUCTION ENTRANCES SHALL BE BUILT IN THE AREAS SHOWN ON THE APPROVED PLANS AND ANYWHERE A CONSTRUCTION ACCESS ROAD INTERSECTS A PUBLIC THOROUGHFARE. STABILIZED ENTRANCES SHALL BE BUILT IN ACCORDANCE WITH THE STABILIZED CONSTRUCTION ENTRANCE DETAIL.
- UPON COMPLETION OF CLEARING AND GRUBBING ACTIVITIES, TOPSOIL SHALL BE STRIPPED AND STOCKPILED FROM ALL AREAS TO BE DISTURBED. STOCKPILED TOPSOIL SHALL BE STABILIZED BY TEMPORARY SEEDING AND SURROUNDED WITH A PERIMETER SILT FENCE.
- TEMPORARY EROSION CONTROL DEVICES SHALL BE INSTALLED PRIOR TO COMMENCING EARTH MOVING ACTIVITIES. THIS INCLUDES SEDIMENTATION TRAPS OR BASINS, TYPE "B" DIVERSION SWALES (WITH CHECK DAMS IF APPLICABLE), AND SILT FENCE. INSTALLATION SHALL BEGIN AT DOWNSTREAM PORTIONS OF THE SITE THEN WORKING UPSTREAM.
- IMMEDIATELY AFTER COMPLETION OF ROUGH GRADING, REMAINING TEMPORARY EROSION CONTROL SHALL BE INSTALLED AS SPECIFIED ON THE APPROVED PLANS. THIS INCLUDES ANY REMAINING SILT FENCE AND TYPE "A" DIVERSION SWALES (WITH CHECK DAMS IF APPLICABLE). AREAS NOT REQUIRING FURTHER EARTHWORK SHALL BE FINE GRADED, TOPSOILED, AND STABILIZED AS EARLY AS POSSIBLE
- ANY PROPOSED STORM DRAINAGE SHALL BE INSTALLED AND INCORPORATED INTO THE EROSION CONTROL AS SPECIFIED ON THE APPROVED PLANS. STORM DRAINAGE COMPONENTS SHALL BE PROTECTED FROM SILTATION AS INDICATED.
- UPON COMPLETION OF CONSTRUCTION ACTIVITIES, REMAINING AREAS SHALL BE FINE GRADED, TOPSOILED, AND STABILIZED. PERMANENT VEGETATION AND
- TEMPORARY EROSION CONTROL DEVICES SHALL BE REMOVED ONCE UPSTREAM AREAS HAVE BEEN PERMANENTLY STABILIZED. REMOVAL OF TEMPORARY EROSION CONTROL DEVICES SHALL BEGIN WITH THE MOST UPSTREAM PORTIONS OF THE SITE THEN WORKING DOWNSTREAM. THE TEMPORARY SEDIMENTATION BASINS ARE TO BE REMOVED, RE-GRADED, AND STABILIZED LAST. ANY SEDIMENTATION BASINS THAT ARE PLANNED TO BE USED AS A FOREBAY FOR A STORMWATER MANAGEMENT DEVICE SHOULD BE CLEANED AND RESHAPED TO THE PROPOSED DIMENSIONS SHOWN ON THE APPROVED PLAN AT THIS TIME.
- K. ALL NEWLY SEEDED VEGETATIVE COVER SHALL BE MAINTAINED. WASHOUTS OR POORLY GROWING AREAS SHALL BE CORRECTED AS THEY OCCUR.

### **WINTER WEATHER STABILIZATION NOTES:**

THE WINTER CONSTRUCTION PERIOD IS CONSIDERED TO BE ALL CONSTRUCTION ACTIVITIES INVOLVED WITH ONGOING LAND DISTURBANCE AND EXPOSURE BETWEEN NOVEMBER 15TH TO THE FOLLOWING APRIL 1ST

- THE OWNER / OPERATOR AND SITE CONTRACTOR SHALL PREPARE A SNOW MANAGEMENT PLAN WITH ADEQUATE STORAGE FOR SNOW AND CONTROL OF MELT WATER, REQUIRING CLEARED SNOW TO BE STORED IN A MANNER NOT AFFECTING ONGOING CONSTRUCTION ACTIVITIES.
- ENLARGE AND STABILIZE ACCESS POINTS TO PROVIDE FOR SNOW MANAGEMENT AND STOCKPILING. SNOW MANAGEMENT ACTIVITIES MUST NOT DESTROY OR DEGRADE INSTALLED EROSION AND SEDIMENT CONTROL PRACTICES.
- 3. A MINIMUM 25 FOOT BUFFER SHALL BE MAINTAINED FROM ALL PERIMETER CONTROLS SUCH AS SILT FENCE. MARK SILT FENCE WITH TALL STAKES THAT ARE VISIBLE ABOVE THE SNOW PACK.
- 4. EDGES OF DISTURBED AREAS THAT DRAIN TO A WATERBODY WITHIN 100 FEET WILL HAVE 2 ROWS OF SILT FENCE, 5 FEET APART, INSTALLED ON THE CONTOUR. 5. DRAINAGE STRUCTURES MUST BE KEPT OPEN AND FREE OF SNOW AND ICE DAMS. ALL DEBRIS, ICE DAMS, OR DEBRIS FROM PLOWING OPERATIONS, THAT
- RESTRICT THE FLOW OF RUNOFF AND MELTWATER, SHALL BE REMOVED.
- SEDIMENT BARRIERS MUST BE INSTALLED AT ALL APPROPRIATE PERIMETER AND SENSITIVE LOCATIONS. SILT FENCE AND OTHER PRACTICES REQUIRING EARTH DISTURBANCE MUST BE INSTALLED BEFORE THE GROUND FREEZES.
- SOIL STOCKPILES MUST BE PROTECTED BY THE USE OF ESTABLISHED VEGETATION, ANCHORED STRAW MULCH, ROLLED STABILIZATION MATTING, OR OTHER
- DURABLE COVERING. A BARRIER MUST BE INSTALLED AT LEAST 15 FEET FROM THE TOE OF THE STOCKPILE TO PREVENT SOIL MIGRATION AND TO CAPTURE LOOSE SOIL IN AREAS WHERE SOIL DISTURBANCE ACTIVITY HAS TEMPORARILY OR PERMANENTLY CEASED, THE APPLICATION OF SOIL STABILIZATION MEASURES SHOULD BE INITIATED BY THE END OF THE NEXT BUSINESS DAY AND COMPLETED WITHIN THREE (3) DAYS. ROLLED EROSION CONTROL BLANKETS MUST BE USED ON ALL
- SLOPES 3 HORIZONTAL TO 1 VERTICAL OR STEEPER. IF STRAW MULCH ALONE IS USED FOR TEMPORARY STABILIZATION, IT SHALL BE APPLIED AT DOUBLE THE STANDARD RATE OF 2 TONS PER ACRE, MAKING THE APPLICATION RATE 4 TONS PER ACRE. OTHER MANUFACTURED MULCHES SHOULD BE APPLIED AT DOUBLE THE MANUFACTURER'S RECOMMENDED RATE.
- 10. TO ENSURE ADEQUATE STABILIZATION OF DISTURBED SOIL IN ADVANCE OF A MELT EVENT, AREAS OF DISTURBED SOIL SHOULD BE STABILIZED AT THE END OF EACH WORK DAY UNLESS:
  - a. WORK WILL RESUME WITHIN 24 HOURS IN THE SAME AREA AND NO PRECIPITATION IS FORECAST OR;
  - b. THE WORK IS IN DISTURBED AREAS THAT COLLECT AND RETAIN RUNOFF, SUCH AS OPEN UTILITY TRENCHES, FOUNDATION EXCAVATIONS, OR WATER MANAGEMENT AREAS
- 11. USE STONE PATHS TO STABILIZE ACCESS PERIMETERS OF BUILDINGS UNDER CONSTRUCTION AND AREAS WHERE CONSTRUCTION VEHICLE TRAFFIC IS ANTICIPATED. STONE PATHS SHOULD BE A MINIMUM 10 FEET IN WIDTH BUT WIDER AS NECESSARY TO ACCOMMODATE EQUIPMENT.

THE SITE SHALL BE INSPECTED FREQUENTLY TO ENSURE THAT THE EROSION AND SEDIMENT CONTROL PLAN IS PERFORMING ITS WINTER STABILIZATION FUNCTION. IF THE SITE WILL NOT HAVE EARTH DISTURBING ACTIVITIES ONGOING DURING THE WINTER SEASON, ALL BARE EXPOSED SOIL MUST BE STABILIZED BY ESTABLISHED VEGETATION, STRAW OR OTHER ACCEPTABLE MULCH, MATTING, ROCK, OR OTHER APPROVED MATERIAL SUCH AS ROLLED EROSION CONTROL PRODUCTS. SEEDING OF AREAS WITH MULCH COVER IS PREFERRED BUT SEEDING ALONE IS NOT ACCEPTABLE FOR PROPER STABILIZATION.

COMPLIANCE INSPECTIONS MUST BE PERFORMED AND REPORTS FILED PROPERLY IN ACCORDANCE WITH THE SWPPP FOR ALL SITES UNDER A WINTER SHUTDOWN.

# GENERAL EROSION CONTROL NOTES AND MAINTENANCE REQUIREMENTS


- THE MAINTENANCE OF EROSION CONTROL DEVICES WILL BE THE RESPONSIBILITY OF THE OWNER/OPERATOR AND SITE CONTRACTOR. THE JOB SUPERINTENDENT WILL MONITOR THE CONDITION OF ALL THE DEVICES, CLEAN OR REPLACE STRUCTURES AS CLIMATIC CONDITIONS REQUIRE. THE OWNER/OPERATOR WILL ALSO BE SUBJECT TO THE DIRECTIVE OF THE DESIGN ENGINEER AND MUNICIPAL REPRESENTATIVES TO INCLUDE MUNICIPAL ENGINEER, HIGHWAY SUPERINTENDENT AND
- ALL CONTRACTORS SHALL PERFORM ALL WORK IN ACCORDANCE WITH THE APPROVED PLANS AND MAY BE SUBJECT TO ADDITIONAL EROSION CONTROL REQUIREMENTS AS CONDITIONS MAY ARISE IN THE FIELD, OR AS DIRECTED BY THE DESIGN ENGINEER AND/OR MUNICIPAL REPRESENTATIVES. THE EROSION CONTROL PLAN IS A "LIVING" DOCUMENT.
- THE CONTRACTOR SHALL MAINTAIN ALL EROSION CONTROL DEVICES IN ACCORDANCE WITH THE APPROVED PLANS, MANUFACTURER'S RECOMMENDATIONS, AND AS DIRECTED BY THE DESIGN ENGINEER AND MUNICIPAL REPRESENTATIVES.
- NO EROSION CONTROL STRUCTURES SHALL BE REMOVED UNTIL ALL WORK UPSTREAM THEREFROM HAS BEEN COMPLETED. INCLUDING STABILIZATION, AND APPROVED BY THE DESIGN ENGINEER AND MUNICIPAL REPRESENTATIVES.
- WHEREVER FEASIBLE, NATURAL VEGETATION SHOULD BE RETAINED AND PROTECTED.
- ONLY THE SMALLEST PRACTICAL AREA OF LAND SHOULD BE EXPOSED AT ANY ONE TIME DURING CONSTRUCTION.
- WHEN LANDS IS DISTURBED DURING CONSTRUCTION, THE EXPOSURE SHALL BE KEPT TO THE SHORTEST PRACTICAL PERIOD OF TIME.
- ALL CONSTRUCTION EQUIPMENT SHALL HAVE PROPERLY SIZED AND MAINTAINED MUFFLERS.
- ALL CONSTRUCTION EQUIPMENT SHALL BE TURNED OFF WHEN NOT IN USE.
- FILTER FABRIC IS TO BE MIRAFI 140, AS MANUFACTURED BY THE CELANESE CORPORATION, OR APPROVED EQUAL.

## STREAMS, DRAINAGE SWALES, AND EMBANKMENTS

- ALL CONSTRUCTION ACTIVITIES IN OR EXISTING AROUND DRAINAGE SWALES OR WETLANDS ARE TO BE PROVIDED WITH TEMPORARY EROSION CONTROL STRUCTURES AS SHOWN IN DETAIL, LOCATED IMMEDIATELY DOWNSTREAM FROM SUCH ACTIVITY. THESE STRUCTURES ARE TO BE IN PLACE AS SHOWN PRIOR TO THE START OF ANY UP-STREAM CONSTRUCTION ACTIVITY.
- CONSTRUCTION EQUIPMENT SHALL NOT UNNECESSARILY CROSS LIVE STREAMS OR DRAINAGE SWALES EXCEPT BY MEANS OF BRIDGES AND CULVERTS OR OTHER APPROVED METHODS.
- ALL EMBANKMENTS TO BE GRADED AND SEEDED IMMEDIATELY UPON BEING LAID BACK.
- STABILIZATION OF THE SWALES WILL INCLUDE SEEDING AND STRAW MULCH ON SLOPES LESS THAN 5% AND JUTE NETTING OR EQUAL ON SLOPES EXCEEDING 5%.
- TOPSOIL AND/OR EARTH STOCKPILE SHALL BE LOCATED OUTSIDE OF EXISTING DRAINAGE SWALES, WETLANDS AND ADJACENT AREAS. SILT FENCES WILL BE PLACED ALONG THE TOE OF THE PILES AND THESE PILES SHALL RECEIVE TEMPORARY SEEDING.



-CALL TOLL FREE 1-800-962-7962 -NY INDUSTRIAL CODE RULE 753 REQUIRES NO LESS THAN TWO WORKING DAYS NOTICE, BUT NOT MORE THAN TEN DAYS NOTICE.

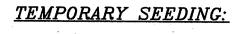

TEMPORARY SEEDING SHALL BE APPLIED ON CONSTRUCTION SITES TO PROTECT AN AREA, OR SECTION, WHERE FINAL GRADING IS COMPLETE, WHEN PREPARING FOR WINTER WORK SHUTDOWN, OR TO PROVIDE COVER WHEN PERMANENT SEEDINGS AREA LIKELY TO FAIL DUE TO MID-SUMMER HEAT AND DROUGHT. WATER MANAGEMENT PRACTICES MUST BE INSTALLED AS APPROPRIATE FOR SITE CONDITIONS. THE AREA MUST BE ROUGH GRADED AND SLOPES PHYSICALLY STABLE. LARGE DEBRIS AND ROCKS ARE USUALLY REMOVED. SEEDBED MUST BE SEEDED WITHIN 24 HOURS OF DISTURBANCE OR SCARIFICATION OF THE SOIL SURFACE WILL BE NECESSARY PRIOR TO SEEDING.

- SEED MIX (SPRING, SUMMER OR EARLY FALL) RYEGRASS (ANNUAL OR PERENNIAL) AT 30LBS/ACRE OR 0.7LB/1000 SQFT
- SEED MIX (LATE FALL OR EARLY WINTER)
- CERTIFIED 'AROOSTOOK' WINTER RYE (CEREAL RYE) AT 100LBS/ACRE OR 2.5LBS/1000 SQFT
- MULCH THE AREA WITH STRAW AT 2 TONS/ACRE (90LBS/1000SQFT OR 2 BALES). MULCH ANCHORING WILL BE REQUIRED WHERE WIND OR AREAS OF CONCENTRATED WATER ARE OF CONCERN. WOOD FIBER HYDROMULCH OR OTHER SPRAYABLE PRODUCTS APPROVED FOR EROSION CONTROL (NYLON WEB OR MESH) MAY BE USED IF APPLIED ACCORDING TO MANUFACTURERS' SPECIFICATIONS. CAUTION IS ADVISED WHEN USING NYLON OR OTHER SYNTHETIC PRODUCTS, AS THEY MAY BE DIFFICULT TO REMOVE PRIOR TO FINAL SEEDING.

#### PERMANENT SEEDING:

ALL WATER CONTROL MEASURES WILL BE INSTALLED AS NEEDED PRIOR TO FINAL GRADING AND SEEDBED PREPARATION. ANY SEVERELY COMPACTED SECTIONS WILL REQUIRE CHISELING OR DISKING TO PROVIDE AN ADEQUATE ROOTING ZONE, TO A MINIMUM DEPTH OF 12", PER THE SOIL RESTORATION STANDARD PROVIDED IN THE NEW YORK STATE STANDARDS AND SPECIFICATIONS FOR EROSION AND SEDIMENT CONTROL DATED NOVEMBER 2016. THE SEEDBED MUST BE PREPARED TO ALLOW GOOD SOIL TO SEED CONTACT, WITH THE SOIL NOT TOO SOFT AND NOT TOO COMPACT. ADEQUATE SOIL MOISTURE MUST BE PRESENT TO ACCOMPLISH THIS. IF SURFACE IS POWDER DRY OR STICKY WET, POSTPONE OPERATIONS UNTIL MOISTURE CHANGES TO A FAVORABLE CONDITION. IF SEEDING IS ACCOMPLISHED WITHIN 24 HOURS OF FINAL GRADING, ADDITIONAL SCARIFICATION IS GENERALLY NOT NEEDED, ESPECIALLY ON DITCH AND STREAM BANKS. REMOVE ALL STONES OR OTHER DEBRIS FROM THE SURFACE THAT ARE GREATER THAN 4 INCHES, OR THAT WILL INTERFERE WITH FUTURE MOWING OR MAINTENANCE.

SOIL AMENDMENTS SHOULD BE INCORPORATED INTO THE UPPER 2 INCHES OF SOIL WHEN FEASIBLE. SOIL SHOULD BE TESTED TO DETERMINE THE AMOUNTS OF AMENDMENTS NEEDED. APPLY GROUND AGRICULTURAL LIMESTONE TO ATTAIN A PH OF 6.0 IN THE UPPER 2 INCHES OF SOIL. FERTILIZER SHOULD BE APPLIED IN ACCORDANCE WITH SOIL TESTING. IF SOIL MUST BE FERTILIZED BEFORE RESULTS OF A SOIL TEST CAN BE OBTAINED TO DETERMINE FERTILIZER NEEDS, APPLY COMMERCIAL FERTILIZER AT 600 LBS. PER ACRE OF 5-5-10 OR EQUIVALENT. IF MANURE IS USED, APPLY A QUANTITY TO MEET THE NUTRIENTS OF THE ABOVE FERTILIZER. THIS REQUIRES AN APPROPRIATE MANURE ANALYSIS PRIOR TO APPLYING TO THE SITE. DO NOT USE MANURE ON SITES TO BE PLANTED WITH TREFOIL OR IN THE PATH OF CONCENTRATED WATER FLOW.

THE OPTIMUM TIMING FOR PERMANENT SEEDING IS EARLY SPRING. PERMANENT SEEDING MAY BE MADE ANY TIME OF YEAR IF PROPERLY MULCHED AND ADEQUATE MOISTURE IS PROVIDED. LATE JUNE THROUGH EARLY AUGUST IS NOT A GOOD TIME TO SEED, BUT MAY FACILITATE COVERING THE LAND WITHOUT ADDITIONAL DISTURBANCE IF CONSTRUCTION IS COMPLETED. PORTIONS OF THE SEEDING MAY FAIL DUE TO DROUGHT AND HEAT. THESE AREAS MAY NEED RESEEDING IN LATE SUMMER/FALL OR THE FOLLOWING SPRING.

BROADCASTING, DRILLING, CULTIPACK TYPE SEEDING, OR HYDROSEEDING ARE ACCEPTABLE METHODS. PROPER SOIL TO SEED CONTACT IS

MULCHING IS ESSENTIAL TO OBTAIN A UNIFORM STAND OF SEEDED PLANTS. OPTIMUM BENEFITS OF MULCHING NEW SEEDINGS ARE OBTAINED WITH THE USE OF SMALL GRAIN STRAW APPLIED AT A RATE OF 2 TONS PER ACRE, AND ANCHORED WITH A NETTING OR TACKIFIER. APPLY STRAW (CEREAL GRAIN) MULCH AFTER SOIL AMENDMENTS AND PLANTING IS ACCOMPLISHED OR SIMULTANEOUSLY IF HYDROSEEDING IS USED. APPLY STRAW MULCH AT 2 TON/ACRE (90LBS/1000SQFT) AND ANCHORED WITH WOOD FIBER MULCH (HYDROMULCH) AT 500-750 LBS/ACRE (11-17 LBS/1000SQFT). THE WOOD FIBER MULCH MUST BE APPLIED THROUGH A HYDROSEEDER IMMEDIATELY AFTER MULCHING.

WATERING MAY BE ESSENTIAL TO ESTABLISH A NEW SEEDING WHEN A DROUGHT CONDITION OCCURS SHORTLY AFTER A NEW SEEDING

THE OPTIMUM TIMING FOR PERMANENT SEEDING IS EARLY SPRING. LATE JUNE THROUGH EARLY AUGUST IS NOT A GOOD TIME TO SEED DUE TO DROUGHT AND HEAT. PERMANENT SEED MIXTURES SHOULD NOT BE USED DURING WINTER/COLD WEATHER MONTHS.

GENERAL SEED MIX:	VARIETY	LBS. / ACRE	LBS. / 1000 SQ.F
RED CLOVER OR ACC	CLAIM, RALLY, RED HEAD II, RENEGADE	8 <sup>2</sup>	0.20
COMMON WHITE CLOVER1	COMMON	8	0.20
PLUS			
CREEPING RED FESCUE	COMMON	20	0.45
<u>PLUS</u>			
SMOOTH BROMEGRASS OR	COMMON	2	0.05
RYEGRASS (PERENNIAL)	PENNFINE / LINN	5	0.10
<sup>1</sup> ADD INOCULANT IMMEDIATELY PR <sup>2</sup> MIX 4 LBS EACH OF EMPIRE AN	RIOR TO SEEDING  ND PARDEE OR 4 LBS OF BIRDSFOOT	AND 4 LRS WHITE	

CLOVER PER ACRE. ALL SEEDING RATES ARE GIVEN FOR PURE LIVE SEED (PLS)

KEAVCO

6-1-69.5

**CONSTRUCTION NOTES:** PRIOR TO ANY CONSTRUCTION, CONTRACTOR IS TO CONTACT ALL UTILITY COMPANIES FOR UTILITY MARK OUTS. CONTRACTOR IS TO ASSUME FULL RESPONSIBILITY FOR MAINTAINING CONTINUOUS UTILITY SERVICE AND REPAIRS TO UTILITIES IN THE EVENT PRIOR TO ANY CONSTRUCTION, CONTRACTOR IS TO FIELD LOCATE AND VERIFY ALL EXISTING UTILITIES LOCATIONS, ELEVATIONS, INVERTS, ETC. AND NOTIFY THE DESIGN

ENGINEER OF ANY DISCREPANCIES ON THIS PLAN. CONTRACTOR IS TO COORDINATE NEW UTILITY SERVICES WITH ALL UTILITY COMPANIES. CONTRACTOR IS TO BE RESPONSIBLE FOR ALL TRAFFIC MAINTENANCE. 5. CONTRACTOR IS TO BE RESPONSIBLE FOR ALL PROJECT SAFETY REQUIREMENTS.

( IN FEET

1 inch = 30 ft.

RESERVED FOR TOWN OF CHESTER PLANNING BOARD APPROVAL

11-6-19 SITE PLAN PREPARATION DATE JJP DESCRIPTION INITIALS REVISIONS MAP CHECK DATE: INITIALED BY:

PIETRZAK & PFAU ENGINEERING & SURVEYING, PLL 262 GREENWICH AVENUE, SUITE A 2 HAMILTON AVENUE GOSHEN, NEW YORK 10924 MONTICELLO, NEW YORK 12701

(845) 796-4646 MICHAEL F. CREEGAN P.L.S VINCENT A. FIETRŽAK P.E., P.LS., LEED®AP LICENSE NO. 076986, P.L.S. LICENSE NO. 05007 N.J.P.L.S. LICE SE NO. 35396


ELKAY DRIVE COMMERCIA BUILDING SITE PLAN

TOWN OF CHESTER COUNTY OF ORANGE, NEW YORK

**EROSION** CONTROL PLAN

SECTION 6 BLOCK 1 LOT 69.4

UNAUTHORIZED ALTERATION OR ADDITION TO A PLAN BEARING A LICENSED LAND SURVEYOR'S OR PROFESSIONAL ENGINEER'S SEAL IS A VIOLATION OF SECTION 7209, SUB-DIVISION 2 OF THE N.Y. STATE EDUCATION LAW. O.C.H.D. SHEET NO. | D.E.C. SHEET NO. | DRAWING NUMBER <u>N/A</u> OF \_\_\_\_\_ | <u>N/A</u> OF \_\_\_\_\_ |

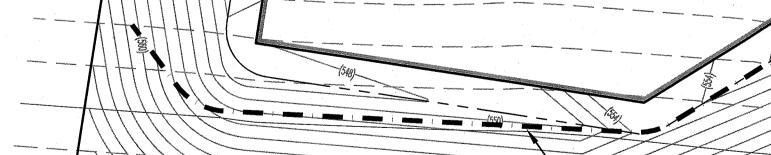

2H: 1V SLOPE TO BE STABILIZED BY SLOPE STABILIZATION BLANKETS (SEE DETAIL)

AL-TAKIQ

6 - 1 - 72

STABILIZED-

CONSTRUCTION

**ENTRANCE** 

TEMPORARY-

CULVERT

SOIL STOCKPILE

AREA (TYP.)

TEMPORARY

CULVERT

STABILIZED

CONSTRUCTION

**ENTRANCE** 

PROPOSED -

DIVERSION

SWALE (TYP.)

550

SINGH / KHANDUJA

6-1-69.3

PROPOSED

DIVERSION

SWALE (TYP.

SURESKY STORAGE LOT, LLC

6-1-70.12

5101

-PROPOSED

PROTECTION !

PROPOSED

SILT FENCE

(TYP.)

PROPOSED

STAGING

AREA

-UTILIZE PROPOSED BASIN

AS SEDIMENT BASIN W/


TEMPORARY RISER.

(SEE DETAILS)

1"=30"

19118-SP2

CAD REFERENCE | PROJECT NUMBER 19118.01

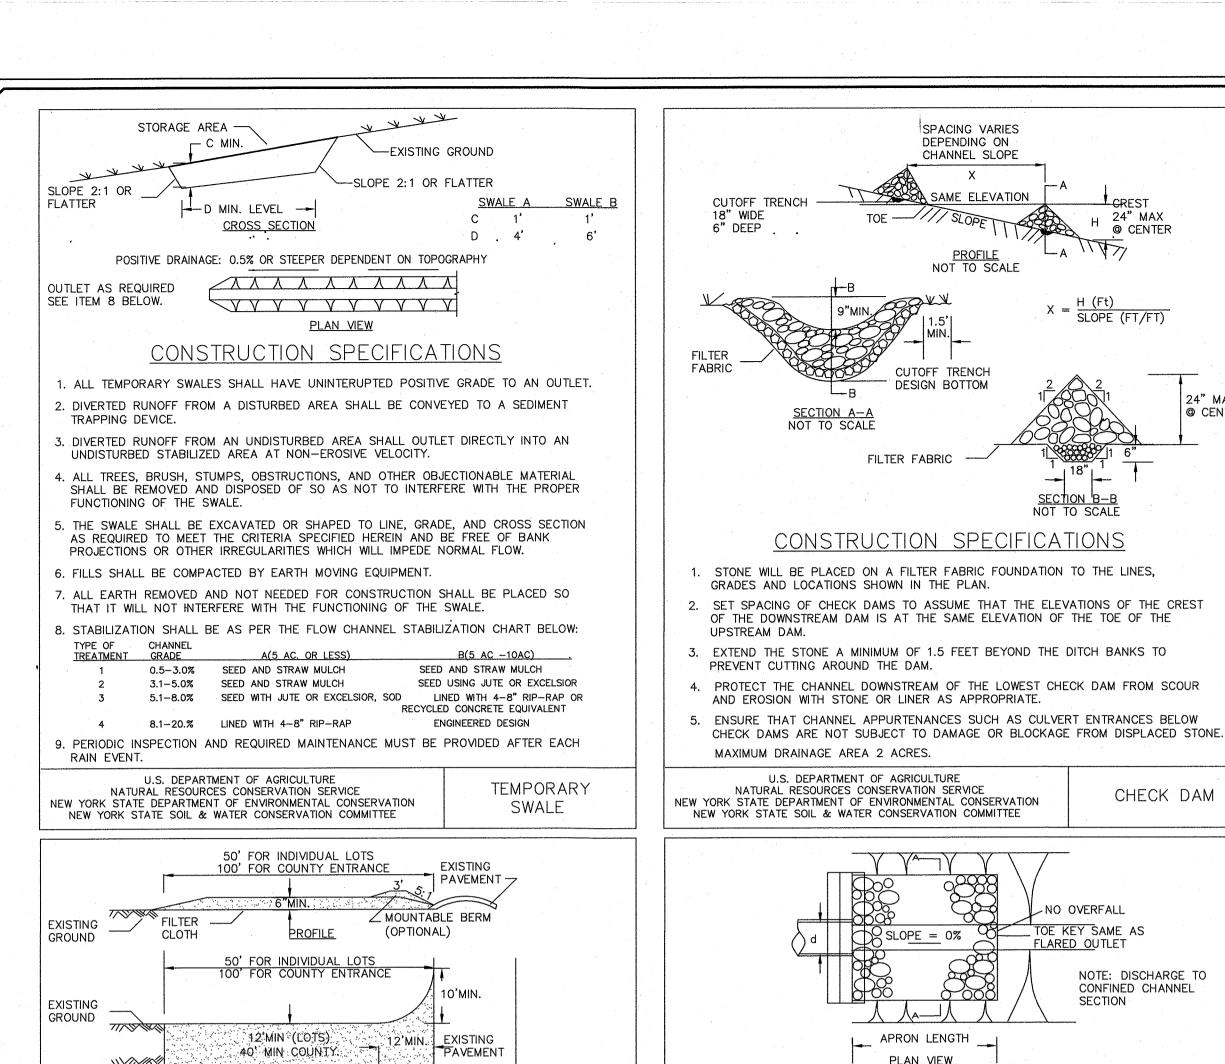

CONSTRUCTION SPECIFICATIONS

1. STONE SIZE - USE 2" STONE, OR RECLAIMED OR RECYCLED CONCRETE EQUIVALENT. 2 IFNOTH - NOT IFSS THAN 50 FEET (EXCEPT ON A SINGLE RESIDENCE LOT WHERE

4. WIDTH - TWELVE (12) FOOT MINIMUM, BUT NOT LESS THAN THE FULL WIDTH AT

5. FILTER CLOTH - WILL BE PLACED OVER THE ENTIRE AREA PRIOR TO PLACING

6. SURFACE WATER — ALL SURFACE WATER FLOWING OR DIVERTED TOWARD CON—

IMPRACTICAL, A MOUNTABLE BERM WITH 5:1 SLOPES WILL BE PERMITTED.

8. WHEN WASHING IS REQUIRED, IT SHALL BE DONE ON A AREA STABILIZED WITH

STONE AND WHICH DRAINS INTO AN APPROVED SEDIMENT TRAPPING DEVICE.

U.S. DEPARTMENT OF AGRICULTURE

NATURAL RESOURCES CONSERVATION SERVICE

NEW YORK STATE SOIL & WATER CONSERVATION COMMITTEE

NEW YORK STATE DEPARTMENT OF ENVIRONMENTAL CONSERVATION

9. PERIODIC INSPECTION AND NEEDED MAINTENANCE SHALL BE PROVIDED AFTER EACH

STRUCTION ENTRANCES SHALL BE PIPED ACROSS THE ENTRANCE. IF PIPING IS

. MAINTENANCE - THE ENTRANCE SHALL BE MAINTAINED IN A CONDITION WHICH WILL

PREVENT TRACKING OR FLOWING OF SEDIMENT ONTO PUBLIC RIGHTS-OF-WAY, ALL

SEDIMENT SPILLED, DROPPED, WASHED OR TRACTED ONTO PUBLIC RIGHTS-OF-WAY


POINTS WHERE INGRESS OR EGRESS OCCURS. TWENTY-FOUR (24) FOOT IF SINGLE

A 30 FOOT MINIMUM LENGTH WOULD APPLY).

ENTRANCE TO SITE.

MUST BE REMOVED IMMEDIATELY.

i. THICKNESS — NOT LESS THAN SIX (6) INCHES.

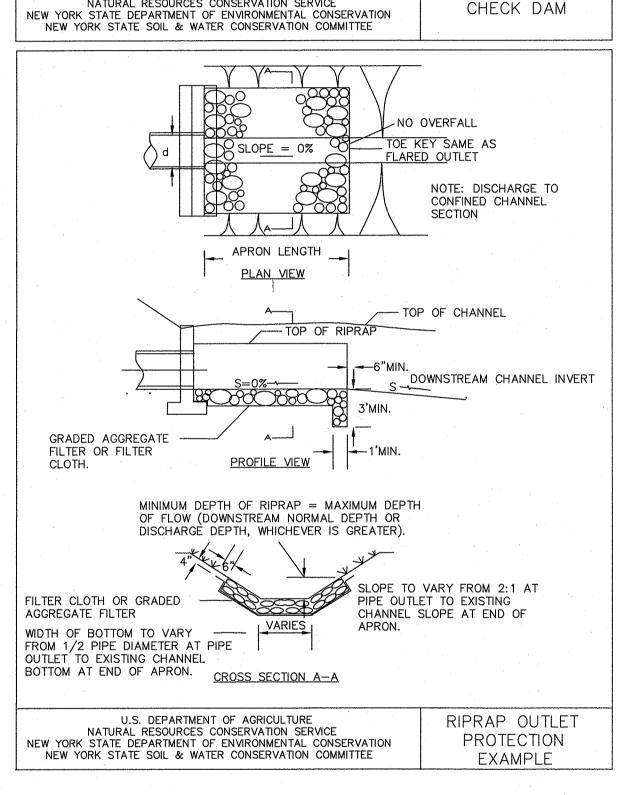

DEPENDING ON

TOE ---///

CHANNEL SLOPE

<u>PROFILE</u> NOT TO SCALE

CUTOFF TRENCH

DESIGN BOTTOM

CONSTRUCTION SPECIFICATIONS

FILTER FABRIC ---


U.S. DEPARTMENT OF AGRICULTURE


© CENTER


24" MAX

@ CENTER

 $X = \frac{H (Ft)}{SLOPE (FT/FT)}$ 

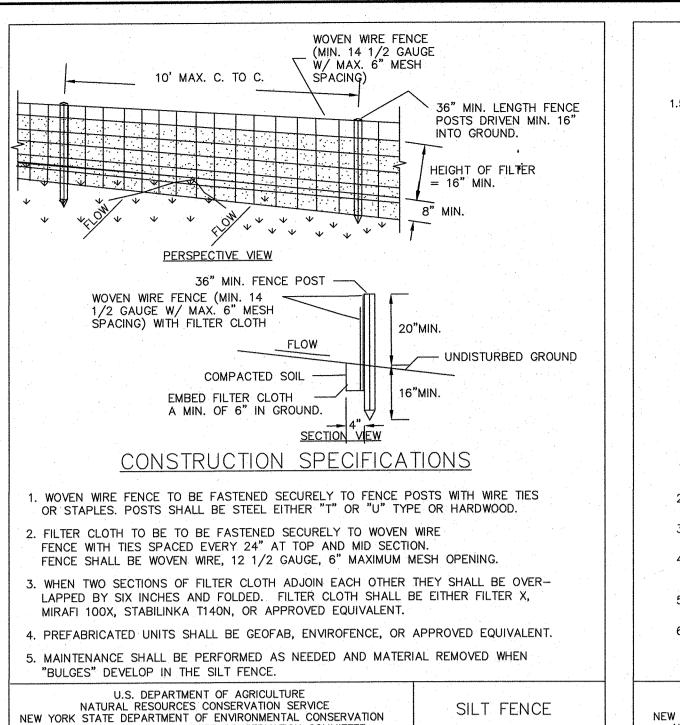

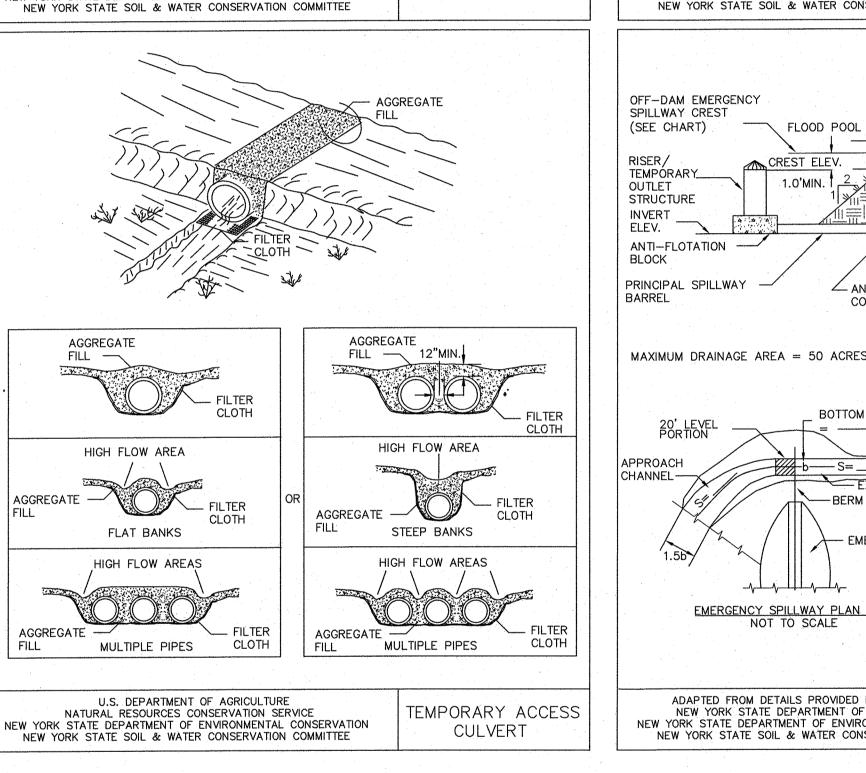

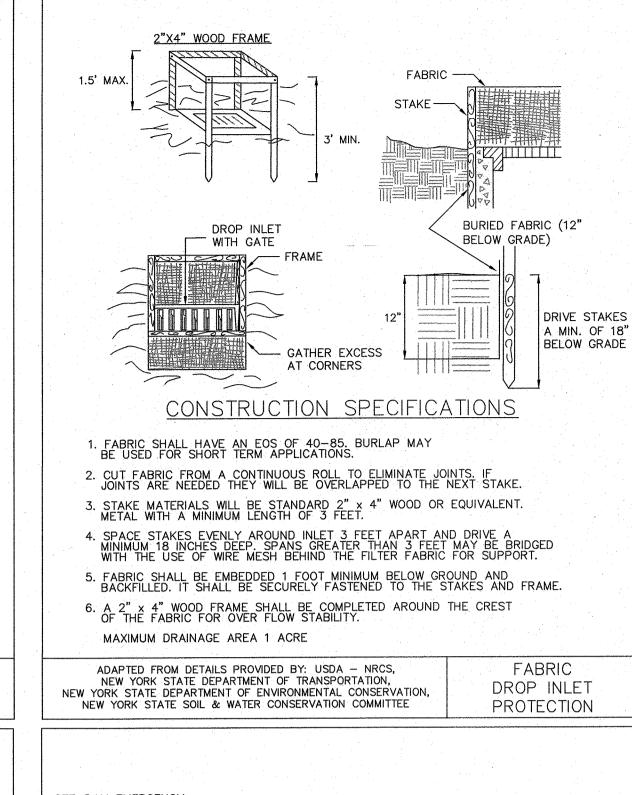

TOP WIDTH

CUTOFF -

∠ ANTI-SEEP

-BERM

EMERGENCY SPILLWAY PLAN VIEW

**EMBANKMENT** 

TRENCH 4.0'MIN.

BOTTOM WIDTH FLOOD POOL

20'MINIMUM

2.0'MIN.

FLOOD POOL -

CREST ELEV.

TOP ELEV.

FREEBOARD 1.0'MIN.

(SEE CHART)

ELEVATION OF

FREEBOARD 1.0'MIN.


LEVEL SECTION / EXIT SECTION -

PROFILE ALONG C OF SPILLWAY


BOTTOM WIDTH 1 F

CROSS SECTION AT CONTROL SECTION

NOT TO SCALE

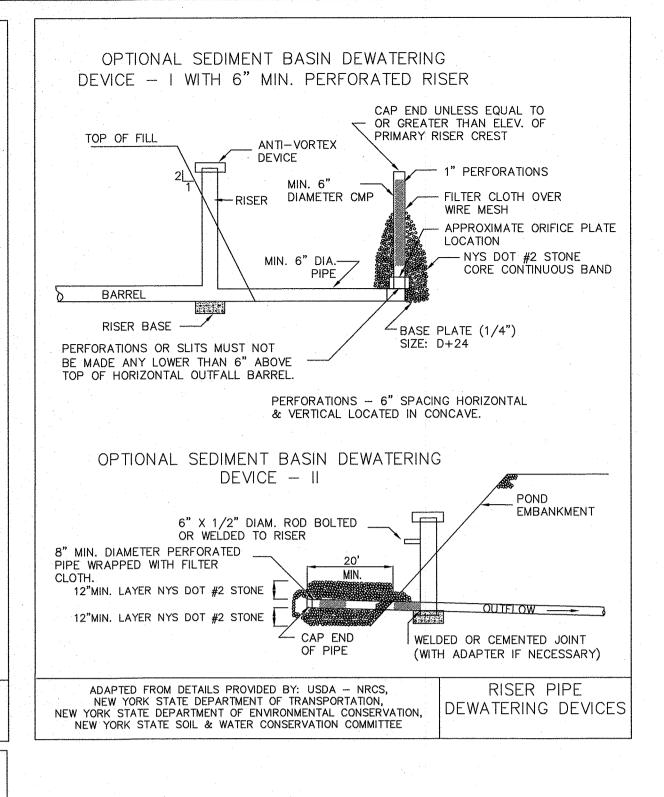

	SEDIME	ENT BASIN DI	ESIGN INFORMA	ATION TABLE	:
BASIN #	DRAINAGE AREA (AC.)	SEDIMENT ZONE VOL. REQ. (CU.FT.)	SEDIMENT ZONE VOL. PROVIDED (CU.FT.)	DEWATERING ZONE VOL. REQ. (CU.FT.)	DEWATERING ZONE VOL. PROVIDED (CU.FT.)
. 1	3.2	3,200	xxxxx	11,520	XXXXX

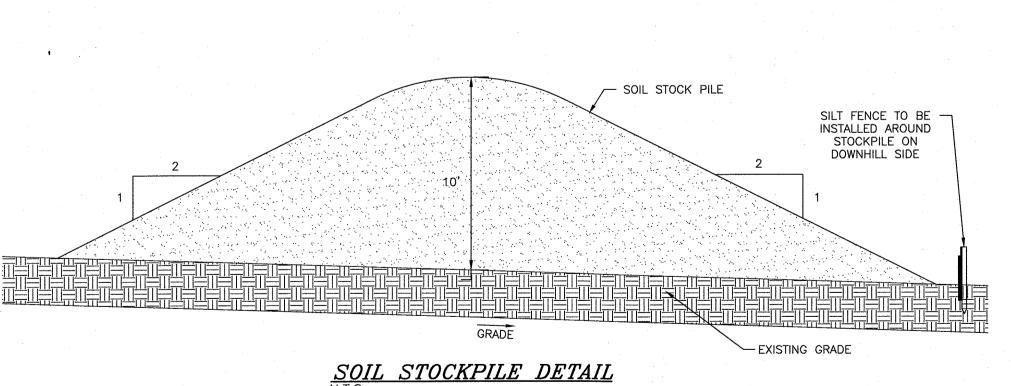


STABILIZED

CONSTRUCTION

ENTRANCE




-CALL TOLL FREE 1-800-962-7962 -NY INDUSTRIAL CODE RULE 753 REQUIRES NO LESS THAN TWO WORKING DAYS NOTICE, BUT NOT MORE THAN TEN DAYS NOTICE.

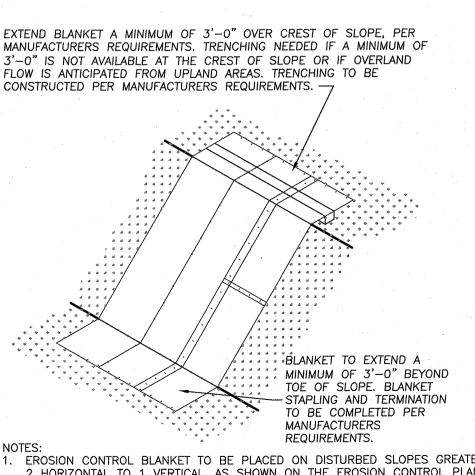

1. EROSION CONTROL BLANKET TO BE PLACED ON DISTURBED SLOPES GREATER THAN 2 HORIZONTAL TO 1 VERTICAL, AS SHOWN ON THE EROSION CONTROL PLAN. 2. FOR SLOPES OF 2H:1V -- EROSION CONTROL BLANKET TO BE CURLEX I (EXCELSIOR EROSION CONTROL BLANKETS) OR APPROVED EQUAL. FOR SLOPES OF 1H:1V - EROSION CONTROL BLANKET TO BE CURLEX III

4. EROSION CONTROL BLANKET IS TO BE INSTALLED PER MANUFACTURERS SLOPE STABILIZATION BLANKET DETAIL


(EXCELSIOR EROSION CONTROL BLANKETS) OR APPROVED EQUAL.

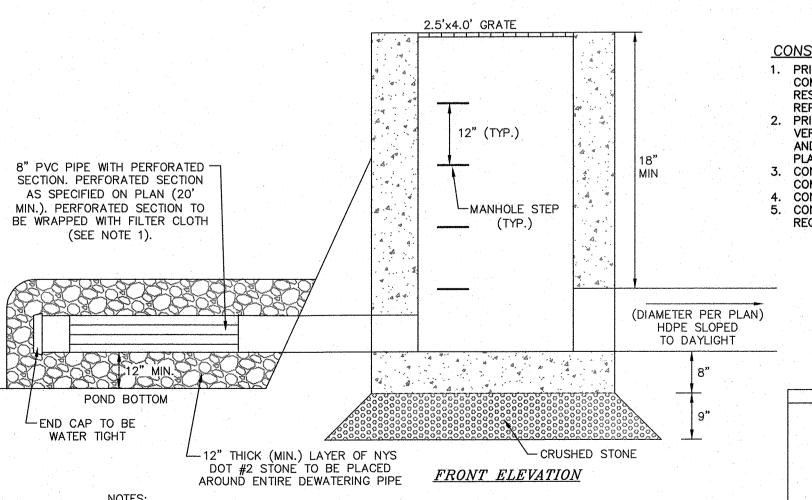

1. FILTER CLOTH IS TO HAVE A SIEVE SIZE BETWEEN #40-80 (MIRAFI FW402, OR APPROVED EQUAL). FILTER CLOTH IS TO COVER PIPE AT LEASE 6" PAST PERFORATIONS AND IS TO BE SECURED WITH STRAPPING OR A CONNECTING BAND ON EACH END. UPON FINAL STABILIZATION OF ALL UPSTREAM AREAS, THE TEMPORARY OUTLET STRUCTURE IS TO BE REMOVED AND THE SEDIMENT BASIN IS TO BE REMOVED OR CLEANED AND REGRADED

PROPOSED TEMPORARY OUTLET STRUCTURE FOR SEDIMENT BASIN DETAIL

AS SHOWN ON THE PLANS.

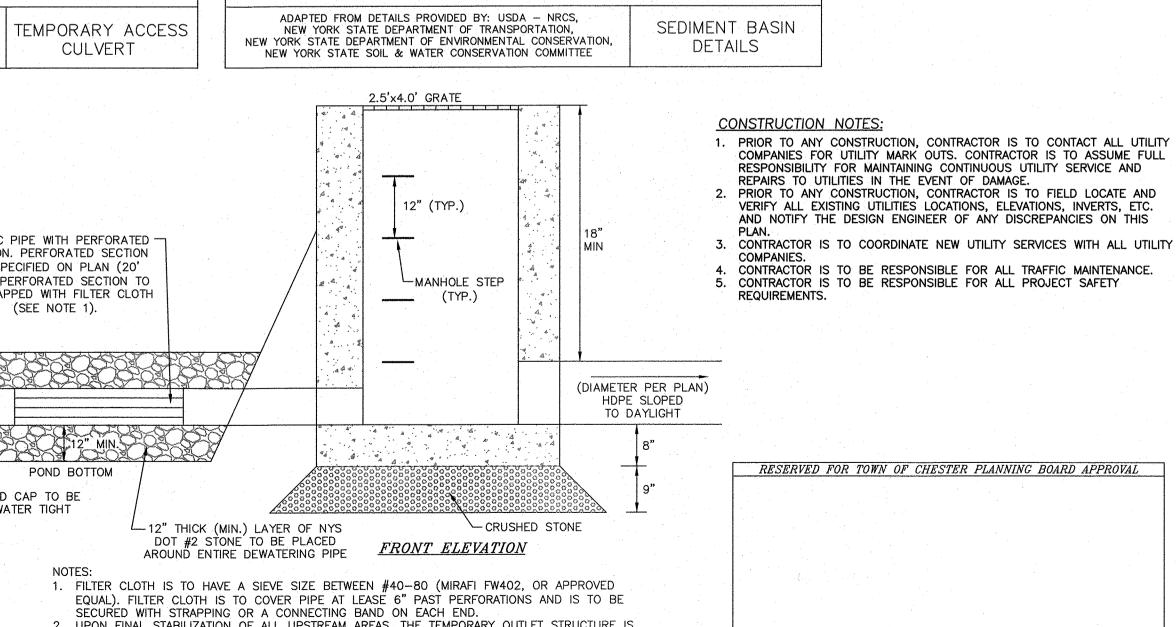



LAND SURVEYOR'S OR PROFESSIONAL ENGINEER'S SEAL IS A VIOLATION OF SECTION 7209, SUB-DIVISION 2 OF THE N.Y. STATE EDUCATION LAW.

O.C.H.D. SHEET NO. | D.E.C. SHEET NO. | DRAWING NUMBER

19118-SP2

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<u>N/A</u> OF \_\_\_\_


1"=30'


SCALE


6 OF <u>11</u>

19118.01

CAD REFERENCE | PROJECT NUMBER

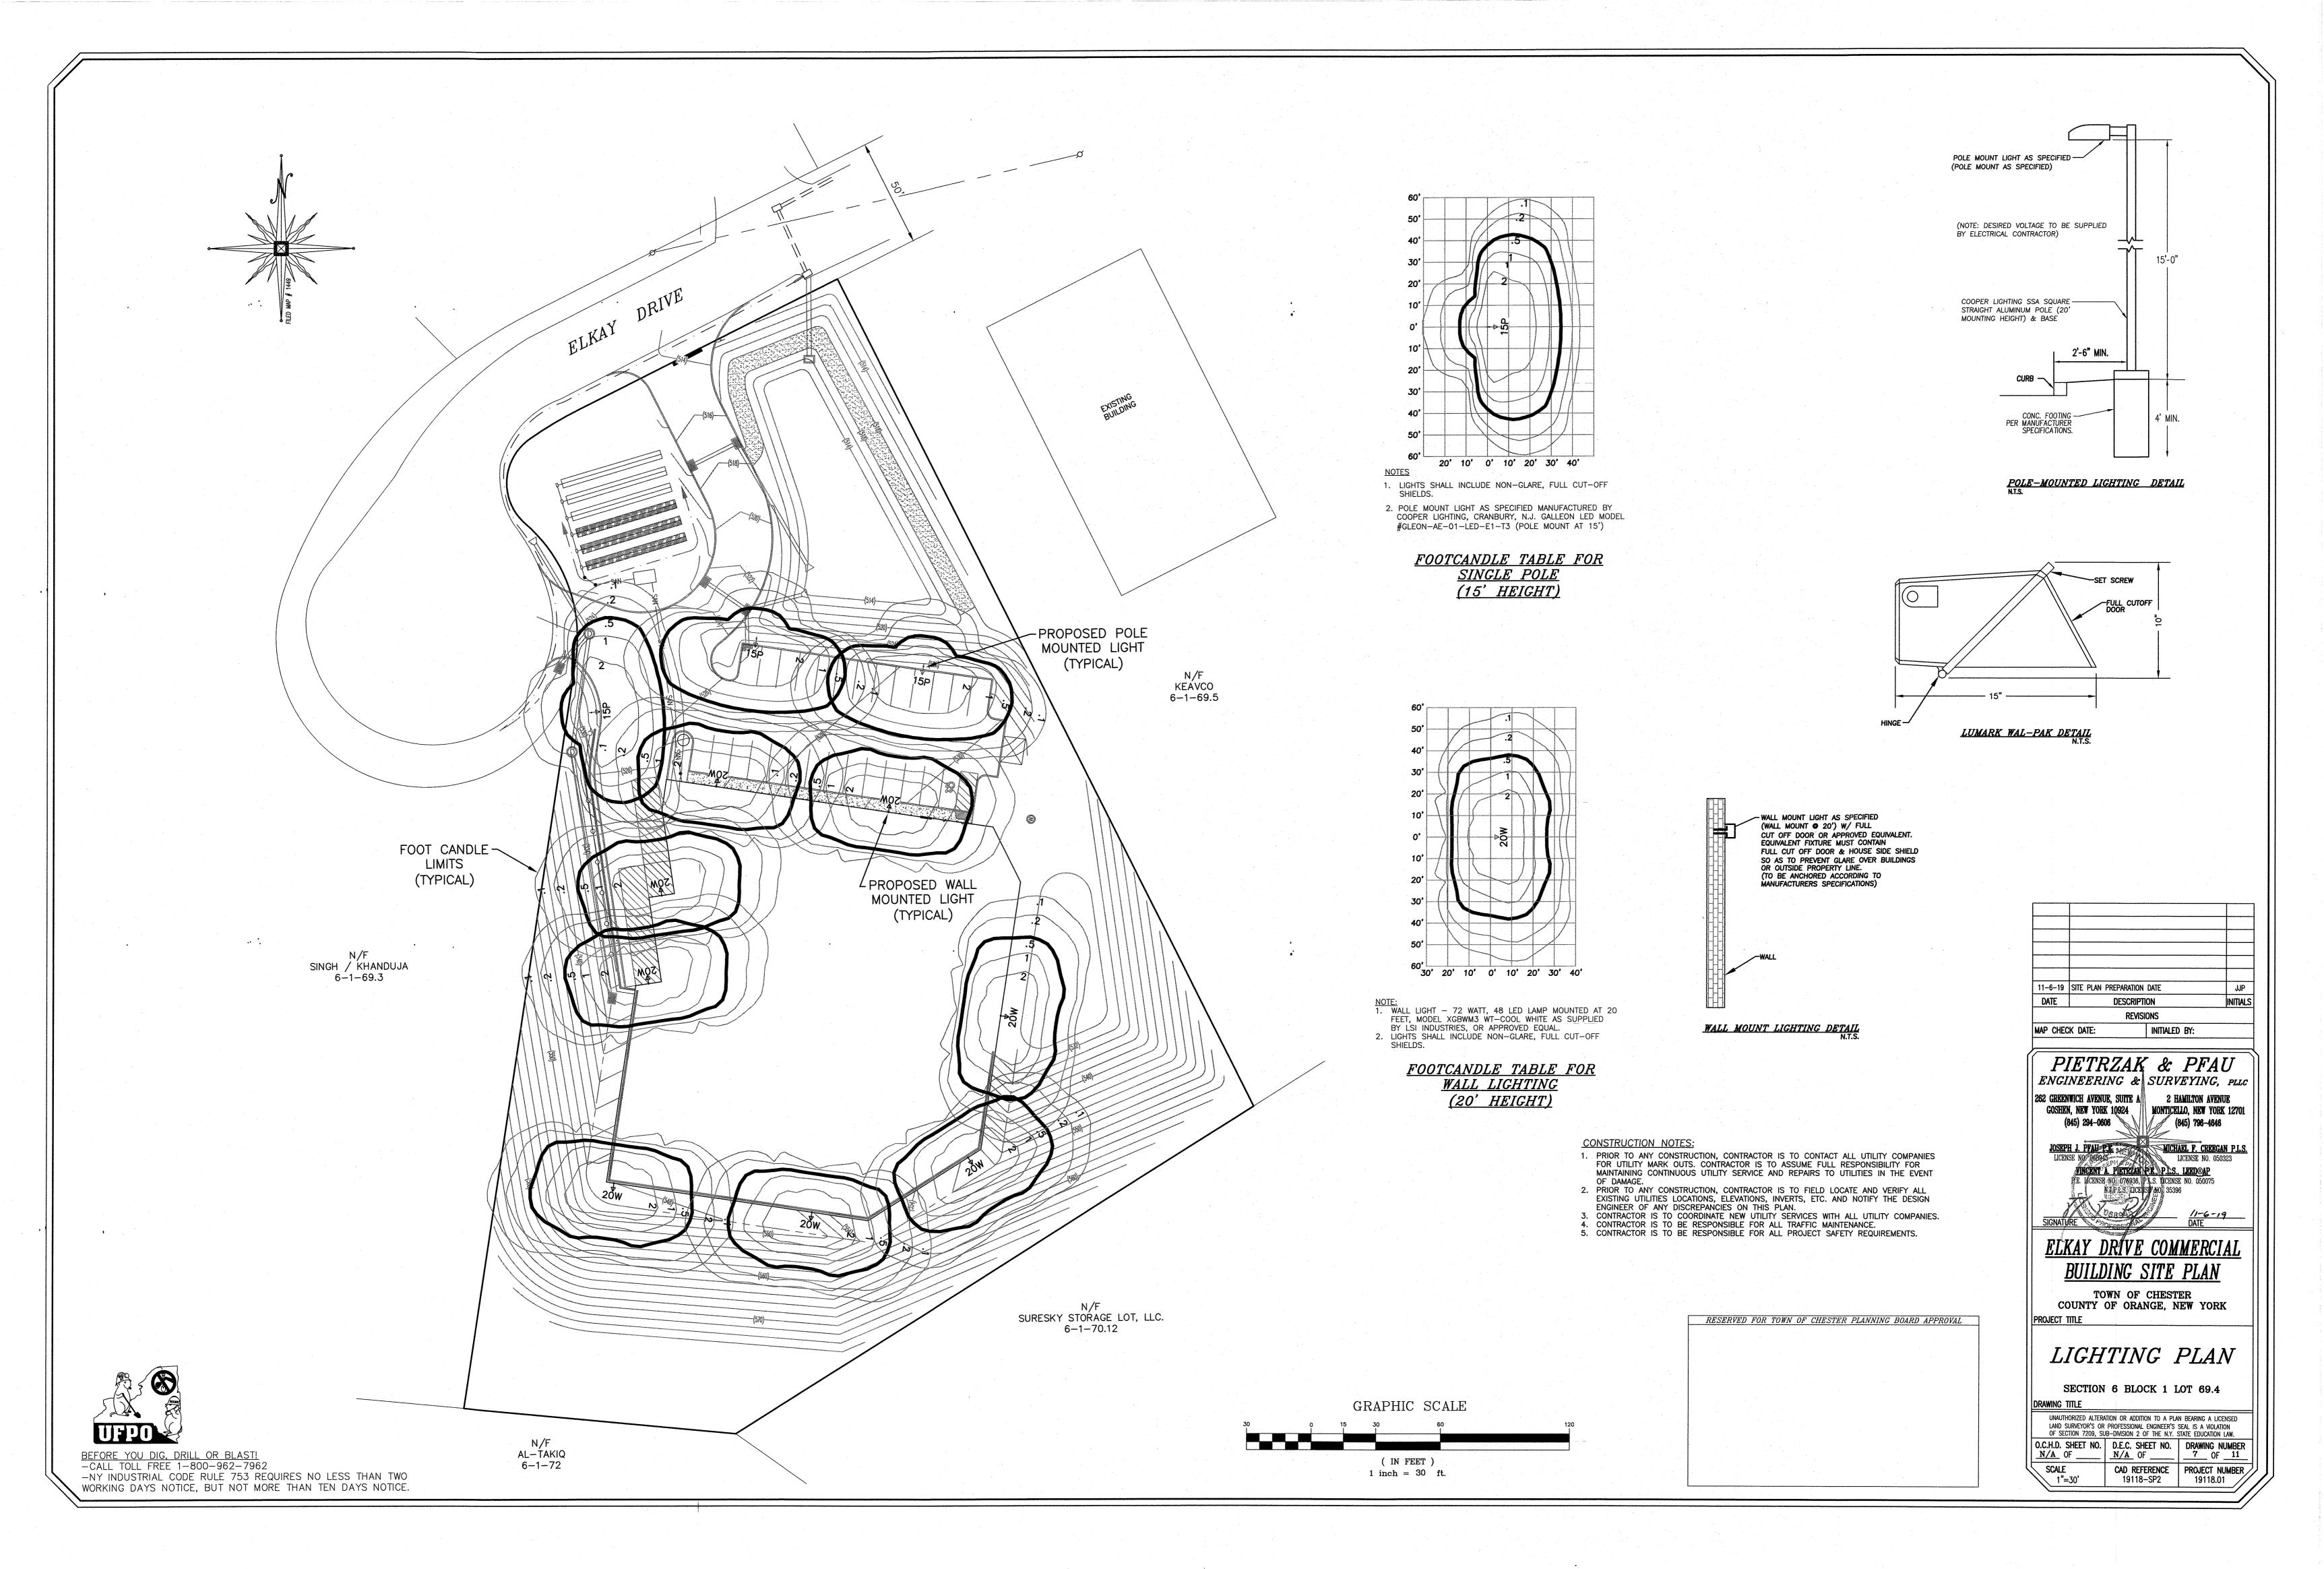

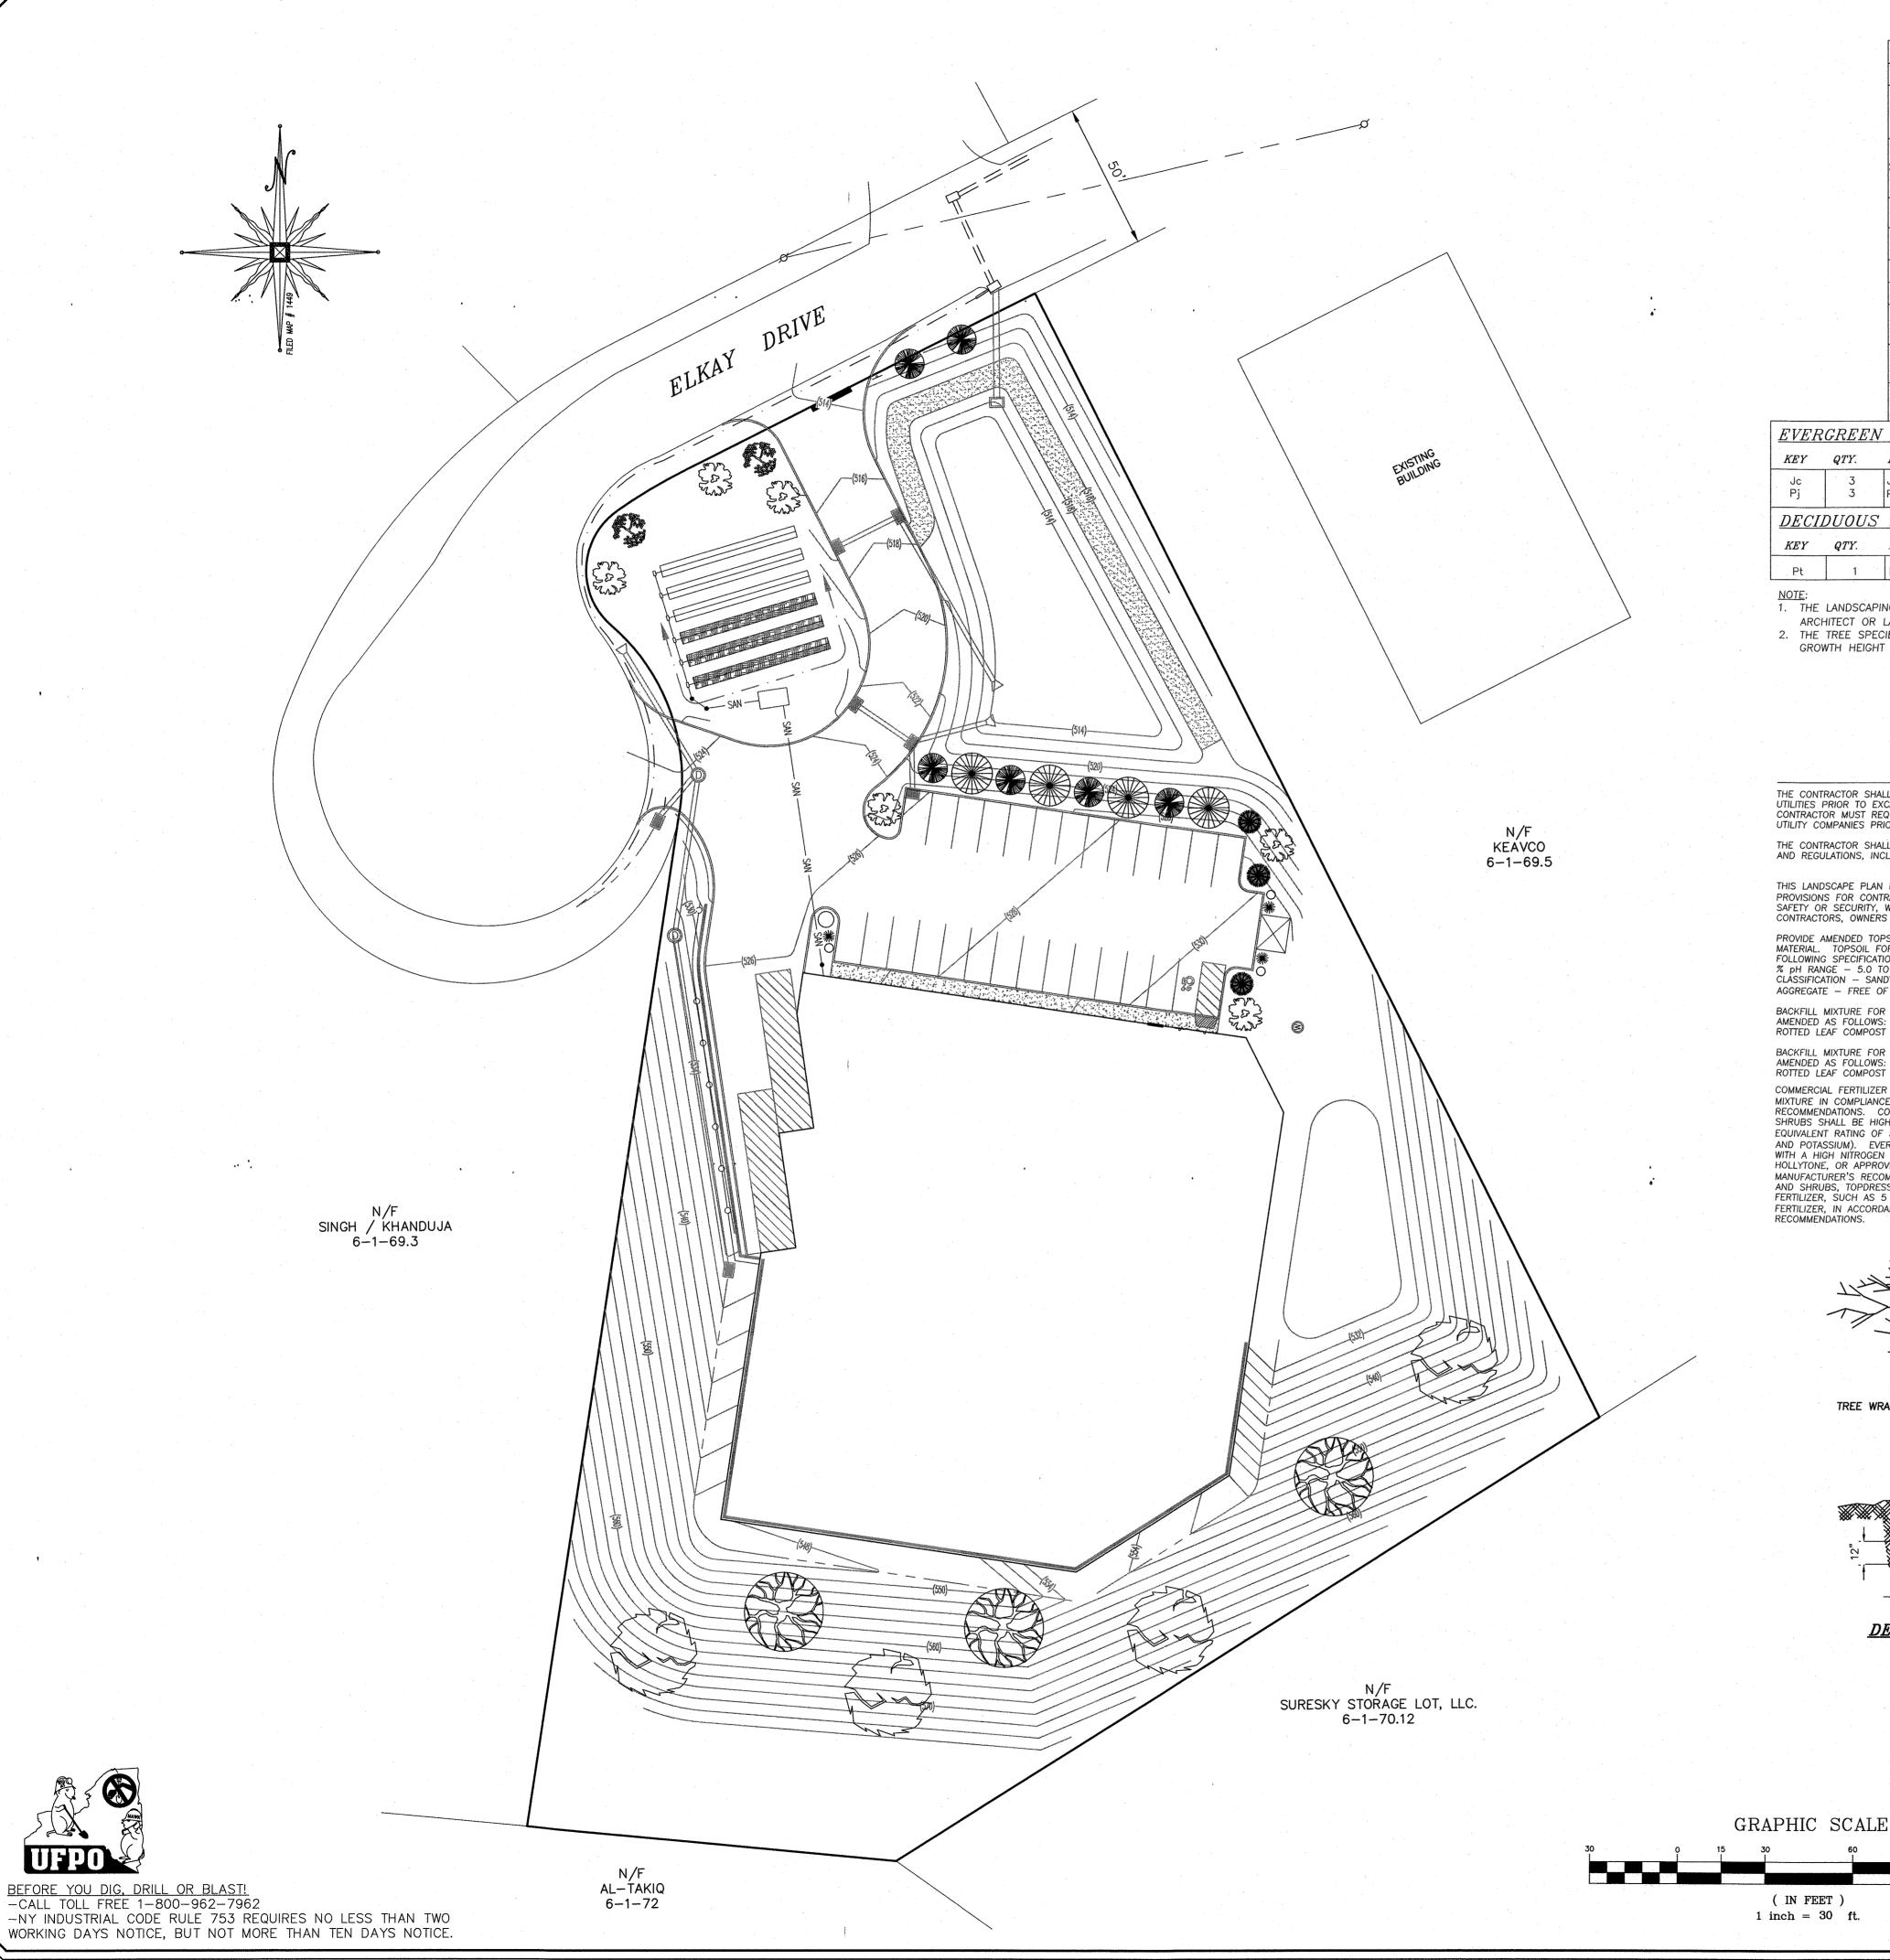

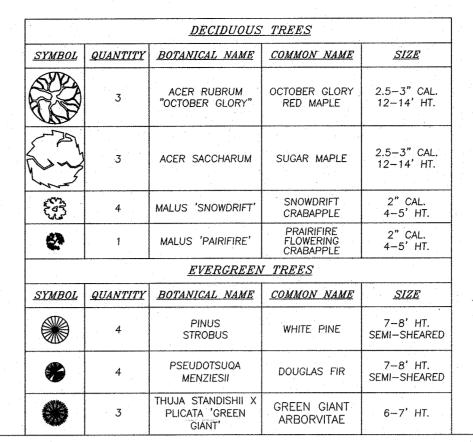

	<u>EVER</u>	<u>GREEN</u>	SHRUBS			
	KEY	QTY.	BOTANICAL NAME	COMMON NAME	MIN. SIZE	REMARKS
-	Jc Pj	3 3	JUNIPERUS CHINESIS "GOLD COAST" PIERIS JAPONICA	GOLD COAST JUNIPER JAPANESE ANDROMEDA	30" - 34" 30" - 36"	CONTAINER B&B
-	DECIL	DUOUS	SHRUBS			
	KEY	QTY.	BOTANICAL NAME	COMMON NAME	MIN. SIZE	REMARKS
	Pt	1	PENTANTHERA	AZALEA	30" - 34"	CONTAINER

1. THE LANDSCAPING VEGETATION SPECIES SPECIFIED MAY BE MIXED AND MATCHED AT THE LANDSCAPE ARCHITECT OR LANDSCAPER'S DISCRETION, SO LONG AS THE QUANTITY OF VEGETATION SHOWN IS MET.

2. THE TREE SPECIES PROVIDED IN THE FRONT OF THE PROPOSED BUILDING SHALL BE LIMITED TO A MAXIMUM GROWTH HEIGHT OF 20 TO 25 FEET.

PLANTING NOTES

ALL PLANT MATERIAL SHALL BE THOROUGHLY WATERED IN DURING THE CONTRACTOR SHALL VERIFY THE LOCATION OF ALL EXISTING UTILITIES PRIOR TO EXCAVATING FOR PLANTING WORK. BACKFILLING AND AFTER PLANTING/MULCHING HAS BEEN CONTRACTOR MUST REQUEST FIELD LOCATIONS FROM THE VARIOUS

THE CONTRACTOR SHALL COMPLY WITH ALL APPLICABLE CODES AND REGULATIONS, INCLUDING LOCAL ORDINANCES GOVERNING THE

THIS LANDSCAPE PLAN DOES NOT CONTAIN OR IMPLY ANY PROVISIONS FOR CONTRACTORS,' LABORERS', OR TRANSIENTS' SAFETY OR SECURITY, WHICH IS THE SOLE RESPONSIBILITY OF CONTRACTORS, OWNERS AND OPERATORS.

UTILITY COMPANIES PRIOR TO BEGINNING THE WORK.

PROVIDE AMENDED TOPSOIL BACKFILL FOR ALL NEWLY PLANTED MATERIAL. TOPSOIL FOR BACKFILL SHALL COMPLY WITH THE FOLLOWING SPECIFICATIONS: ORGANIC MATTER CONTENT - MIN. 5 % pH RANGE - 5.0 TO 6.5 CLASSIFICATION - SANDY LOAM OR LOAM

AGGREGATE - FREE OF STONES 1/2" OR GREATER BACKFILL MIXTURE FOR DECIDUOUS TREES AND SHRUBS SHALL BE AMENDED AS FOLLOWS: 1 PART APPROVED TOPSOIL TO 2 PARTS ROTTED LEAF COMPOST OR PEAT MOSS, THOROUGHLY MIXED.

BACKFILL MIXTURE FOR EVERGREEN TREES AND SHRUBS SHALL BE AMENDED AS FOLLOWS: 1 PART APPROVED TOPSOIL TO 3 PARTS ROTTED LEAF COMPOST OR PEAT MOSS, THOROUGHLY MIXED.

COMMERCIAL FERTILIZER SHALL BE ADDED TO THE BACKFILL MIXTURE IN COMPLIANCE WITH THE MANUFACTURER'S RECOMMENDATIONS. COMMERCIAL FERTILIZER FOR ALL TREES AND SHRUBS SHALL BE HIGH PHOSPHOROUS FERTILIZER WITH AN EQUIVALENT RATING OF 5 - 10- 5 (NITROGEN, PHOSPHOROUS AND POTASSIUM). EVERGREEN TREES AND SHRUBS TOPDRESS WITH A HIGH NITROGEN GRANULAR FERTILIZER SUCH AS HOLLYTONE, OR APPROVED EQUAL IN ACCORDANCE WITH MANUFACTURER'S RECOMMENDATIONS. FOR DECIDUOUS TREES AND SHRUBS, TOPDRESS WITH A HIGH PHOSPHOROUS GRANULAR FERTILIZER, SUCH AS 5 - 10 - 5, COMPLETE GARDEN FERTILIZER, IN ACCORDANCE WITH MANUFACTURER'S

PLANT BEDS, HEDGES, GROUPINGS, ETC. SHALL BE UNIFORMLY MULCHED OVER THE ENTIRE BED AREA WITH 3 THICK DOUBLE SHREDDED OAK BARK MULCH, BLACK IN COLOR. PALETTE MULCH OR OTHER SHREDDED WOOD MULCH IS NOT ACCEPTABLE. ALL BED LINES SHALL BE SMOOTHLY AND UNIFORMLY DEFINED WITH A GARDEN SPADE.

ALL PLANT MATERIAL SHALL BE SUBJECT TO INSPECTION BY A LANDSCAPE ARCHITECT OR ENGINEER AT ITS SOURCE, PRIOR TO SHIPMENT TO THE JOBSITE. ALL SPECIMEN ORNAMENTALS, ECIDUOUS TREES, EVERGREEN TREES SHALL BE INSPECTED B THE LANDSCAPE CONTRACTOR AND/OR A LANDSCAPE ARCHITECT OR ENGINEER FOR COMPLIANCE WITH THE PLANT LIST.

ALL PLANT MATERIAL SHALL BE HIGH QUALITY, SPECIMEN GRADE MATERIAL, IN VIGOROUS HEALTHY CONDITION. REFERENCED STANDARD FOR PLANT MATERIAL SHALL BE AMERICAN STANDARD FOR NURSERY STOCK, PUBLISHED BY THE AMERICAN ASSOCIATION OF NURSERYMEN, WASHINGTON, D.C. TREES SHALL NOT BE PLANTED BETWEEN MAY 15 AND SEPTEMBER 15

WITHOUT SPECIFIC AUTHORIZATION OF THE BUILDING INSPECTOR. ALL TREES MUST MEET THE STANDARDS OF THE AMERICAN STANDARD FOR NURSERY STOCK. ALL TREES SHALL MEASURE AT LEAST 2 TO 2.5 INCHES IN DIAMETER AS MEASURED AT A POINT 6 INCHES ABOVE THE TOP OF THE BALL, NOR LESS THAN 10 FEET HIGH UNLESS OTHERWISE SPECIFIED. ANY TREE IMPROPERLY PLANTED OR NOT MEETING THESE SPECIFICATIONS WILL BE SUBJECT TO REMOVAL. ANY TREE THAT DOES NOT SURVIVE OR IS IN AN UNHEALTHY CONDITION AT THE END OF ONE (1) YEAR SHALL BE REPLACED. SAID REPLACEMENT SHALL BE MADE WITHIN SIXTY (60) DAYS FOLLOWING WRITTEN DEMAND FOR SUCH REPLACEMENT OR WITHIN A MORE EXTENDED EXTENDED PERIOD AS MAY BE SPECIFIED.

### TOPSOIL & SEEDING NOTES

- 1. AREAS DESIGNATED TO BE TOPSOILED AND SEEDED SHALL BE TREATED
- AS FOLLOWS: A. ESTABLISH SUBGRADE TO A SMOOTH, UNIFORM SURFACE ELEVATION
- 4 INCHES BELOW FINISHED GRADE. REMOVE ALL SURFACE STONES
- 2' OR GREATER FROM THE TOP 2' OF THE SUBGRADE. B. SPREAD HIGH PHOSPHOROUS GRANULAR FERTILIZER OVER THE SUBGRADE AT A RATE OF 5 POUNDS PER 1000 SQUARE FEET.
- C. SPREAD APPROVED TOPSOIL OVER THE ENTIRE AREA TO A UNIFORM 4 " DEPTH (MINIMUM), TO THE REQUIRED FINISHED GRADE ELEVATIONS. REMOVE ALL STONES 3/4" DIA. OR GREATER FROM THE ENTIRE DEPTH OF TOPSOIL. APPLY PULVERIZED LIMESTONE TO THE TOPSOIL AT A RATE DETERMINED BY SOIL TESTING TO MEET REQUIRED PH REQUIREMENTS.
- D. SPREAD HIGH NITROGEN FERTILIZER (20 10 10) OVER THE ENTIRE AREA AND RAKE INTO THE TOP 1" OF SOIL, AT A RATE OF
- 3 POUNDS PER 1000 SQUARE FEET. E. SPREAD SEED MIXTURE UNIFORMLY OVER THE ENTIRE AREA AT A RATE OF 5 POUNDS PER 1000 SQUARE FEET. LIGHTLY RAKE SEED INTO THE TOP 1/4" OF SOIL. MIST THE ENTIRE SEED BED
- THOROUGHLY WITH CARE NOT TO CREATE EROSION OF SEEDBED. F. STRAW MULCH (UNIFORMLY BLOWN ON) TO A 1/2 BLANKET AND IMMEDIATELY WATER THE MULCH BLANKET.
- 2. TOPSOIL SHALL BE AS SPECIFIED UNDER PLANTING NOTES.
- 3. SEED MIXTURE SHALL BE AS SHOWN IN SEEDING SCHEDULE. 4. CONTRACTOR SHALL SUBMIT SEED CERTIFICATION PRIOR TO SEEDING.

#### SEEDING SCHEDULE


PERMANENT MIX: SEED RATE IS 200 POUNDS PER ACRE OR 5 POUNDS PER 1000 SQUARE FEET. SEED SHALL NOT CONTAIN IN EXCESS OF 0.5% WEED SEED. THE SEED SHALL HAVE A MINIMUM PURITY AND GERMINATION PERCENTAGES AS FOLLOWS: % MINIMUM SEED PURITY
% MINIMUM GERMINATION
% MIX "RELIANT" HARD FESCUE FESCUE, RED (CHEWING OR CREEPING) RYEGRASS, PERENNIAL

PALMER PERENNIAL 20% RYEGRASS, CROWNVETCH 60%, JAMESTOWN CHEWING FESCUE 20% SEED RATE IS 200 POUNDS PER ACRE OR 5 POUNDS PER 1000 SQUARE FEET. SEED CONTAINING PROHIBITED OR RESTRICTED NOXIOUS WEEDS WILL NOT BE ACCEPTED. SEED SHALL NOT CONTAIN IN EXCESS OF 0.5% WEED SEED. THE SEED SHALL HAVE A MINIMUM PURITY AND GERMINATION PERCENTAGES AS FOLLOWS:

<u>GRASSES</u>	% MINIMUM SEED PURITY	% MINIMUM GERMINATION	% MIX
CROWNVETCH	95	68	60
FESCUE, RED (CHEWING OR CREEPING)	97	, , , 80	20
RYEGRASS, PERENNIAL	98	90	15
SHALL NOT BE USED LATE TWICE THE SUPPLIERS RE	BE USED FOR TREATING I ER THAN THE DATE INDICAT COMMENDED RATE OF INNO R TIMES THE RECOMMENDE	ED ON THE CONTAINER. OCULANT SHALL BE USED	WHEN

1. PRIOR TO ANY CONSTRUCTION, CONTRACTOR IS TO CONTACT ALL UTILITY COMPANIES FOR UTILITY MARK OUTS. CONTRACTOR IS TO ASSUME FULL RESPONSIBILITY FOR MAINTAINING CONTINUOUS UTILITY SERVICE AND REPAIRS TO UTILITIES IN THE EVENT

- 2. PRIOR TO ANY CONSTRUCTION, CONTRACTOR IS TO FIELD LOCATE AND VERIFY ALL EXISTING UTILITIES LOCATIONS, ELEVATIONS, INVERTS, ETC. AND NOTIFY THE DESIGN
- ENGINEER OF ANY DISCREPANCIES ON THIS PLAN. CONTRACTOR IS TO COORDINATE NEW UTILITY SERVICES WITH ALL UTILITY COMPANIES. 4. CONTRACTOR IS TO BE RESPONSIBLE FOR ALL TRAFFIC MAINTENANCE.
  5. CONTRACTOR IS TO BE RESPONSIBLE FOR ALL PROJECT SAFETY REQUIREMENTS.

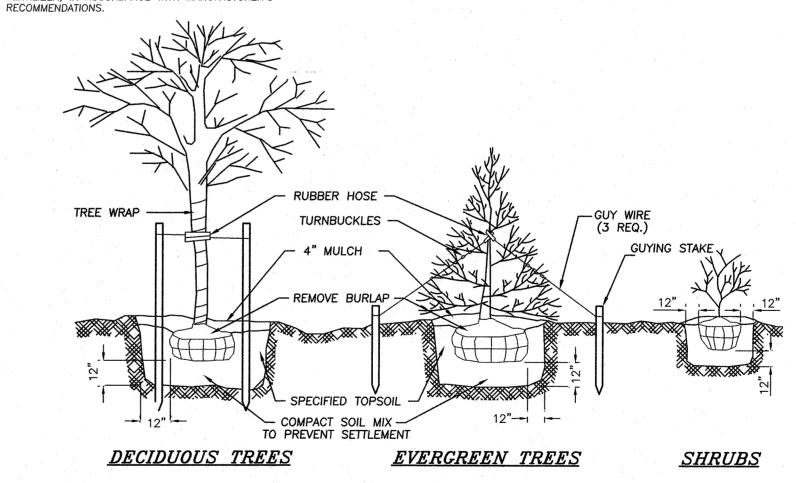

PLANTING & GUYING DETAIL

RESERVED FOR TOWN OF CHESTER PLANNING BOARD APPROVAL

11-6-19 SITE PLAN PREPARATION DATE DESCRIPTION REVISIONS MAP CHECK DATE: INITIALED BY: PIETRZAK & PFAU ENGINEERING & SURVEYING, PLLC 262 GREENWICH AVENUE, SUITE A 2 HAMILTON AVENUE MONTICELLO, NEW YORK 1270 (845) 294-0606 MICHAEL F. CREEGAN P.L.S. VINCENT A PIETRZAK P.E. P.LS. LEED®AP E LICENSE NO. 076936, PLAS. LICENSE NO. 050075 NIPLS LICENSE NO. 35396 ELKAY DRÎVE COMMERCIA BUILDING SITE PLAN TOWN OF CHESTER COUNTY OF ORANGE, NEW YORK LANDSCAPING PLAN SECTION 6 BLOCK 1 LOT 69.4

> UNAUTHORIZED ALTERATION OR ADDITION TO A PLAN BEARING A LICENSED LAND SURVEYOR'S OR PROFESSIONAL ENGINEER'S SEAL IS A VIOLATION OF SECTION 7209, SUB-DIVISION 2 OF THE N.Y. STATE EDUCATION LAW. O.C.H.D. SHEET NO. | D.E.C. SHEET NO. | DRAWING NUMBER

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19118-SP2


1"=30'

CAD REFERENCE | PROJECT NUMBER

19118.01

JJP


INITIALS

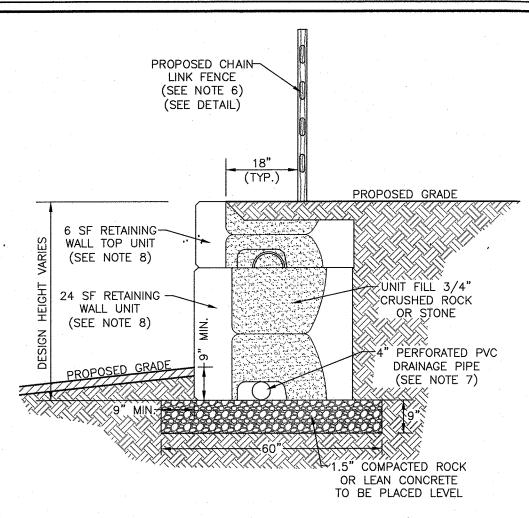


- 1. PROPOSED CONCRETE BLOCK RETAINING WALL TO BE A STRONG STONE SYSTEMS WALL, UTILIZING A MIXTURE OF THE 24 SQUARE FOOT UNITS, 6 SQUARE FOOT UNITS AND THE STEP/CAP UNITS,
- 2. DESIGN FOR THE RETAINING WALL SHOWN HEREON SHALL BE PREPARED BY A NYS LICENSED PROFESSIONAL ENGINEER AND SUBMITTED TO THE TOWN BUILDING INSPECTOR FOR RECORD PRIOR TO CONSTRUCTION, SUCH DESIGN DRAWINGS (OR SHOP DRAWINGS) SHALL BEAR THE STAMP AND SIGNATURE OF SUCH ENGINEER, AND SHALL BE SPECIFIC FOR THE SITE AND SPECIFIC TO THE RETAINING WALL SYSTEM TO BE UTILIZED AND SHALL CONSIDER ALL APPROPRIATE AND NECESSARY
- POSSIBLE LOADINGS AND CONDITIONS RELATED TO THIS PROJECT. 3. THE AFOREMENTIONED DESIGN AND DETAILS SHALL CONSIDER / IDENTIFY / INCLUDE, BUT SHALL NOT BE LIMITED TO: SIGNED AND SEALED DESIGN CALCULATIONS; COMPLETE AND SPECIFIC CONSTRUCTION PLANS AND DETAILS FOR EACH WALL; APPROPRIATE SIZING FOR DRAINAGE SYSTEM TO HANDLE INTENSE STORM CONDITIONS; MAINTENANCE ABILITY TO CLEAN STORMWATER PIPING SYSTEMS; APPROPRIATE BACKFILL MATERIAL SUFFICIENT POROSITY TO ALLOW FREE DRAINAGE OF WATER; EVALUATE POTENTIAL FAILURE BY INTERNAL/EXTERNAL FAILURE MECHANISMS, GLOBAL
- FAILURE OR OTHER POTENTIAL FAILURES; AND SEISMIC DESIGN CONSIDERATIONS. 4. DURING CONSTRUCTION, THE WORK MUST BE INSPECTED BY A NYS LICENSED PROFESSIONAL ENGINEER WHO SHALL PROVIDE WRITTEN VERIFICATION TO THE TOWN BUILDING INSPECTOR, PRIOR TO THE REQUEST FOR A CERTIFICATE OF OCCUPANCY, THAT HE/SHE HAS PERSONALLY INSPECTED THE WORK, AND THE INSTALLATION IS IN COMPLIANCE THE DESIGN DRAWINGS AND MANUFACTURER'S INSTALLATION RECOMMENDATIONS.
- 5. IF DEEMED NECESSARY BY THE DESIGN ENGINEER AND/OR THE TOWN, THIRD PARTY TESTING WILL BE PERFORMED REGARDING MATERIAL COMPACTION, FILL QUALITY, ETC. A COPY OF ALL SUCH TESTING RECORDS SHALL BE PROVIDED TO THE TOWN BUILDING DEPARTMENT FOR RECORD. 6. DUE TO THE HEIGHT OF THE PROPOSED RETAINING WALL, SAFETY FENCING IS TO BE PROVIDED ON THE UPHILL SIDE OF THE PROPOSED RETAINING WALL AND IS TO BE INCLUDED IN THE DESIGN PREPARED BY A NYS LICENSED PROFESSIONAL ENGINEER. THE FENCING IS TO BE CHAIN LINK
- FENCE IN ACCORDANCE WITH THE DETAIL PROVIDED IN THIS PLAN SET. 7. SEE GRADING PLAN FOR LOCATION OF PROPOSED WALL. DRAINAGE PIPE IS TO BE WRAPPED IN FILTER FABRIC WHEN SITE CONDITIONS REQUIRE AND IN ACCORDANCE WITH MANUFACTURERS SPECIFICATIONS. DRAINAGE PIPE IS TO BE RUN TO DAYLIGHT OR CONNECTED TO CATCH BASINS AT LOW POINTS THROUGH WALL, OR AT ENDS.

9. VERTICAL STRONG STONE SYSTEM WALLS REQUIRE A MODIFIED ALIGNMENT RECESS & A MODIFIED

FACE IN ACCORDANCE WITH MANUFACTURERS SPECIFICATIONS. CONCRETE BLOCK RETAINING WALL DETAIL

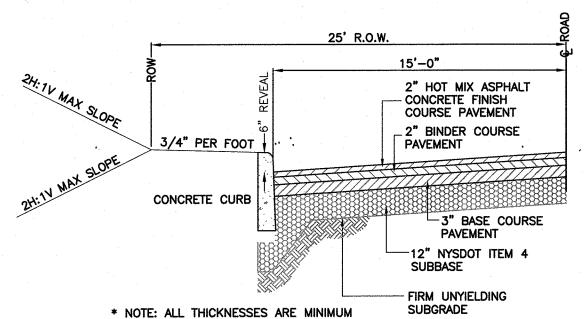


MAIN ACCESS DRIVE, HALF SECTION

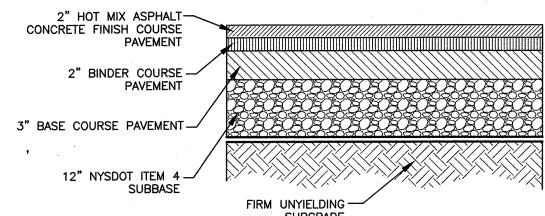

2. ALL THICKNESSES ARE MINIMUM

SUBGRADE 1. WHERE UNSUITABLE MATERIAL IS ENCOUNTERED BELOW SUBBASE, UNDERCUT TO SUITABLE MATERIAL.

TRUCK ACCESS/LOADING CROSS-SECTION

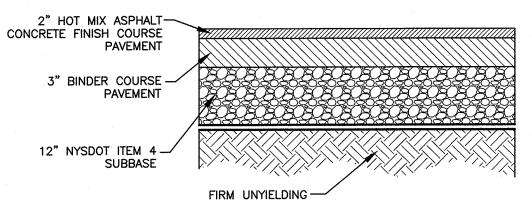

1. WHERE UNSUITABLE MATERIAL IS ENCOUNTERED BELOW SUBBASE, UNDERCUT TO SUITABLE MATERIAL.

2. ALL THICKNESSES ARE MINIMUM PARKING LOT CROSS-SECTION

HANDICAPPED NO PARKING HANDICAPPED SIGN SIGN -MOUNTABLE ADA COMPLIANT SIDEWALK CURB 4" STRIPING STRIPE STRIPING NOTE 4 STRIPE ---WHITE STRIPE STRIPE 'NO PARKING'

1. ALL STRIPING FOR THE HANDICAPPED SPACE MUST BE BLUE. WHEN A STANDARD SPACE ADJOINS A HANDICAPPED SPACE, A DOUBLE LINE SHOULD BE INSTALLED, ONE BLUE, ONE WHITE. 2. FOR THE CROSS-HATCHED ACCESS LANE NEAR THE BOTTOM, ADD BLUE

- PAINTED TEXT 'NO PARKING'. 3. THE MOUNTABLE CURB SHALL MEET ALL ADA HANDICAPPED TRANSITION 4. THE MOUNTING HEIGHT TO THE BOTTOM OF THE SIGN SHALL BE FIVE (5)
- FEET TO SEVEN (7) FEET. 5. DYNAMIC ACCESSIBILITY SYMBOLS SHALL BE USED.

LTOP RAIL

-CONCRETE FOOTING -

1. ALL COMPONENTS OF THE FENCE (POSTS, FABRIC, RAILS, ETC.) SHALL BE BLACK VINYL

CHAIN LINK FENCE DETAIL

-UNDISTURBED EARTH

CORNER OR END POST

1'-6"

1. PRIOR TO ANY CONSTRUCTION, CONTRACTOR IS TO CONTACT ALL UTILITY

RESPONSIBILITY FOR MAINTAINING CONTINUOUS UTILITY SERVICE AND

VERIFY ALL EXISTING UTILITIES LOCATIONS, ELEVATIONS, INVERTS, ETC.

AND NOTIFY THE DESIGN ENGINEER OF ANY DISCREPANCIES ON THIS

3. CONTRACTOR IS TO COORDINATE NEW UTILITY SERVICES WITH ALL UTILITY

4. CONTRACTOR IS TO BE RESPONSIBLE FOR ALL TRAFFIC MAINTENANCE. 5. CONTRACTOR IS TO BE RESPONSIBLE FOR ALL PROJECT SAFETY

2. PRIOR TO ANY CONSTRUCTION, CONTRACTOR IS TO FIELD LOCATE AND

REPAIRS TO UTILITIES IN THE EVENT OF DAMAGE.

COMPANIES.

REQUIREMENTS.

COMPANIES FOR UTILITY MARK OUTS. CONTRACTOR IS TO ASSUME FULL

- STRETCHER BAR

-- Chain Link Fabric W/ Green Slat Inserts

LINE POST -


—tension wire

FINISH GRADE

CROWN 1\*

INTERMEDIATE RAIL

ACCESSIBLE PARKING STRIPING AND SIGNAGE DETAIL

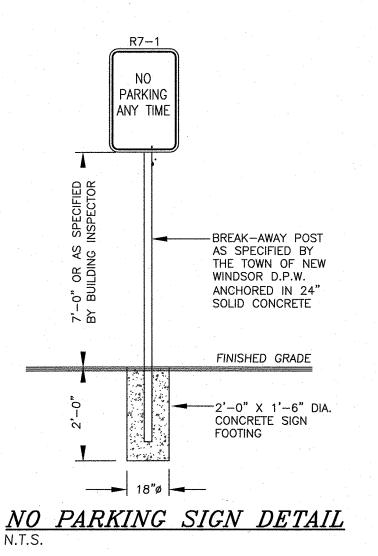

DIA. CONCRETE SIGN FOOTING **→** 18"ø HANDICAP SIGN DETAIL

PERMIT PARKING ONLY TOW-AWAY ZONE

VAN ACCESSIBLE

BREAK-AWAY POST

THE TOWN OF NEW

AS SPECIFIED BY


WINDSOR D.P.W.

SOLID CONCRETE


FINISHED GRADE

2'-0" X 1'-6"


ANCHORED IN 24"

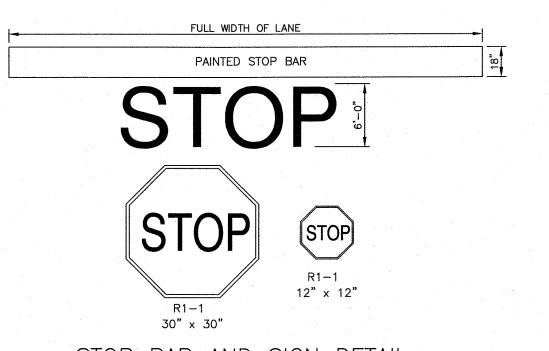

STOP BAR AND SIGN DETAIL

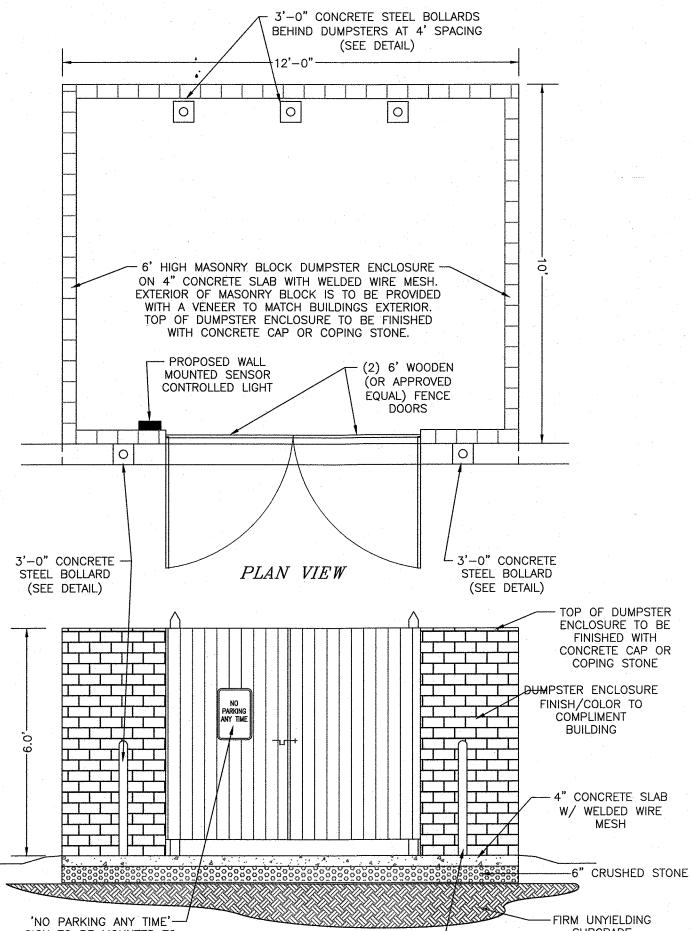


STRIPING (TYP.) PARKING STRIPING DETAIL

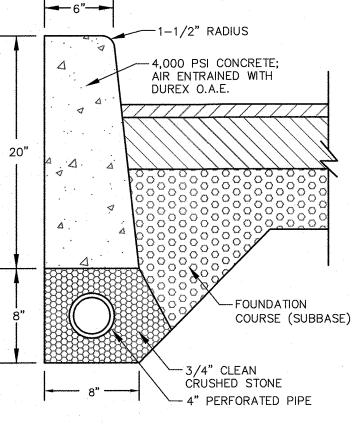

1. CURB SHALL BE CAST-IN-PLACE. EXPANSION JOINTS OF 1/2" CELLULOSE OR SIMILAR MATERIAL SHALL BE INSTALLED AT 10' INTERVALS AND WHERE CURB IS AGAINST CATCH BASINS, SIDEWALKS AND OTHER STRUCTURES. CONTRACTION (CONTROL) JOINTS SHALL BE INSTALLED AT 10' INTERVALS. 2. ALL UNDERDRAIN PIPES SHALL BE CONNECTED TO THE NEAREST CATCH BASIN.

CONCRETE CURB DETAIL

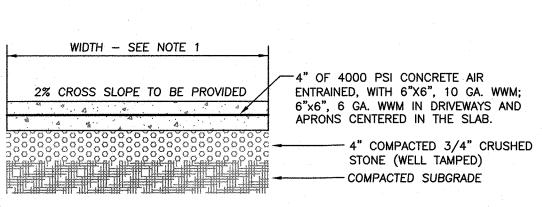

- . SIDEWALKS SHALL BE A MINIMUM OF 6' WIDE WHEN ADJACENT TO PARKING STALLS AND MINIMUM OF 5' WIDE IN ALL OTHER AREAS. 2. FINISH TO BE BROOM FINISH AT 90° TO EACH SUCCEEDING SLAB. 3. JOINTER TO BE 1" DEEP. JOINT SPACING SHALL BE EQUAL TO WIDTH
- OF WALK FOR SPACING. 4. INSTALL 1/2" PRE-MOLDED EXPANSION JOINT AT 20' O.C. AND WHERE SIDEWALK IS AGAINST CONCRETE CURBS, BUILDINGS, AND OTHER STRUCTURES.

CONCRETE SIDEWALK DETAIL

RESERVED FOR TOWN OF CHESTER PLANNING BOARD APPROVAL

JJP 11-6-19 SITE PLAN PREPARATION DATE INITIALS DATE DESCRIPTION REVISIONS MAP CHECK DATE: initialed by:

LETTERS

PRÍSMATIC GRADE

- HOT DIPPED GALVANIZED, 4 IB/FT STRENGTH,

SIGN POST ATTACHED

ALUMINUM BREAKAWAY

FINISHED GRADE

DIA. CONCRETE

SIGN FOOTING

3'-0" X 1'-6"

→ 18"ø

PANELS.

1. BASE POST TO PROJECT A MAXIMUM

2. POST IS TO HAVE TWO 3' X 3" RED

HIGH INTENSITY PRISMATIC GRADE

OF 4" ABOVE FINISHED GRADE.

STOP SIGN DETAIL

-3'-6" LONG, HOT DIPPED GALVANIZED,

TO BASE POST

STOP SIGN

PIETRZAK & PFAU ENGINEERING & SURVEYING, PLLC 262 GREENWICH AVENUE, SUITE A 2 HAMILTON AVENUE GOSHEN, NEW YORK 19924 | MONTICELLO, NEW YORK 12701 (845) 796-4646 (845) 294-0606 LICENSE NO. 668948 IN FIGURE P. C. P.L.S., LEED@AP MICHAEL F. CREEGAN P.L.S. LICENSE NO. 050323 P.E. LICENSE NO. 076936, P.L.S. LICENSE NO. 050075 N.J.P.L.S. LICENSE NO. 35396 11-6-19

BUILDING SITE PLAN TOWN OF CHESTER

COUNTY OF ORANGE, NEW YORK

SITE DETAILS


SECTION 6 BLOCK 1 LOT 69.4 UNAUTHORIZED ALTERATION OR ADDITION TO A PLAN BEARING A LICENSED

LAND SURVEYOR'S OR PROFESSIONAL ENGINEER'S SEAL IS A VIOLATION OF SECTION 7209, SUB-DIVISION 2 OF THE N.Y. STATE EDUCATION LAW. O.C.H.D. SHEET NO. | D.E.C. SHEET NO. | DRAWING NUMBER <u>N/A</u> OF \_\_\_ <u>9</u> 0F <u>11</u> SCALE CAD REFERENCE | PROJECT NUMBER AS SHOWN 19118-SP2 19118.01


-REFLECTIVE BAND PAINT SAFETY YELLOW FINISHED GRADE FRONT VIEW


 BOLLARD TO BE STANDARD WEIGHT STEEL PIPE.
 BOLLARD TO BE POWDER COATED YELLOW WITH CAP. CONCRETE STEEL BOLLARD DETAIL


L 3'-0" CONCRETE SUBGRADE SIGN TO BE MOUNTED TO WOODEN ACCESS DOOR STEEL BOLLARD FRONT VIEW (SEE DETAIL) MASONRY BLOCK DUMPSTER ENCLOSURE DETAIL

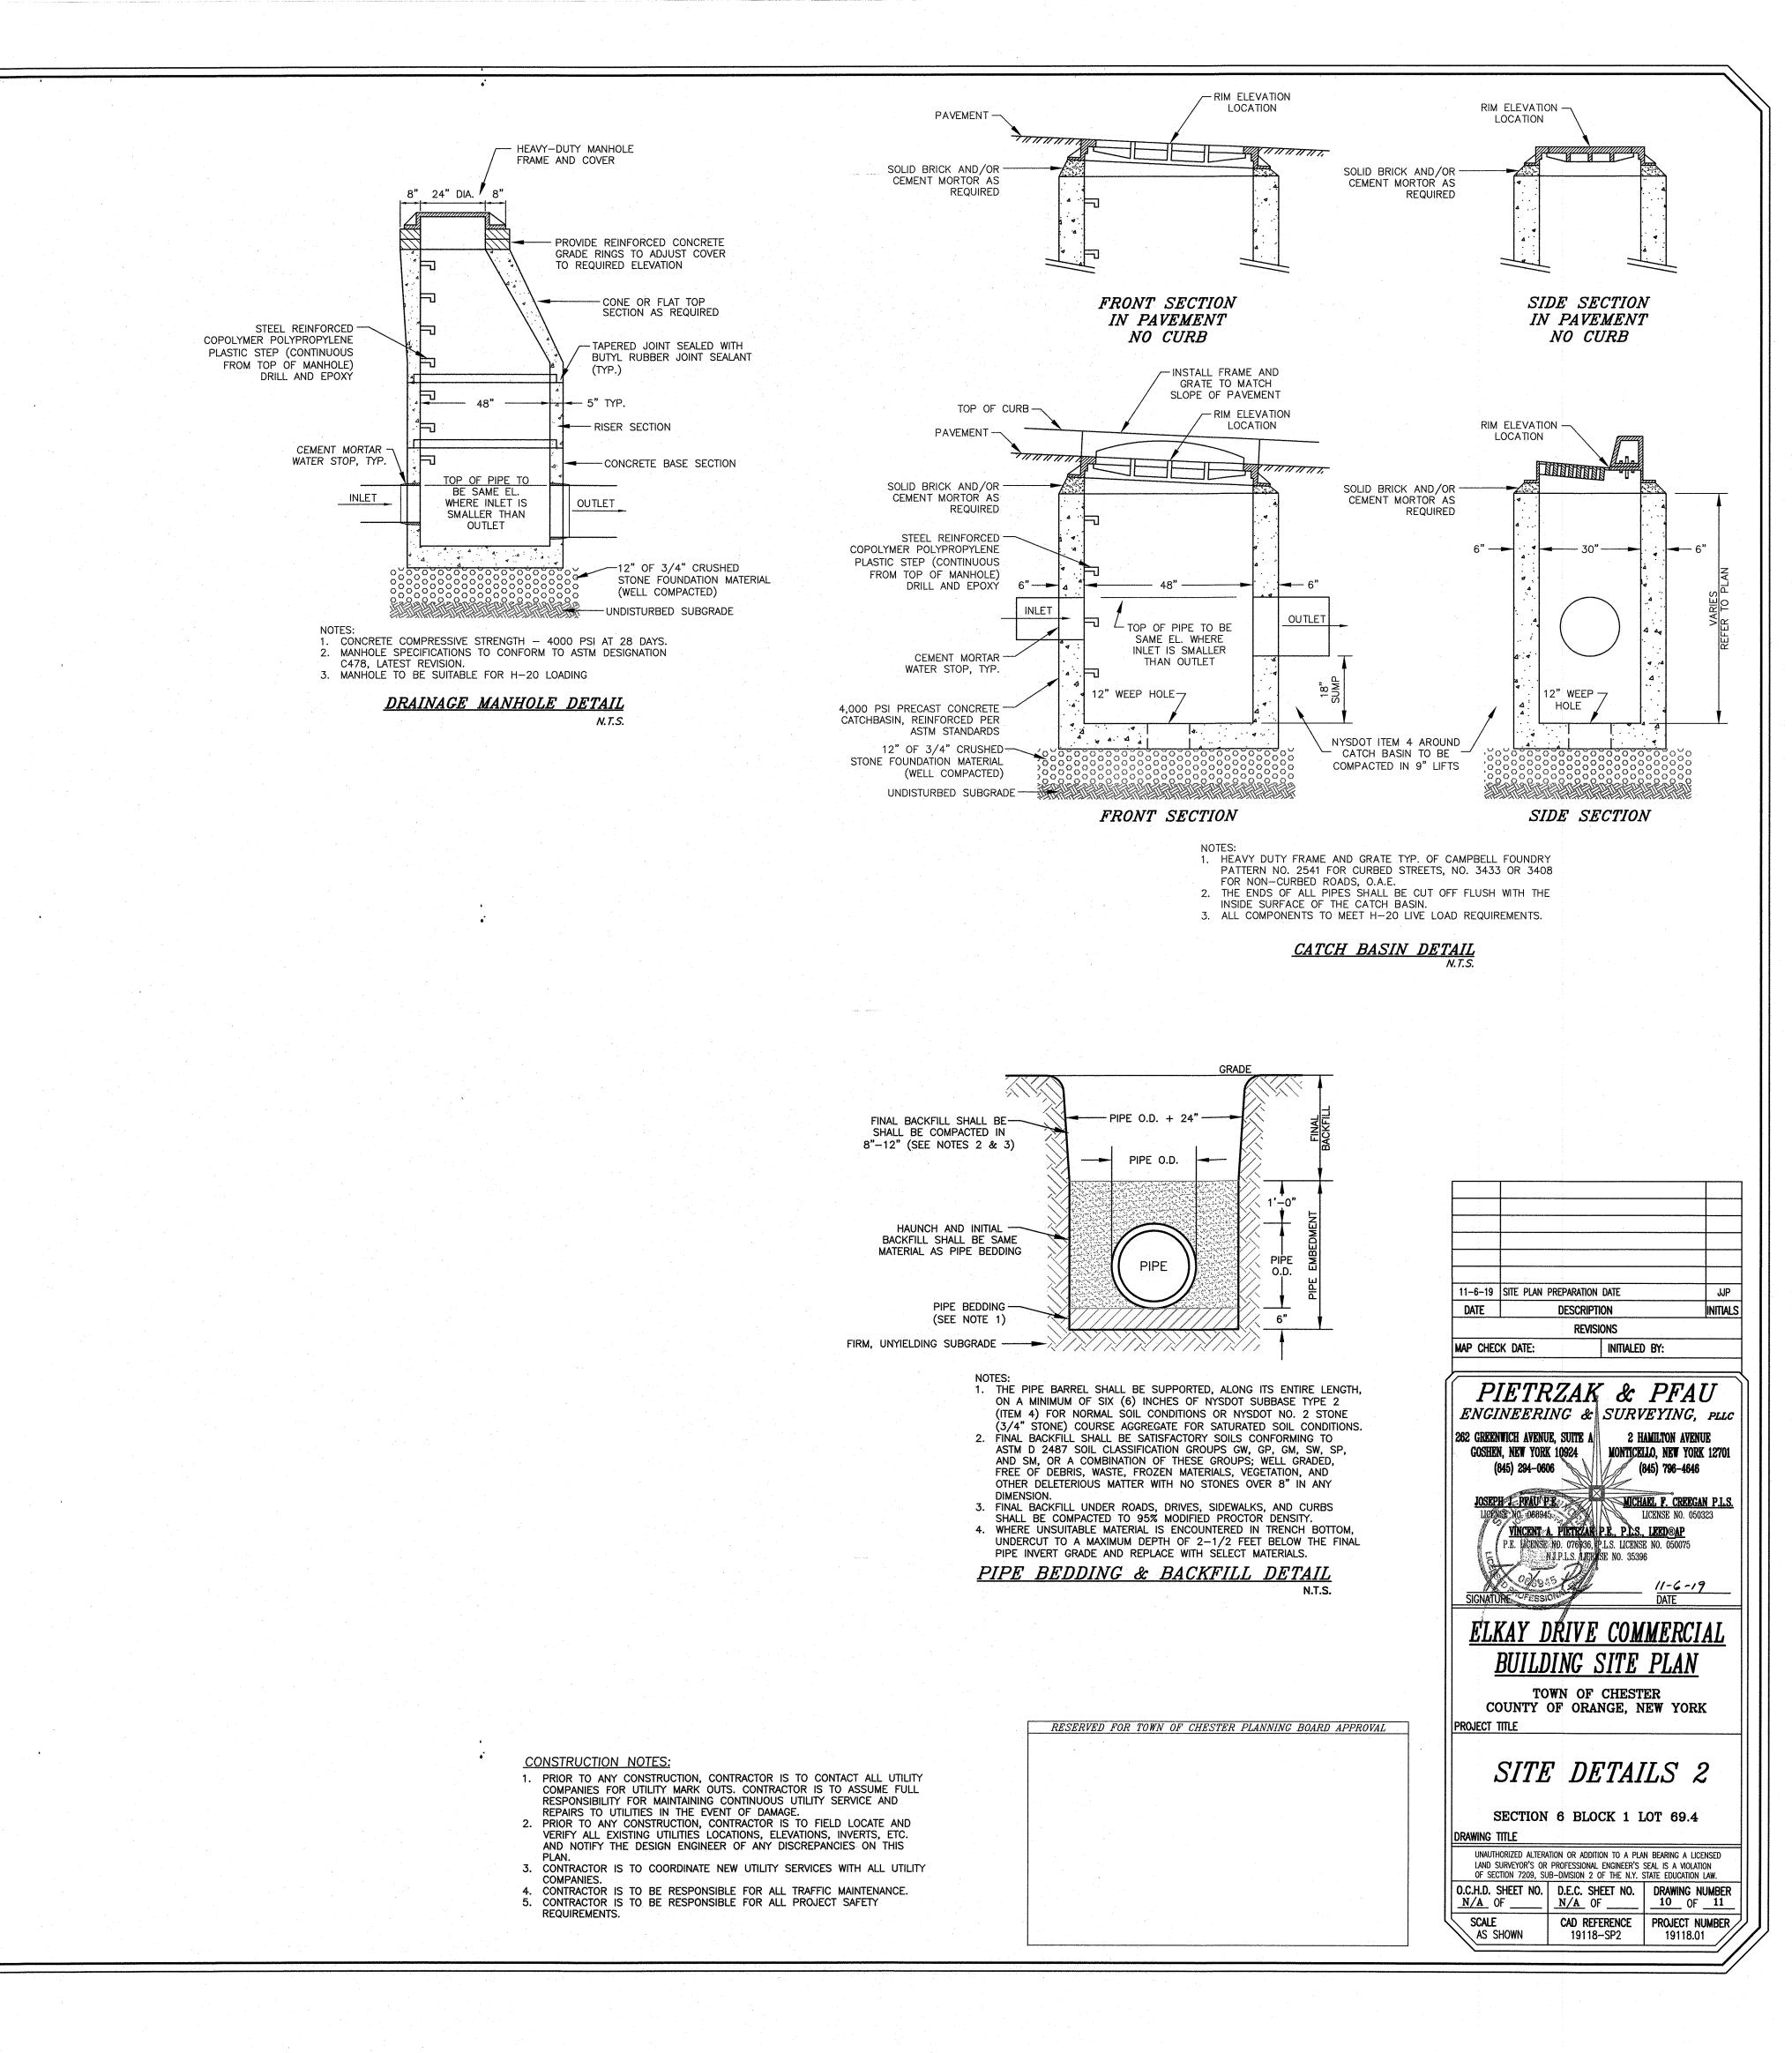

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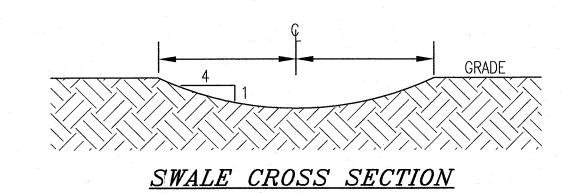


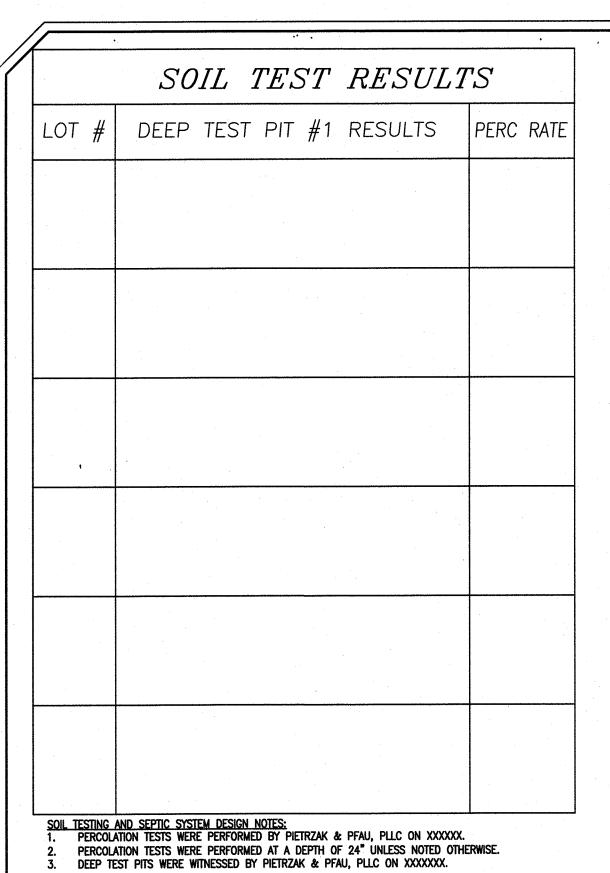


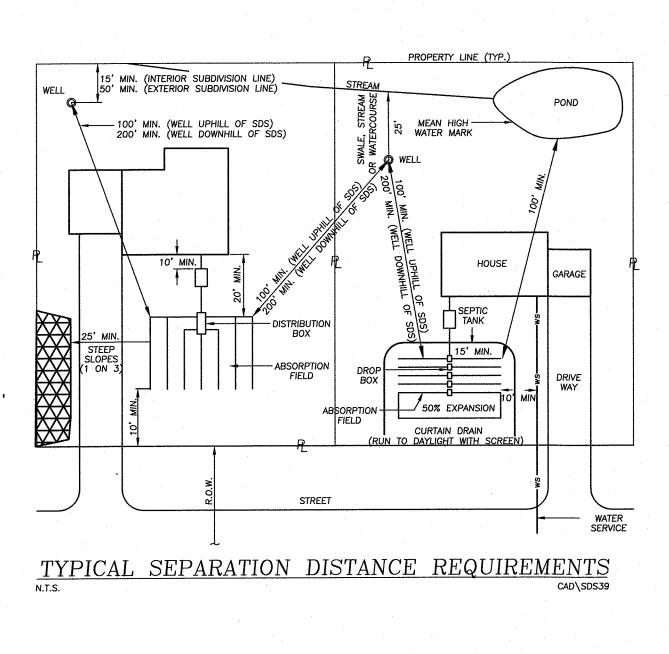
1. DROP BOX TO BE AS MANUFACTURED BY WOODARD'S CONCRETE PRODUCTS,

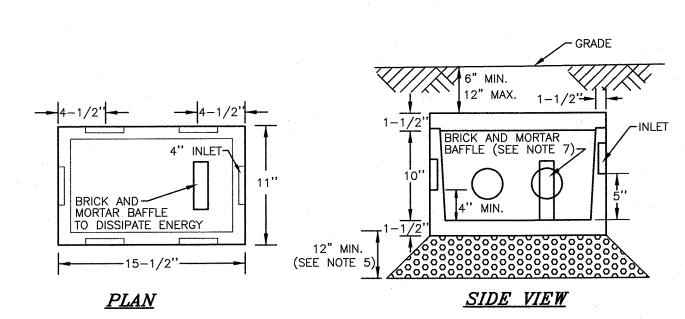- INC. MODEL NO. DB-6DB OR APPROVED EQUAL. 2. CONCRETE TO TEST 4,000 PSI AT 28 DAYS. 3. ALL OUTLETS NOT USED SHALL REMAIN PLUGGED.
- 4. BOX TO BE INSTALLED WITH A MIN. 6" AND MAX. 12" EARTH COVER. 5. BOX TO BE INSTALLED ON 12" MIN OF SAND, PEA GRAVEL, OR TRENCH AGGREGATE.
- 6. PIPE JOINTS TO BE SEALED WITH POLYLOK SEAL OR EQUAL. 7. BRICK AND MORTAR BAFFLE TO BE INSTALLED IN THE CENTER, FOUR (4) INCHES FROM

5-OUTLET DROP BOX DETAIL



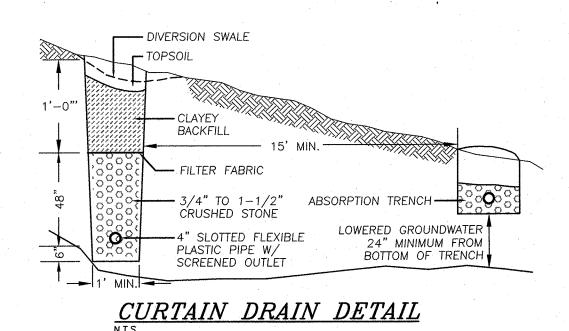

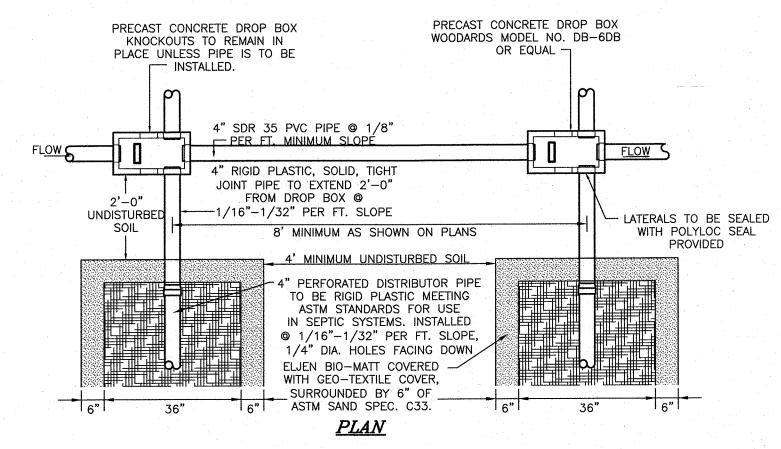


- ABSORPTION FIELDS SHALL NOT BE BUILT UNDER DRIVEWAYS, PARTS OF BUILDINGS, OR UNDER ABOVE GROUND POOLS, OR OTHER AREAS SUBJECT TO HEAVY LOADINGS. THE SAND BEDDING SHALL BE COVERED WITH THE GEOTEXTILE FABRIC PROVIDED WITH EACH UNIT. TRENCHES SHALL NOT BE CONSTRUCTED IN WET SOIL.
- . SIDES AND BOTTOM OF TRENCH SHALL BE RAKED IMMEDIATELY PRIOR TO PLACING SAND. THE END OF ALL DISTRIBUTOR PIPES SHALL BE PLUGGED. 6. HEAVY EQUIPMENT SHALL BE KEPT OFF THE AREA OF THE FIELD EXCEPT FOR ACTUAL CONSTRUCTION OF TEH FIELD. THERE SHALL BE NO UNNECESSARY MOVEMENT OF CONSTRUCTION


EQUIPMENT IN THE AREA OF THE PROPOSED FIELD, BEFORE OR AFTER CONSTRUCTION.

. DISTRIBUTION LATERALS SHALL BE SLOPED AT 1/16"-1/32" PER FOOT. 8. ABSORPTION TRENCH BOTTOM TO BE SET LEVEL. 9. DISTRIBUTION LATERALS ARE TO BE SET WITH PERFORATIONS FACING DOWN.

# ELJEN IN-DRAIN SYSTEM DROP BOX/ABSORPTION TRENCH DETAIL

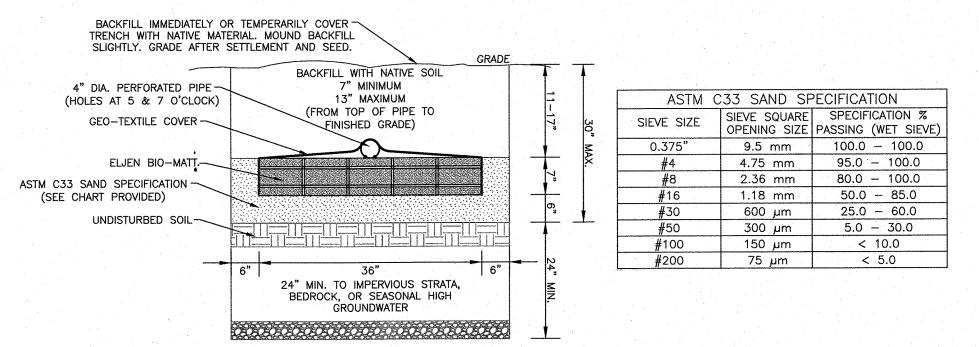



ELJEN IN-DRAIN CROSS SECTION DETAIL

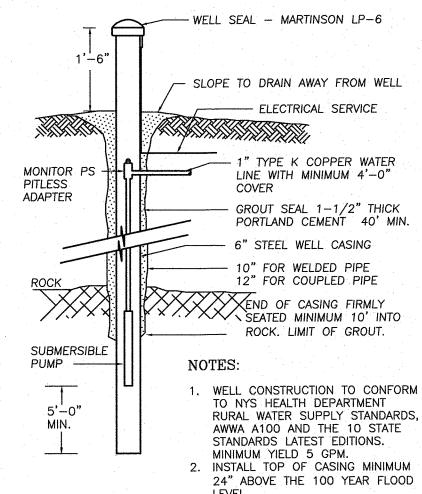


LEVEL. WELL DETAIL 3. ANTICIPATED DEPTHS OF WELL CASINGS ARE 40' AND THROUGH

- BEDROCK. 4. DIAMETER OF DRILL HOLES TO BE 10"-12" THROUGH OVERBURDEN, AND 6" THROUGH ROCK. 5. IF WATER IS ENCOUNTERED AT A
- DEPTH OF LESS THAN 50 FEET, THE MINIMUM CASING AND REQUIREMENT SHALL BE 50 FEET.

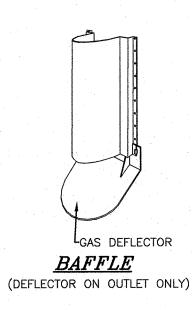

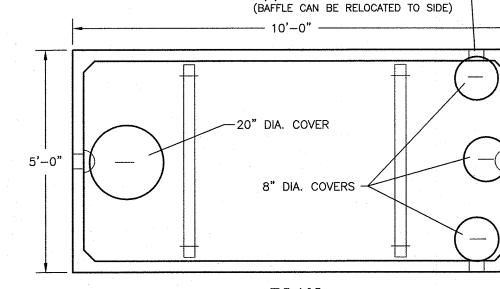

(3)-4" DIA. KNOCKOUT INLETS -

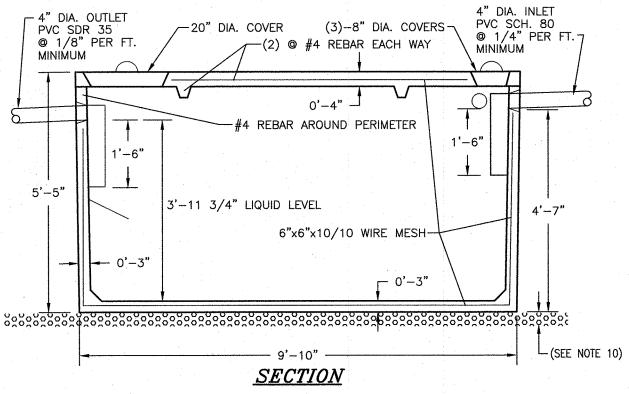


- BUILDING SEWER TO BE SCHEDULE 80 PVC. SEPTIC TANK TO BE INSTALLED A MINIMUM OF TEN (10) FEET
- FROM BUILDING FOUNDATION. LOCATION STAKE TO BE SET IN GROUND DIRECTLY ABOVE THE
- INLET END COVER. SEPTIC TANK TO BE COVERED WITH EARTH TO A MINIMUM DEPTH
- OF 6" AND A MAXIMUM DEPTH OF 12". PRECAST CONCRETE TO REACH 4000 PSI STRENGTH @ 28 DAYS. TANK CONSTRUCTION JOINTS TO BE SEALED WITH BUTYL RUBBER
- BASE CEMENT. INLET INVERT TO BE 3" HIGHER THAN OUTLET INVERT.
- INLET AND OUTLET JOINTS TO BE SEALED WITH PORTLAND CEMENT GROUT.

EVERY 2-3 YEARS.

- PRECAST CONCRETE SEPTIC TANK TO BE AS MANUFACTURED BY WOODARD'S CONCRETE PRODUCTS, INC. MODEL ST1250 OR EQUAL.
- 3" MINIMUM OF SAND, PEA GRAVEL OR TRENCH AGGREGATE FOR 11. SEPTIC TANKS SHOULD BE INSPECTED PERIODICALLY AND PUMPED


1,250 GALLON SEPTIC TANK DETAIL

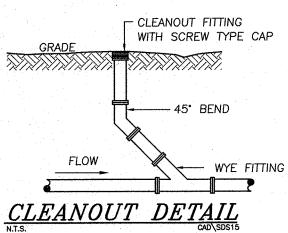

# **CONSTRUCTION NOTES:**

- 1. PRIOR TO ANY CONSTRUCTION, CONTRACTOR IS TO CONTACT ALL UTILITY COMPANIES FOR UTILITY MARK OUTS. CONTRACTOR IS TO ASSUME FULL RESPONSIBILITY FOR MAINTAINING CONTINUOUS UTILITY SERVICE AND REPAIRS TO UTILITIES IN THE EVENT OF DAMAGE
- 2. PRIOR TO ANY CONSTRUCTION, CONTRACTOR IS TO FIELD LOCATE AND VERIFY ALL EXISTING UTILITIES LOCATIONS, ELEVATIONS, INVERTS, ETC. AND NOTIFY THE DESIGN ENGINEER OF ANY DISCREPANCIES ON THIS
- 3. CONTRACTOR IS TO COORDINATE NEW UTILITY SERVICES WITH ALL UTILITY COMPANIES.
- CONTRACTOR IS TO BE RESPONSIBLE FOR ALL TRAFFIC MAINTENANCE. 5. CONTRACTOR IS TO BE RESPONSIBLE FOR ALL PROJECT SAFETY REQUIREMENTS.

RESERVED FOR TOWN OF CHESTER PLANNING BOARD APPROVAL

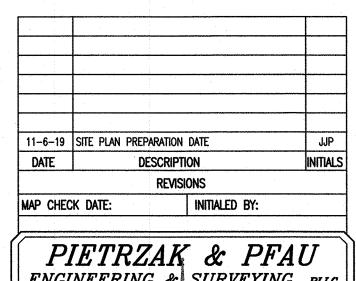



COUNTY OF ORANGE, NEW YORK

SANITARY & WATER SUPPLY DETAILS SECTION 6 BLOCK 1 LOT 69.4

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