



REFERENCE: GOOGLE EARTH (IMAGERY DATE 9/18/2019)

SITE PLAN FOR TRADE TRANS CORPORATION 173 BLACK MEADOW ROAD SECTION 6 BLOCK 1 LOT 106 TOWN OF CHESTER ORANGE COUNTY, N.Y.

DRA	DRAWING LIST						
T-1	TITLE SHEET						
S-1	EXISTING CONDITIONS						
S-2	SITE PLAN						
S-3	GRADING & UTILITIES PLAN						
S-4	STORMWATER DETAILS						
S-5	LIGHTING & LANDSCAPING PLAN						
S-6	EROSION & SEDIMENTATION CONTROL PLAN						
S-7	EROSION & SEDIMENTATION CONTROL PLAN DETAILS						
S-8	SEPTIC DETAILS						
S-9	CONSTRUCTION DETAILS						

PLANNING BOARD APPROVAL

TOWN OF CHESTER

#### PROJECT INFORMATION

KIPS BAY HOLDINGS OF WARWICK, LLC. OWNER OF RECORD

IP (INDUSTRIAL PARK DISTRICT) ZONING

TAX ID SECTION 06 BLOCK 01


TOTAL LOT AREA 418,612 S.F. / 9.61± ACRES THIS PLAN CONTAINS 10 SHEETS. THIS SHEET SHALL NOT BE CONSIDERED VALID UNLESS ACCOMPANIED BY THE REMAINING SHEETS.


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	DO	1	REVISED PER TOWN COMMENT	11/23/22		
UNAUTHORIZED ALTERATION OR ADDITIONS TO A PLAN BEARING						
THE SEAL OF A LICENSED ENGINEER OR LAND SURVEYOR IS A VIOLATION OF SECTION 7209 SUBDIVISION 2 OF THE NEW YORK						077703-1 E
STATE EDUCATION LAW.						IOFESSION
COPIES OF THIS DOCUMENT WITHOUT A FACSIMILE OF THE						•
SIGNATURE AND AN ORIGINAL EMBOSSED SEAL OR ORIGINAL STAMP IN BLUE OR RED INK OF THE PROFESSIONAL ENGINEER OF						JOHN D. FULLER
LAND SURVEYOR SHALL NOT BE CONSIDERED VALID COPIES.						REG. NO. 077703


JOHN D. FULLER, P.E., P.C. PORT JERVIS, NY 12771


SITE PLAN FOR TRADE TRANS CORPORATION 173 BLACK MEADOW ROAD SECTION 6 BLOCK 1 LOT 106 TOWN OF CHESTER, NY

TITLE SHEET T-1 JOB NO. 1713.003

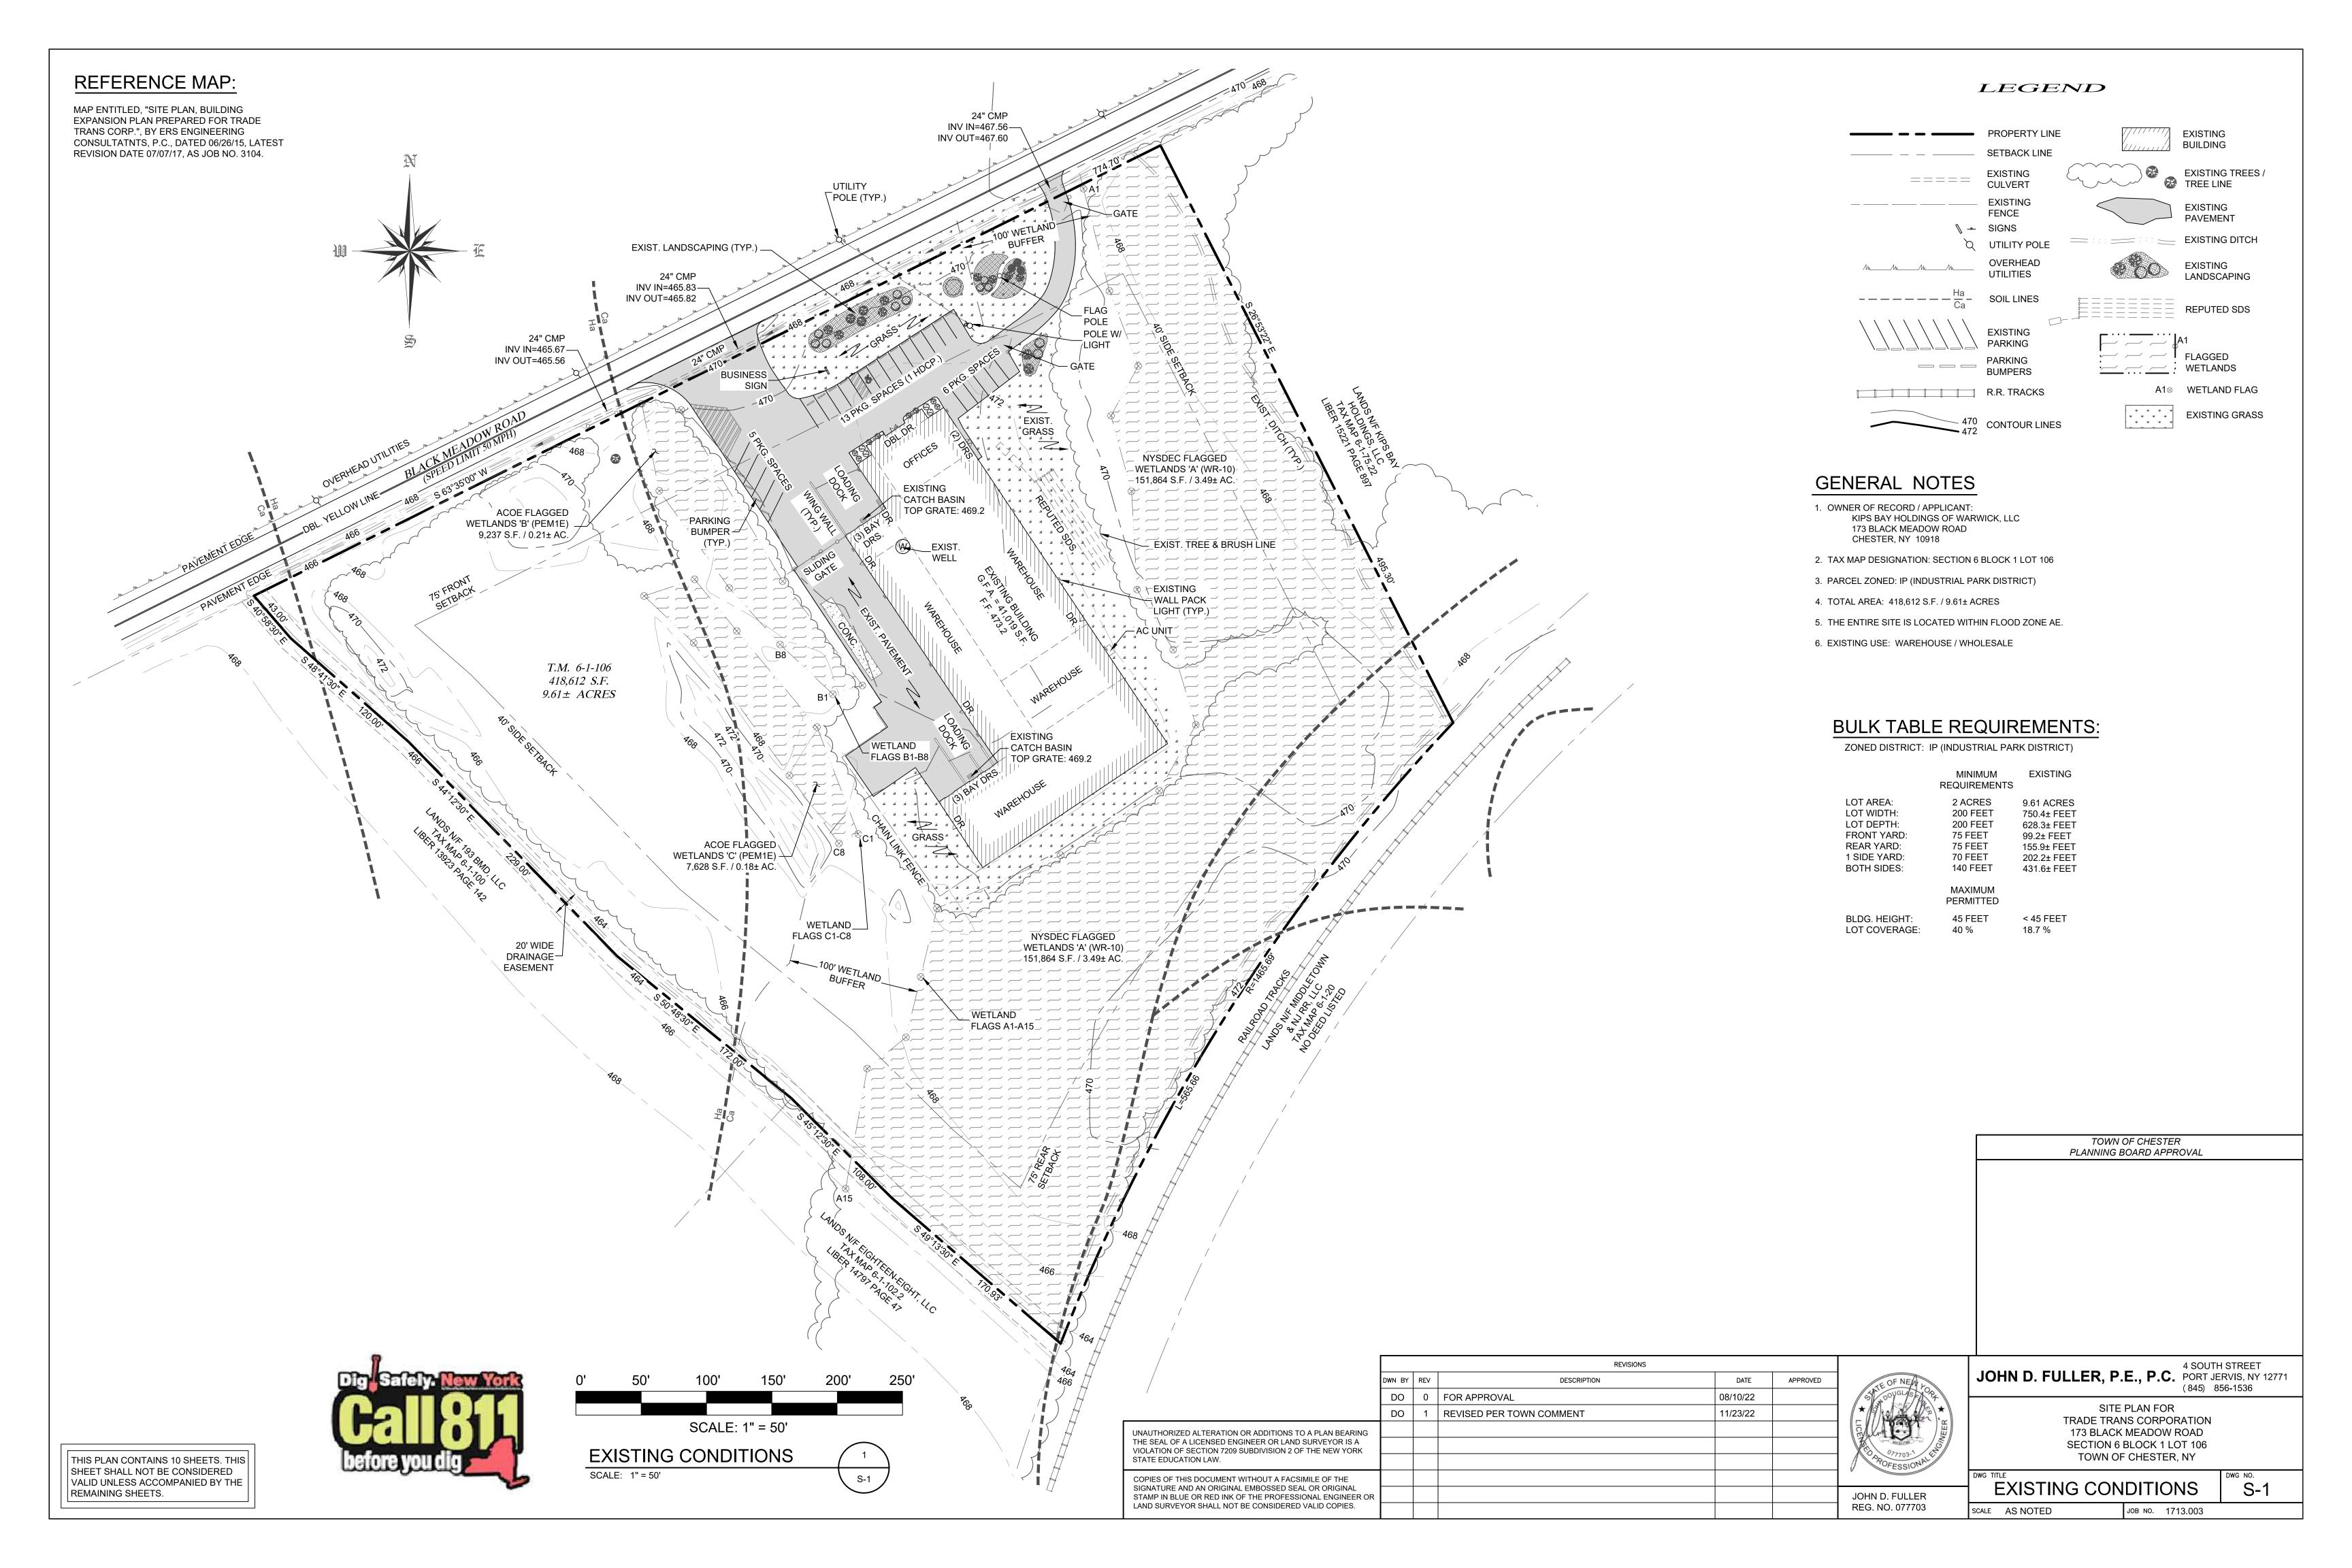

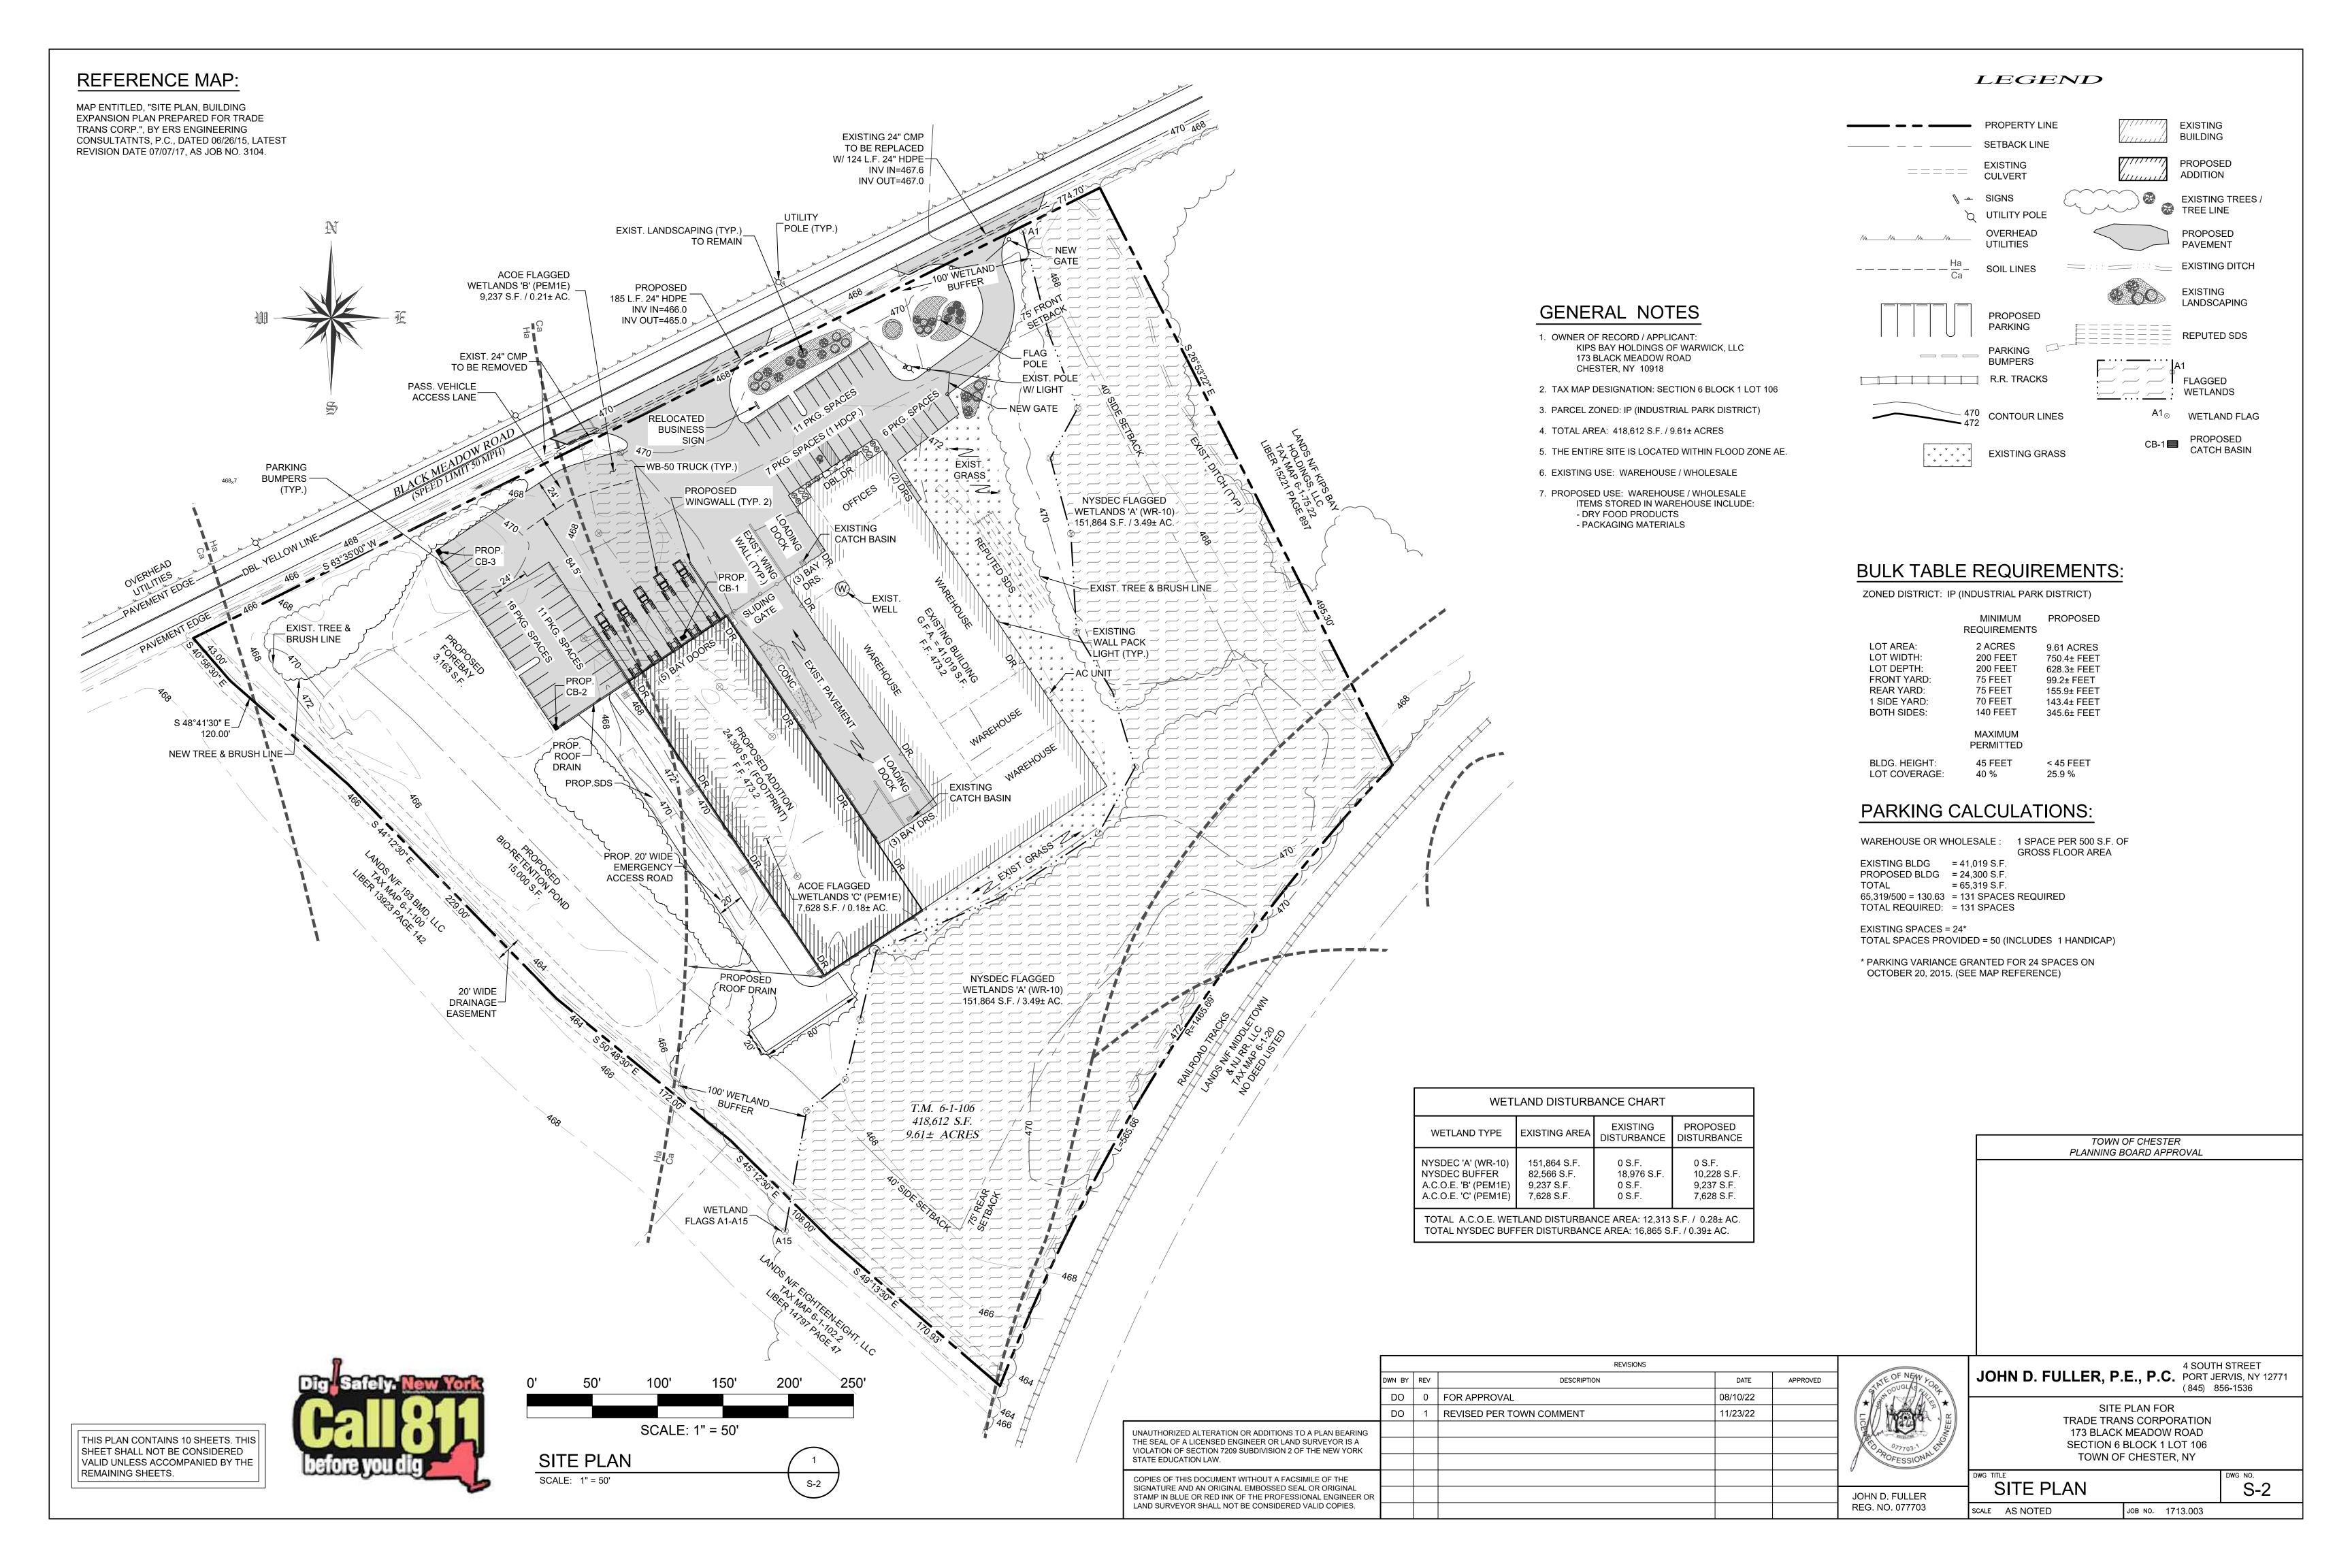


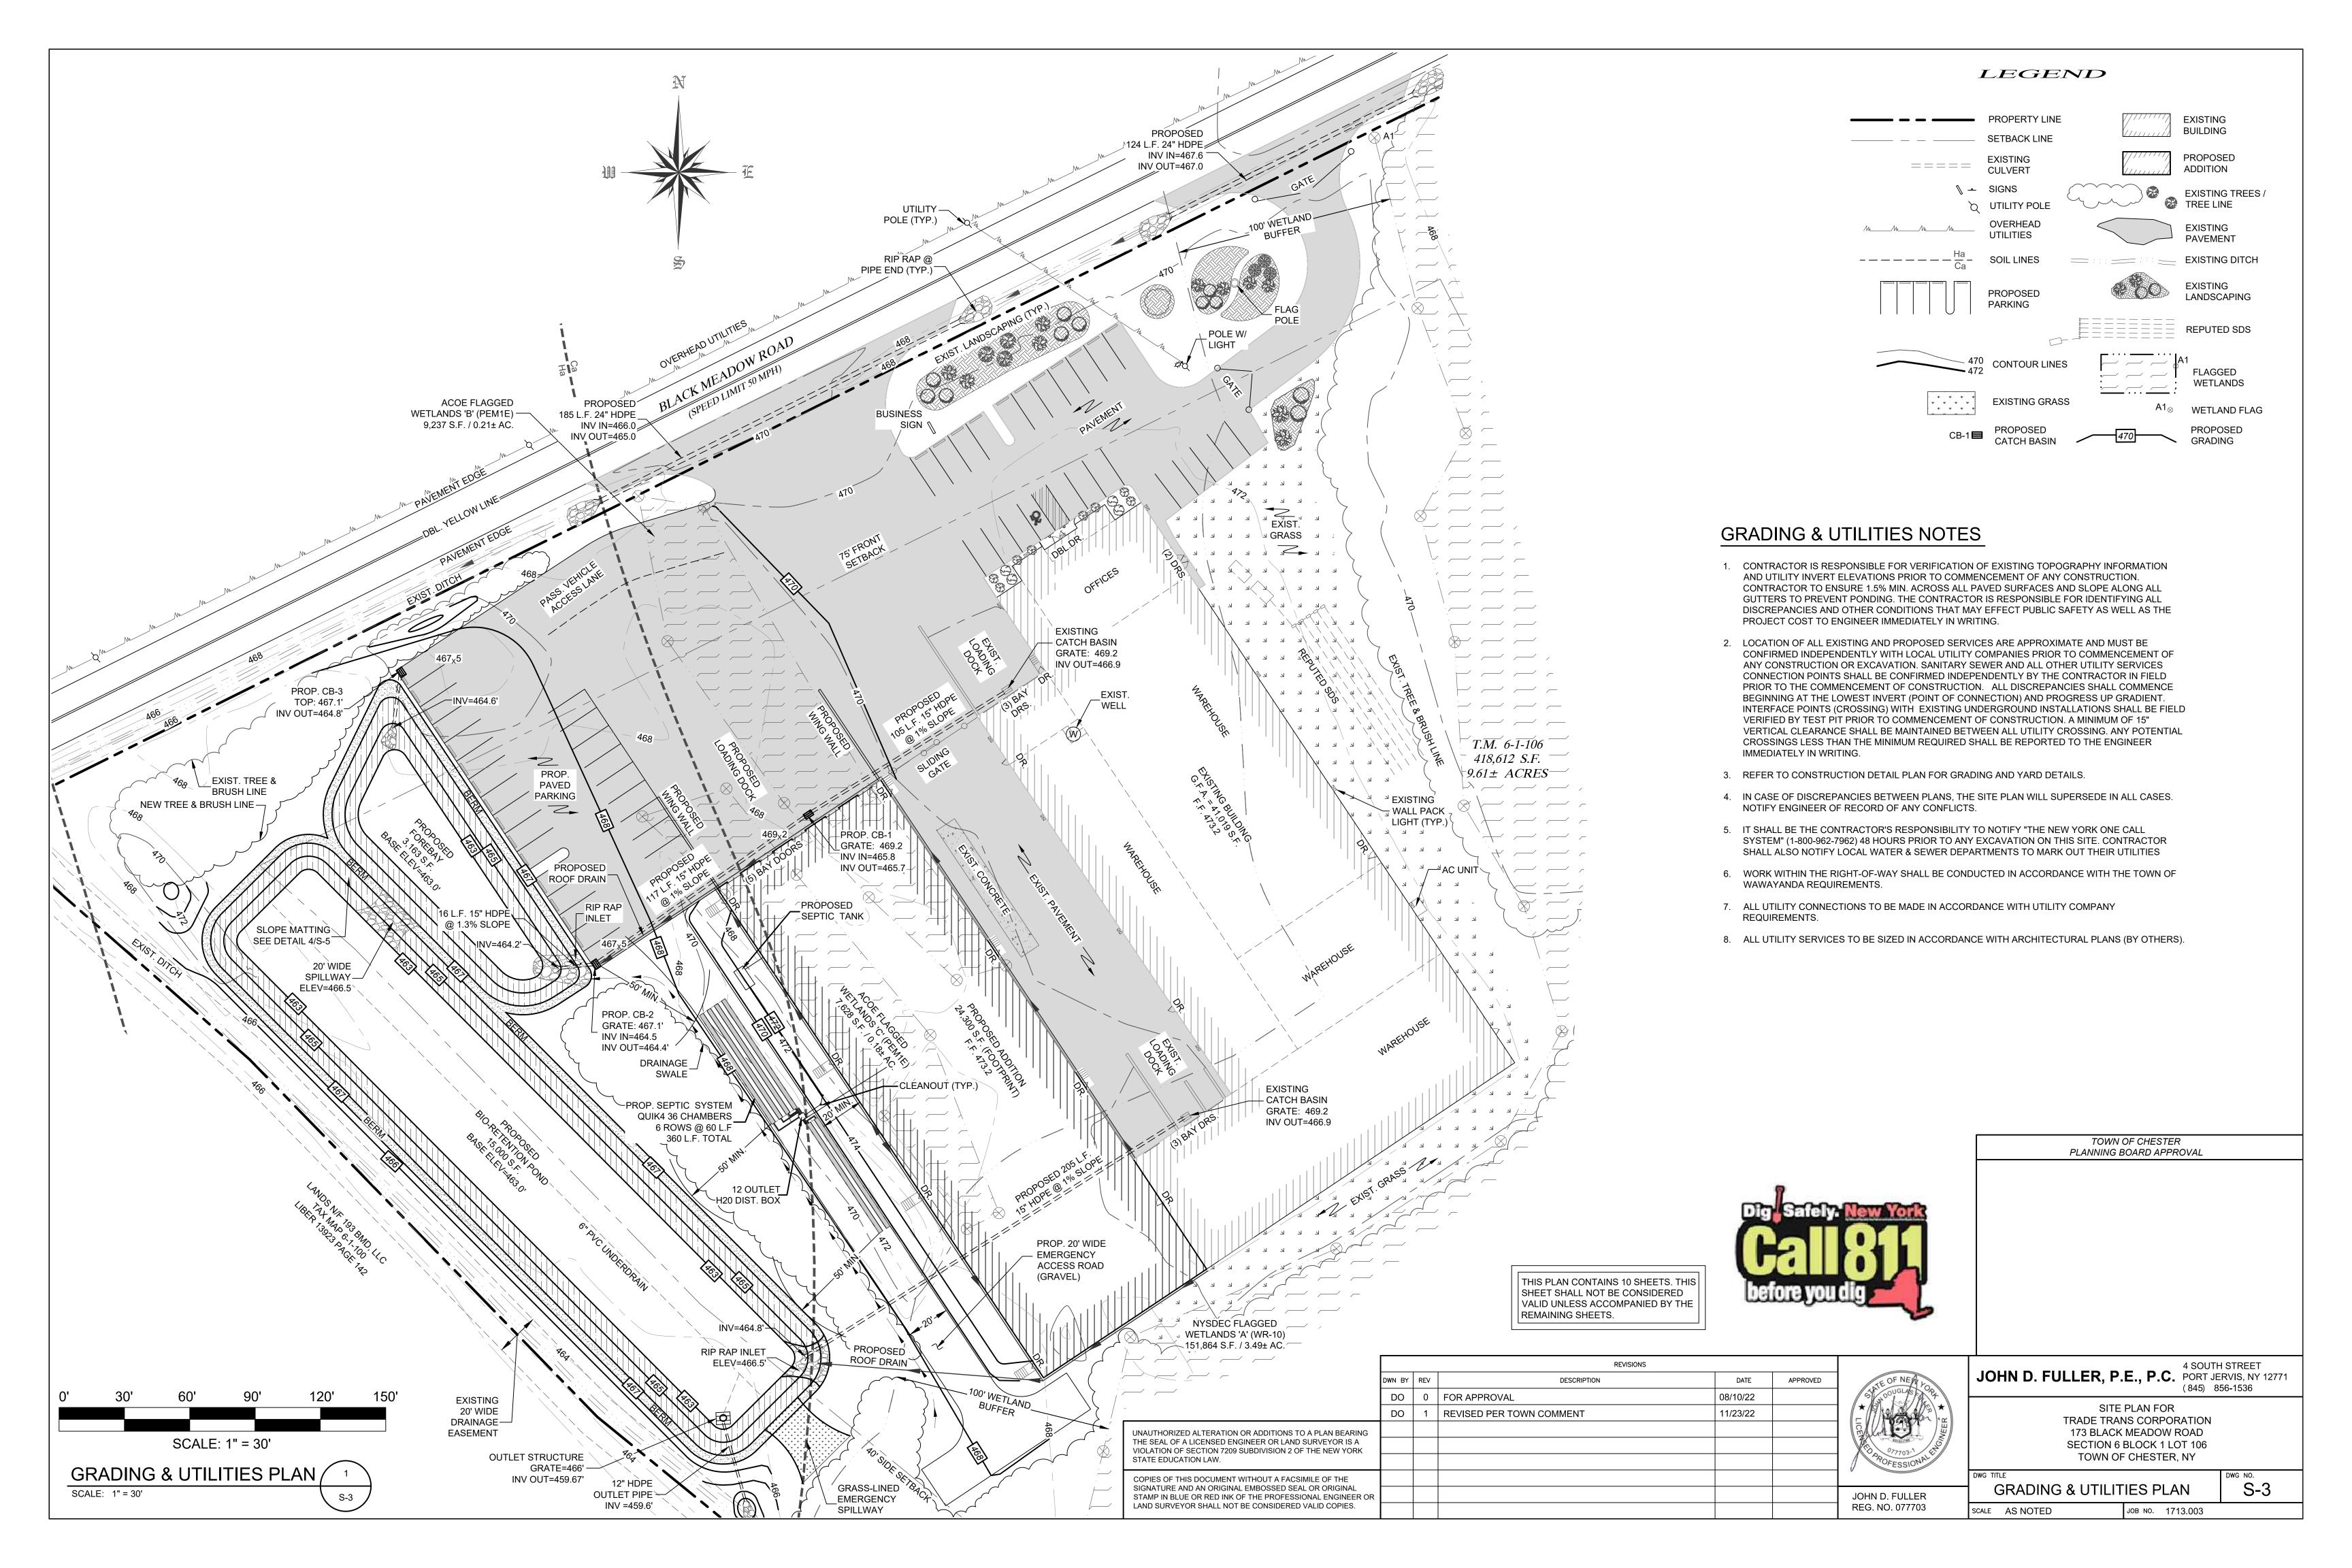

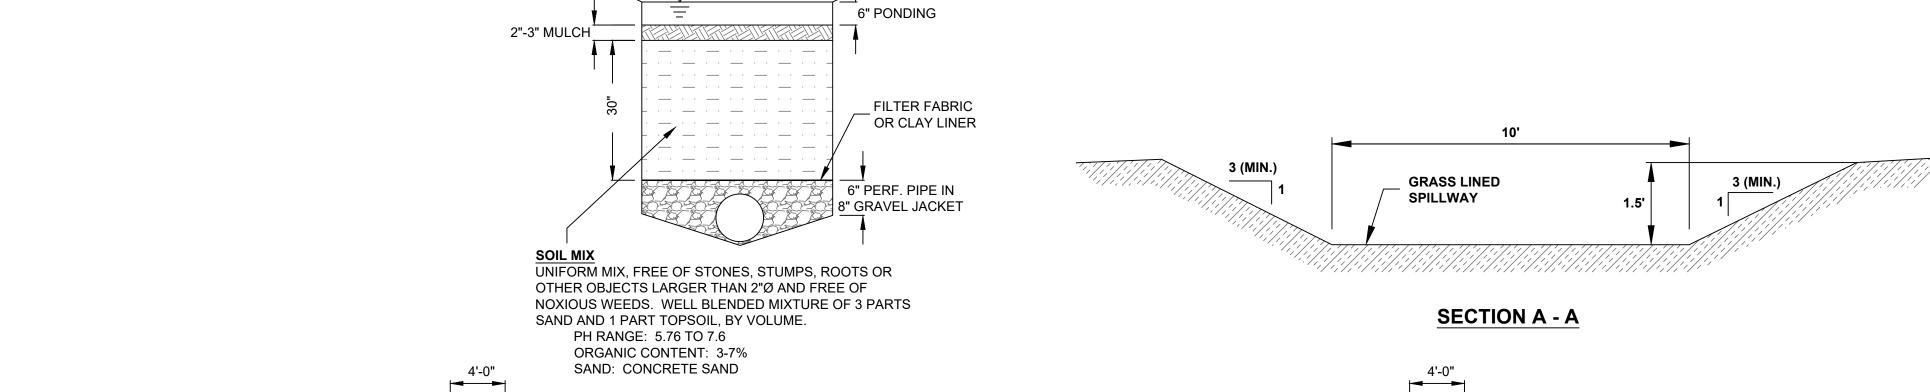

OF NOXIOUS WEEDS. WELL BLENDED MIXTURE OF 3 PARTS SAND AND 1 PART TOPSOIL, BY VOLUME.

PH RANGE: 5.76 TO 7.6 ORGANIC CONTENT: 3-7% SAND: CONCRETE SAND

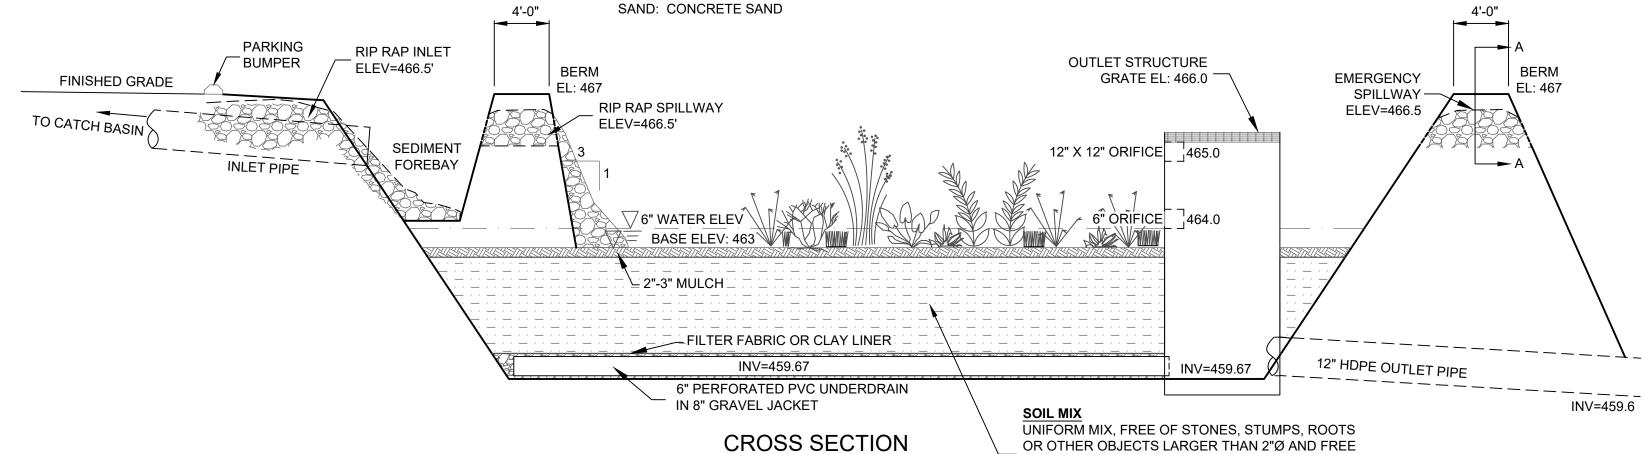

SCALE: NONE

3'6", 4'6", OR 5'6"

1', 2', & 3' HEIGHTS.

2' 8" **TOP VIEW** 

PRECAST CATCH BASIN

Woodard's Concrete Products, Inc.

629 Lybolt Road, Bullville, NY 10915

(845) 361-3471 / Fax 361-1050

\*PROVIDE WOODARDS PRODUCT OR EQUAL

MODEL CB-30X48

TONGUE & GROOVE JOINT

TO MATCH RISERS

KNOCKOUT

**OPENINGS** 

PRECAST CATCH BASIN DETAIL

MATCHING RISERS ARE AVAILABLE IN

OPTIONAL 8" THICK FLAT TOP

MODEL CS-42X60 -

SIDE VIEW

Air Entrainment: 5%

SPECIFICATIONS

Concrete Min. Strength: 4,000 psi at 28 days Reinforcement: #4 Rebar / ASTM A615

Weights: 3' Base = 3,400 lbs, 4' Base = 3,900

Construction Joint: Butyl Rubber Sealant

5' Base = 4,400 lbs, Risers = 1,100 lbs/vf

Load Rating: H20 / ASTM C857

SCALE: N. T. S.

**BIORETENTION POND DETAIL** 

BIORETENTION POND PLANTING LIST						
SYM COMMON NAME BOTANICAL NAME AN						
Ŵ	CATTAIL	TYPHA SP.	20			
2000	ARROW ARUM	PELTANDRA VIRGINICIA	20			
	BLUE FLAG IRIS	IRIS VERSICOLOR	20			
WWW	BUSHY BEARDGRASS	ANDROPOGON GLOMERATUS	30			
	MARSH HIBISCUS	HIBISCUS MOSCHEUTOS	20			
*	SWEET FLAG	ACORUS CALAMUS	25			
- TO THE REAL PROPERTY OF THE PERTY OF THE P	WOOL GRASS	SCIRPUS CYPERINUS	25			

PLANTS TO BE SPACED IN A 10' X 10' GRID WITH A TOTAL OF 160 PLANTS

GRASS LINING 2' MIN.

INFILTRATION TEST RESULTS

HOLE (IN.)\*

24

DATE TEST NO.

IPT - 1

IPT - 2

IPT - 2

\*DEPTH IS BELOW THE BOTTOM OF BASIN.

DEPTH OF STABILIZED

RATE (MIN.)


RATE (MIN.)

#### **CHANNEL CROSS-SECTION**

#### CONSTRUCTION SPECIFICATIONS:

- 1. ALL TREES, BRUSH, STUMPS, OBSTRUCTIONS AND OTHER OBJECTIONABLE SHALL BE REMOVED AND DISPOSED OF SO AS NOT TO INTERFERE WITH THE PROPER FUNCTIONING OF THE WATERWAY.
- 2. THE WATERWAY SHALL BE EXCAVATED OR SHAPED TO LINE, GRADE AND CROSS SECTION AS REQUIRED TO MEET THE CRITERIA SPECIFIED HEREIN, AND BE FREE OF BANK PROJECTIONS
- 3. ALL EARTH REMOVED AND NOT NEEDED IN CONSTRUCTION SHALL BE SPREAD OR DISPOSED OF SO THAT IT WILL NOT INTERFERE WITH THE FUNCTIONING OF THE WATERWAY. OR OTHER IRREGULARITIES WHICH WILL IMPEDE NORMAL FLOW.
- 4. FILL SHALL BE COMPACTED AS NEEDED IN CONSTRUCTION TO PREVENT UNEQUAL SETTLEMENT THAT WOULD CAUSE DAMAGE IN THE COMPLETED



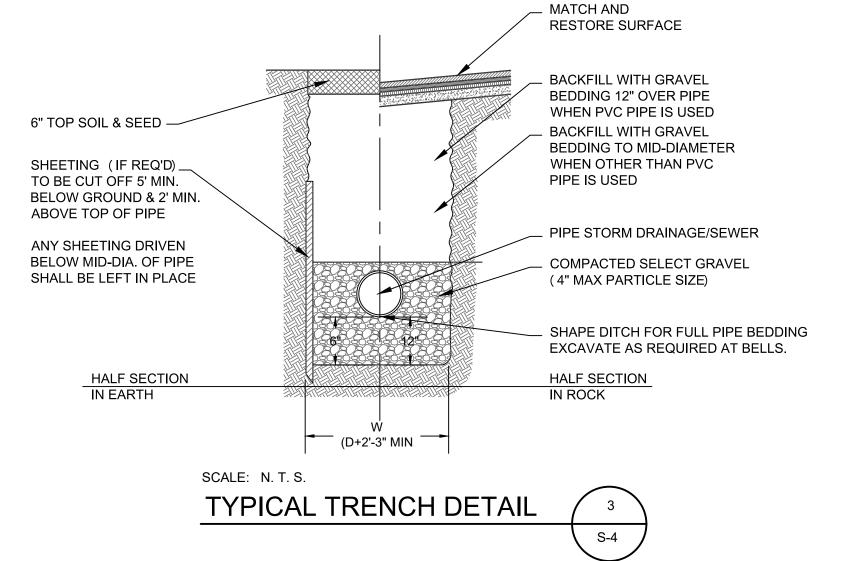

LAND SURVEYOR SHALL NOT BE CONSIDERED VALID COPIES.

THIS PLAN CONTAINS 10 SHEETS. THIS SHEET SHALL NOT BE CONSIDERED



PLANNING BOARD APPROVAL

TOWN OF CHESTER

VALID UNLESS ACCOMPANIED BY THE REMAINING SHEETS.

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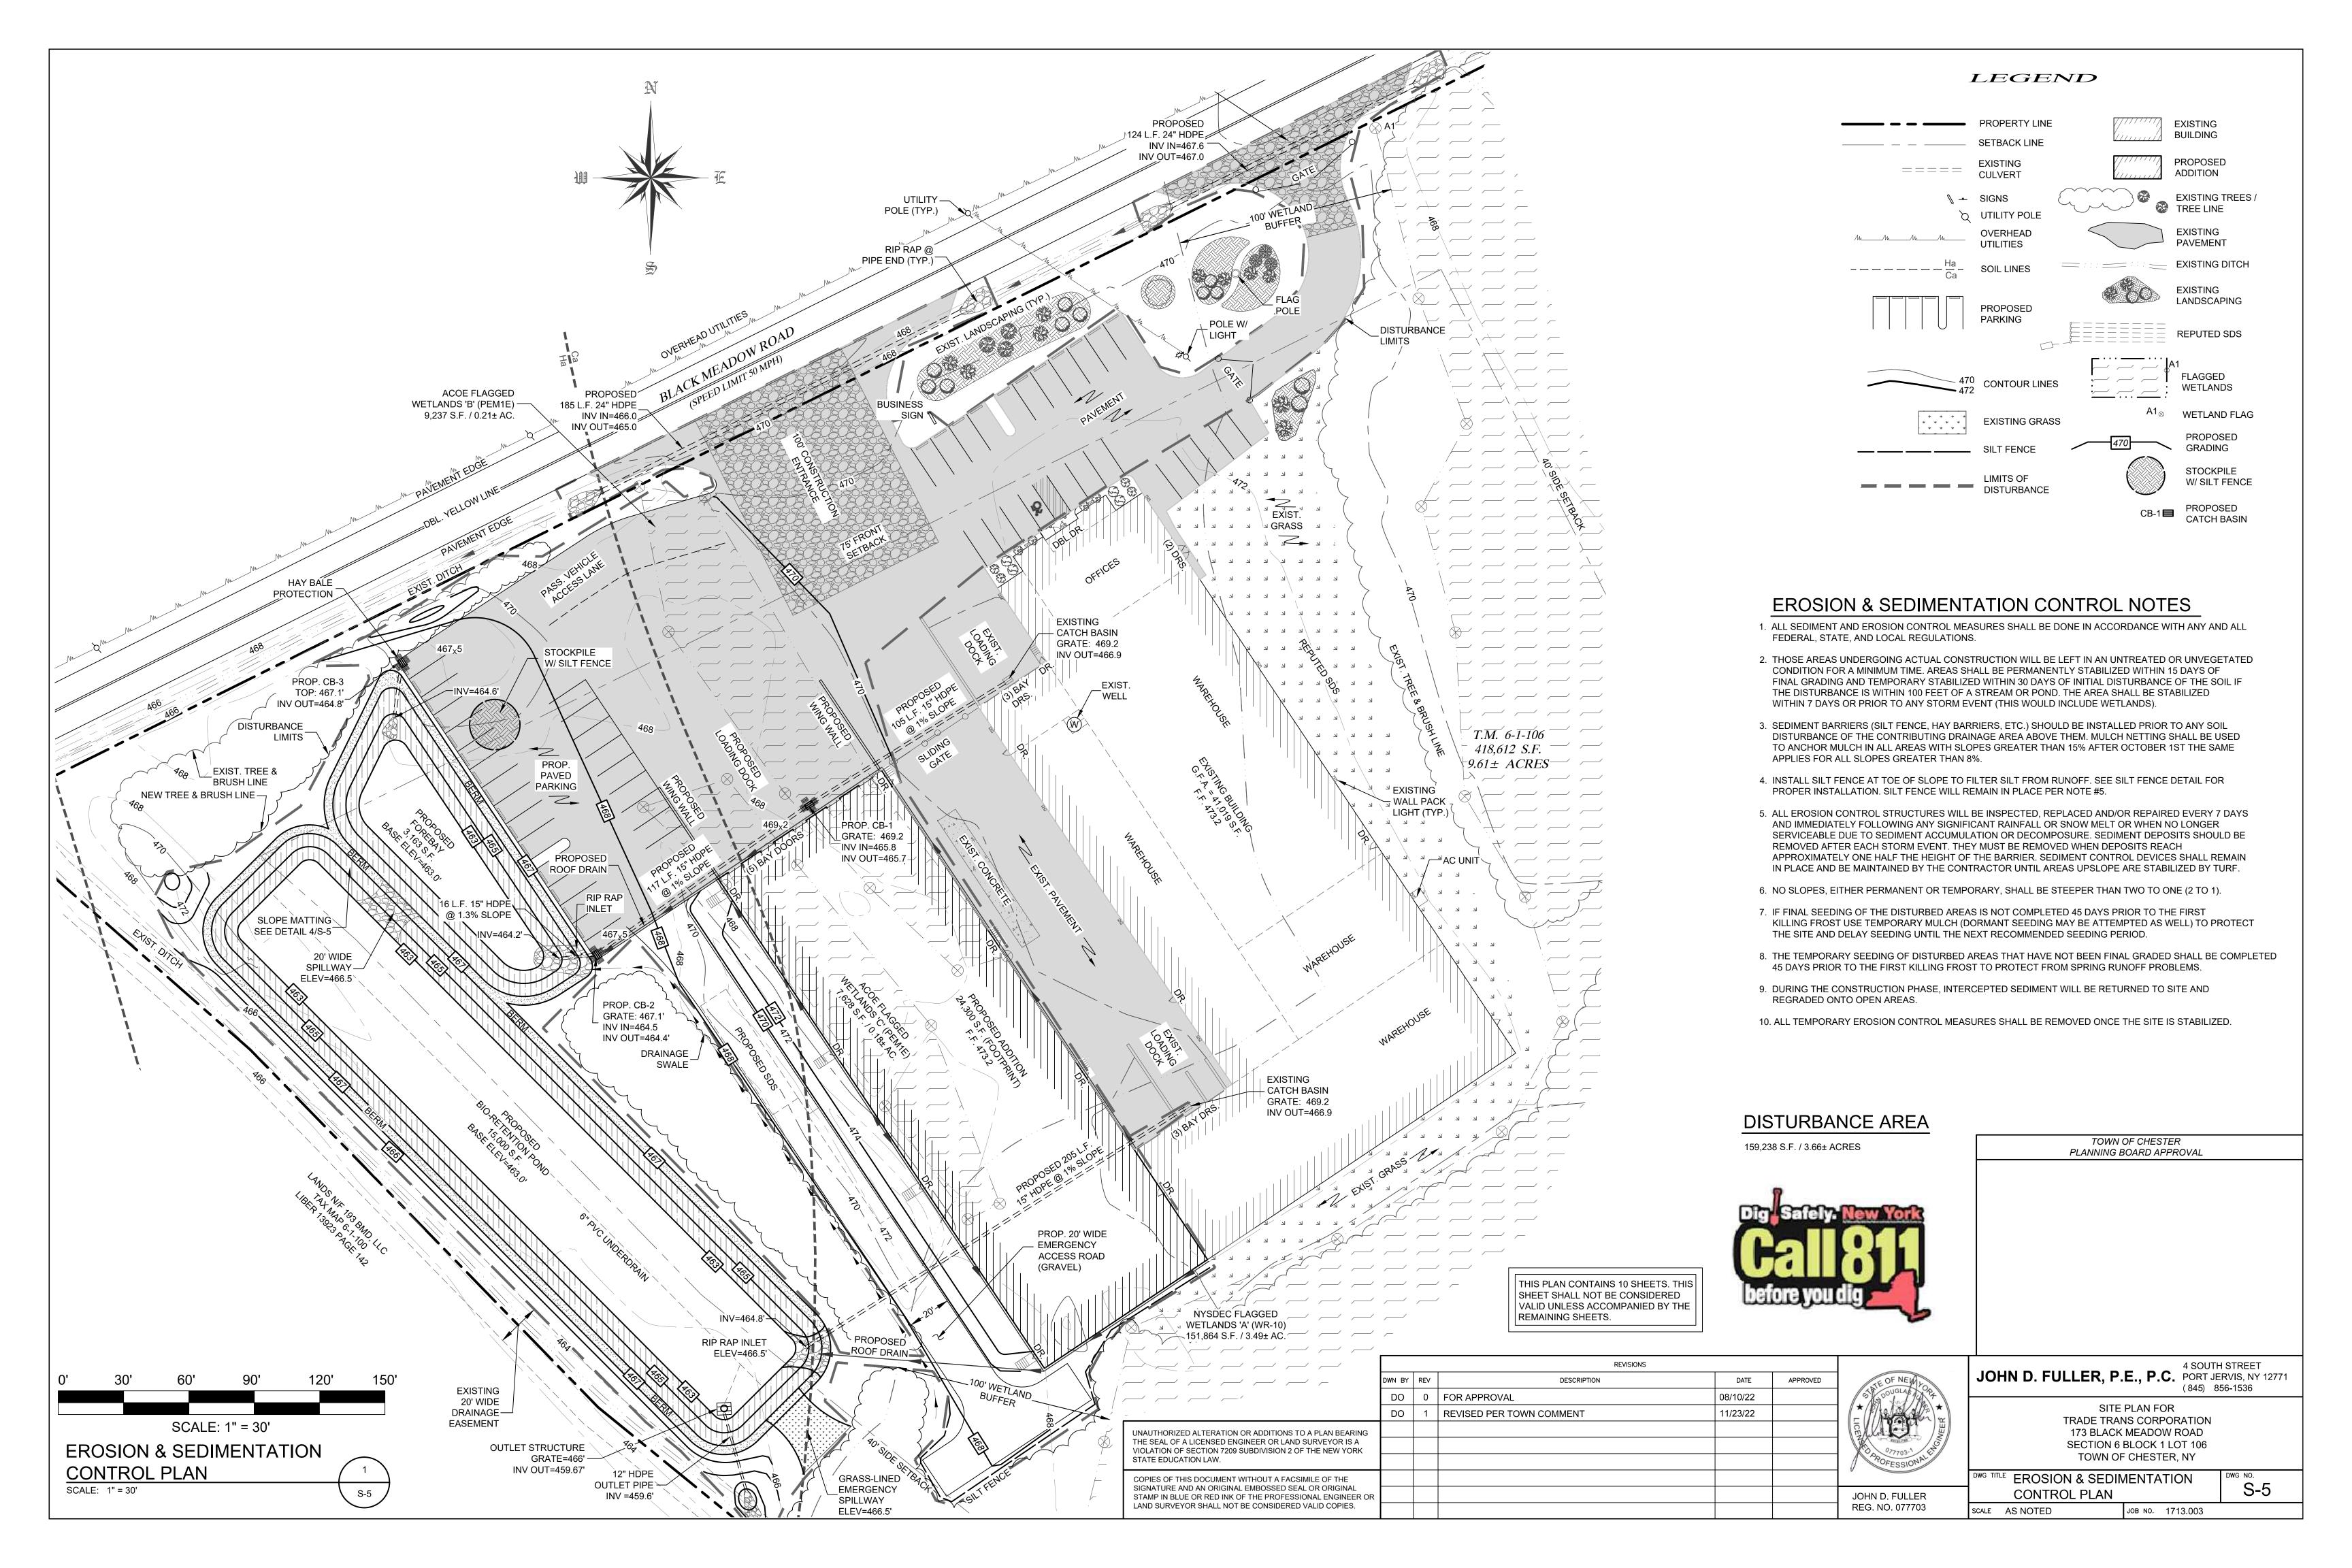



REG. NO. 077703

4 SOUTH STREET JOHN D. FULLER, P.E., P.C. PORT JERVIS, NY 12771 (845) 856-1536


> SITE PLAN FOR TRADE TRANS CORPORATION 173 BLACK MEADOW ROAD SECTION 6 BLOCK 1 LOT 106 TOWN OF CHESTER, NY

DWG TITLE		DWG NO.
STORMWATER DE	S-4	
SCALE AS NOTED	JOB NO. 1713.003	



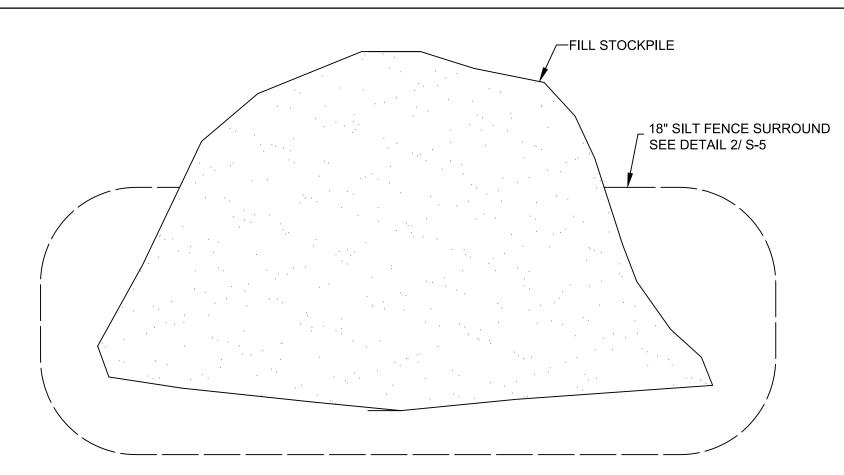

STOCKPILE HEIGHTS MUST NOT EXCEED 35 FEET. STOCKPILE SLOPES MUST BE 2:1 OR FLATTER.

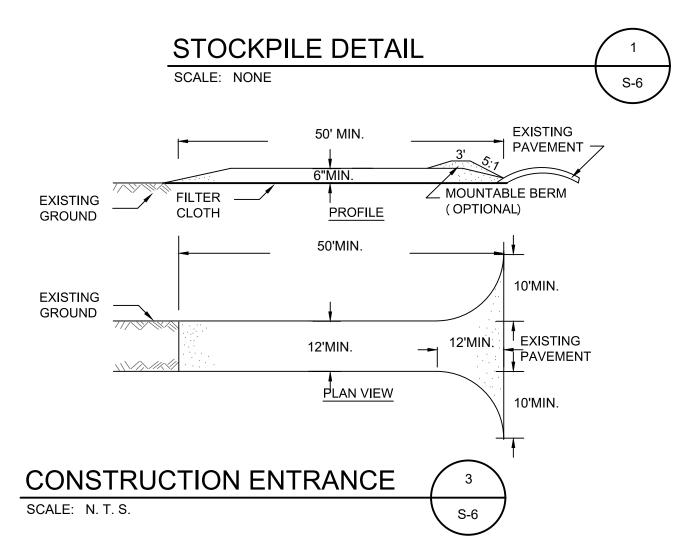


#### CONSTRUCTION SPECIFICATIONS

- 1. STONE SIZE = USE 2" STONE, OR RECLAIMED OR RECYCLED CONCRETE EQUIVALENT.
- 2. LENGTH = NOT LESS THAN FIFTY (50) FEET (EXCEPT ON A SINGLE RESIDENCE LOT WHERE A 30 FOOT MINIMUM LENGTH WOULD APPLY).
- 3. THICKNESS = NOT LESS THAN SIX (6) INCHES.

A MOUNTABLE BERM WITH 5:1 SLOPES WILL BE PERMITTED.

- 4. WIDTH = TWELVE (12) FOOT MINIMUM, BUT NOT LESS THAN THE FULL WIDTH AT POINTS WHERE INGRESS OR EGRESS OCCUR. TWENTY-FOUR (24) FEET IF SINGLE ENTRANCE TO SITE.
- 5. FILTER CLOTH WILL BE PLACED OVER THE ENTIRE AREA PRIOR TO PLACING OF STONE.
- 6. SURFACE WATER ALL SURFACE WATER FLOWING OR DIVERTED TOWARD CONSTRUCTION ENTRANCES SHALL BE PIPED ACROSS THE ENTRANCE. IF PIPING IS IMPRACTICAL,
- 7. MAINTENANCE THE ENTRANCE SHALL BE MAINTAINED IN A CONDITION WHICH WILL PREVENT TRACKING OR FLOWING OF SEDIMENT ONTO PUBLIC RIGHTS-OF-WAY. ALL SEDIMENT SPILLED, DROPPED, WASHED OR TRACKED ONTO PUBLIC RIGHTS-OF-WAY MUST BE REMOVED IMMEDIATELY.
- 8. WHEN WASHING IS REQUIRED, IT SHALL BE DONE ON AN AREA STABILIZED WITH STONE AND WHICH DRAINS INTO AN APPROVED SEDIMENT TRAPPING DEVICE.
- 9. PERIODIC INSPECTION AND NEEDED MAINTENANCE SHALL BE PROVIDED AFTER EACH RAIN.

# WOVEN WIRE FENCE (MIN. 14 1/2 GAUGE W/ MAX. 6" MESH SPACING) 10' MAX. C. TO C. 36" MIN. LENGTH FENCE POSTS DRIVEN MIN. 16" INTO GROUND. HEIGHT OF FILTER = 16" MIN.

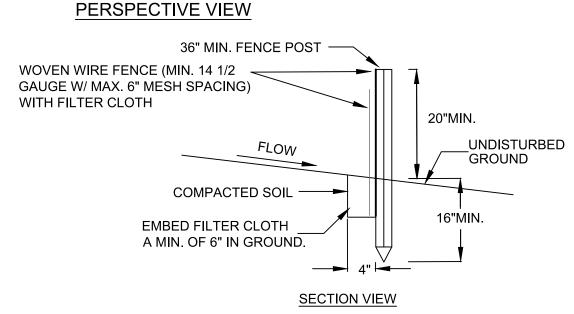

NORTH AMERICAN

**GREEN S75 EROSION** 

CONTROL BLANKET

PREPARE SEED BED

PRIOR TO BLANKET

INSTALLATION

REFER TO MANUF.

RECOMMENDED STAPLING

PATTERN FOR STEEPNESS

AND LENGTH OF SLOPE

BEING BLANKETED

(INCLUDING APPLICATION OF

LIME, FERTILIZER AND SEED)



**INSTALL BEGINNING OF** ROLL IN 6 IN. x 6 IN.

STAPLE, BACKFILL AND

ANCHOR TRENCH,

COMPACT SOIL-

STARTING AT TOP OF

IN DIRECTION OF WATER FLOW.

SLOPE, ROLL BLANKETS

OVERLAP BLANKET ENDS 6 IN.

DOWNSLOPE BLANKET (SHINGLE

SLOPE MATTING INSTALLATION DETAIL

SEED AND SOIL AMENDMENTS SHALL BE APPLIED ACCORDING TO THE RATES IN

PROVIDE ANCHOR TRENCH AT TOE OF SLOPE IN SIMILAR FASHION AS AT TOP OF

SLOPE SURFACE SHALL BE FREE OF ROCKS, CLODS, STICKS, AND GRASS.

BLANKETS SHALL BE RESTORED OR REPLACED WITHIN 4 CALENDAR DAYS.

MAINTAIN DIRECT CONTACT WITH SOIL. DO NOT STRETCH BLANKET.

BLANKET SHALL HAVE GOOD CONTINUOUS CONTACT WITH UNDERLYING SOIL THROUGHOUT ENTIRE LENGTH. LAY BLANKET LOOSELY AND STAKE OR STAPLE TO

THE BLANKET SHALL BE STAPLED IN ACCORDANCE WITH THE MANUFACTURER'S

BLANKETED AREAS SHALL BE INSPECTED WEEKLY AND AFTER EACH STORMWATER EVENT UNTIL PERENNIAL VEGETATION IS ESTABLISHED TO A MINIMUM UNIFORM 70% COVERAGE THROUGHOUT THE BLANKETED AREA. DAMAGED OR DISPLACED

THE PLAN DRAWINGS PRIOR TO INSTALLING THE BLANKET.

MIN. WITH THE UPSLOPE

BLANKED OVERLYING THE

STYLE). STAPLE SECURELY.

**BLANKET EDGES** 

STAPLED AND

OVERLAPPED

THE BLANKET

SHOULD NOT BE

STRETCHED; IT

**MUST MAINTAIN** 

SCALE: NONE

RECOMMENDATIONS.

GOOD SOIL

CONTACT


NOTES:

(4 IN. MIN.)

#### CONSTRUCTION SPECIFICATIONS

- 1. WOVEN WIRE FENCE TO BE FASTENED SECURELY TO FENCE POSTS WITH WIRE TIES OR STAPLES. POSTS SHALL BE STEEL EITHER "T" OR "U" TYPE OR HARDWOOD.
- 2. FILTER CLOTH TO BE TO BE FASTENED SECURELY TO WOVEN WIRE FENCE WITH TIES SPACED EVERY 24" AT TOP AND MID SECTION. FENCE SHALL BE WOVEN WIRE, 12 1/2 GAUGE, 6" MAXIMUM MESH OPENING.
- 3. WHEN TWO SECTIONS OF FILTER CLOTH ADJOIN EACH OTHER THEY SHALL BE OVER-LAPPED BY SIX INCHES AND FOLDED. FILTER CLOTH SHALL BE EITHER FILTER X, MIRAFI 100X, STABILINKA T140N, OR APPROVED EQUIVALENT.
- 4. PREFABRICATED UNITS SHALL BE GEOFAB, ENVIROFENCE, OR APPROVED EQUIVALENT
- 5. MAINTENANCE SHALL BE PERFORMED AS NEEDED AND MATERIAL REMOVED WHEN "BULGES" DEVELOP IN THE SILT FENCE.

# **PLAN VIEW** <0% SLOPE>

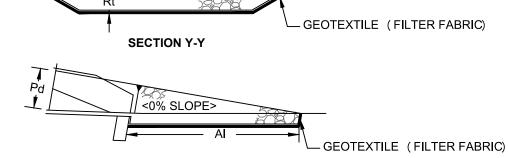

#### **SECTION Z-Z**

		RIP	RAP	APRON			
	PIPE				INITIAL	TERMINAL	
	DIA		THICK.	LENGTH	WIDTH	WIDTH	
OUTLET	Pd	SIZE	Rt	Al	Aiw	Atw	
NO.	(IN)	(R)	(IN)	(FT)	(FT)	(FT)	
1	15	4	6	12	3	10	
-	-	-	-	-	-	-	
-	-	-	-	-	-	-	

RIP RAP APRON AT PIPE OUTLET SCALE: N. T. S.

#### CONSTRUCTION SEQUENCE

#### STAGE 1 (SITE PREPARATION)

- 1. SCHEDULE ON-SITE PRE-CONSTRUCTION MEETING WITH ENGINEER, CONTRACTOR, LANDOWNER, AND TOWNSHIP AT LEAST ONE WEEK PRIOR TO THE START OF CONSTRUCTION.
- 2. INSTALL CONSTRUCTION ENTRANCE AND PERIMETER SILT FENCE.
- 3. CONSTRUCT SEDIMENT INFILTRATION BASINS AS SHOWN ON THE PLAN. EROSION CONTROLS MUST BE CONSTRUCTED, STABILIZED, AND FUNCTIONAL BEFORE NEW SITE DISTURBANCE BEGINS.
- 4. CLEAR AND GRUB SITE. STRIP TOPSOIL AND STOCKPILE AS SHOWN ON THE EROSION AND SEDIMENTATION CONTROL PLAN AND STABILIZE IN ACCORDANCE WITH THE SEEDING AND MULCHING SPECIFICATIONS.
- 5. INITIATE EARTH MOVING ACTIVITIES FOR SITE DEVELOPMENT. UNSUITABLE MATERIAL IS TO BE REMOVED FROM THE PROJECT SITE. CONTRACTOR SHALL BE SOLELY RESPONSIBLE FOR ALL EROSION AND SEDIMENTATION CONTROL MEASURE AT ANY OFF-SITE SPOIL AREAS. PLACE AND COMPACT MATERIAL IN AREAS OF FILL TO OBTAIN NECESSARY GRADES.
- 6. ROUGH GRADE SITE, STABILIZE AND SEED EXCESS STOCKPILE MATERIAL AS SHOWN ON THE EROSION AND SEDIMENTATION CONTROL PLAN SHEET. INSTALL SILT FENCE AROUND THE STOCKPILE IMMEDIATELY AFTER THE SOIL IS STOCKPILED.
- 7. THE SITE GRADING ACTIVITIES SHALL BE INITIATED AND PROCEED IN SUCH A MANNER AS TO DIRECT ALL STORM WATER FROM DISTURBED AREAS TO THE SEDIMENT CONTROL STRUCTURES.
- 8. STABILIZE ALL GRASS AREAS IN ACCORDANCE WITH THE SEEDING AND MULCHING SPECIFICATIONS.

#### STAGE 2 (CONSTRUCTION)

- 1. INITIATE CONSTRUCTION OF BUILDING FOUNDATION AND SUPER STRUCTURE.
- 2. INSTALL WASTEWATER AND WATER SUPPLY SYSTEMS INCLUDING PIPING AND TRENCHING AS SHOWN ON THE SITE PLAN.
- 3. ROUGH GRADE SITE, WORKING GRADE TOWARDS "ROUGH" FINAL GRADE ELEVATIONS OF
- 4. PLACE AND COMPACT SUBBASE IN AREAS TO BE PAVED AND PLACE THEGRAVEL / ITEM #4
- COURSE AS SOON AS IT IS PRACTICAL.

CLEAN OUT & RESEED AND RE-STABILIZE INFILTRATION BASINS WHERE NECESSARY

- 6. RESEED, RE-MULCH AND RE-STABILIZE WHERE NECESSARY.
- 7. REMOVE SILT FENCING ONLY AFTER ENTIRE SITE HAS BEEN STABILIZED, VEGETATED AREAS SHALL BE CONSIDERED PERMANENTLY STABILIZED WHEN A UNIFORM 70% VEGETATIVE COVER OF EROSION RESISTANT PERENNIAL SPECIFIED HAS BEEN ACHIEVED, OR THE DISTURBED AREA IS COVERED WITH AN ACCEPTABLE BMP WHICH PERMANENTLY MINIMIZE ACCELERATED EROSION AND SEDIMENTATION. UNTIL SUCH TIME AS THIS STANDARD IS ACHIEVED, INTERIM STABILIZATION MEASURES AND TEMPORARY EROSION AND SEDIMENT CONTROL BMPS THAT ARE USED TO TREAT PROJECT RUNOFF MAY NOT BE REMOVED. DURING PERIODS OF DROUGHT, IRRIGATION SHOULD BE UTILIZED UNTIL STABILIZATION HAS OCCURRED.

#### **SEEDING AND MULCHING SPECIFICATIONS**

TEMPORARY		
	<u>TYPE</u>	RATE
SEED	ANNUAL RYE GRASS	1 LB/1,000 SQ F
MULCH	HAY	3.0 TONS/ACRE
LIME	AGRICULTURAL GRADE LIMESTONE	1.0 TONS/ACRE
FERTILIZER	10-20-10	50 LBS./ACRE

#### PERMANENT STABILIZATION:

	TYPE	<u>RATE</u>
SEED	PERENNIAL RYE GRASS (20%) REDTOP (50%) ORCHARD GRASS (30%)	0.45 LBS/1,000 SQ FT 0.35 LBS/1,000 SQ FT 1.4 LBS/1,000 SQ FT
MULCH	HAY	3.0 TONS/ACRE
LIME	AGRICULTURAL GRADE LIMESTONE	6.0 TONS/ACRE
FERTILIZER	10-20-10	1,000 LBS./ACRE

TOWN OF CHESTER PLANNING BOARD APPROVAL

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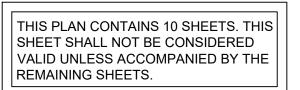



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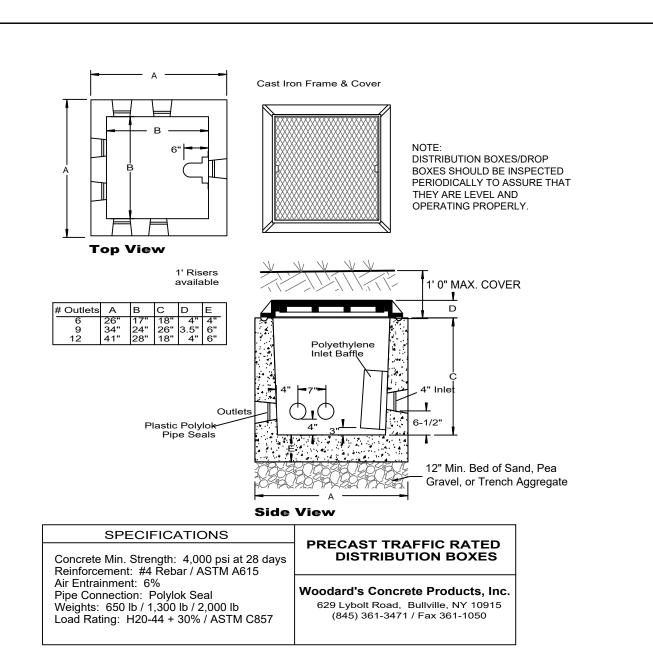
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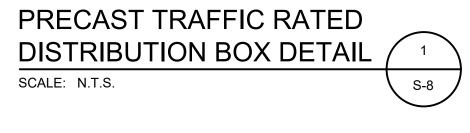
DWG TITLE EROSION & SEDIMENTATION


S-6 CONTROL PLAN DETAILS JOB NO. 1713.003 SCALE AS NOTED







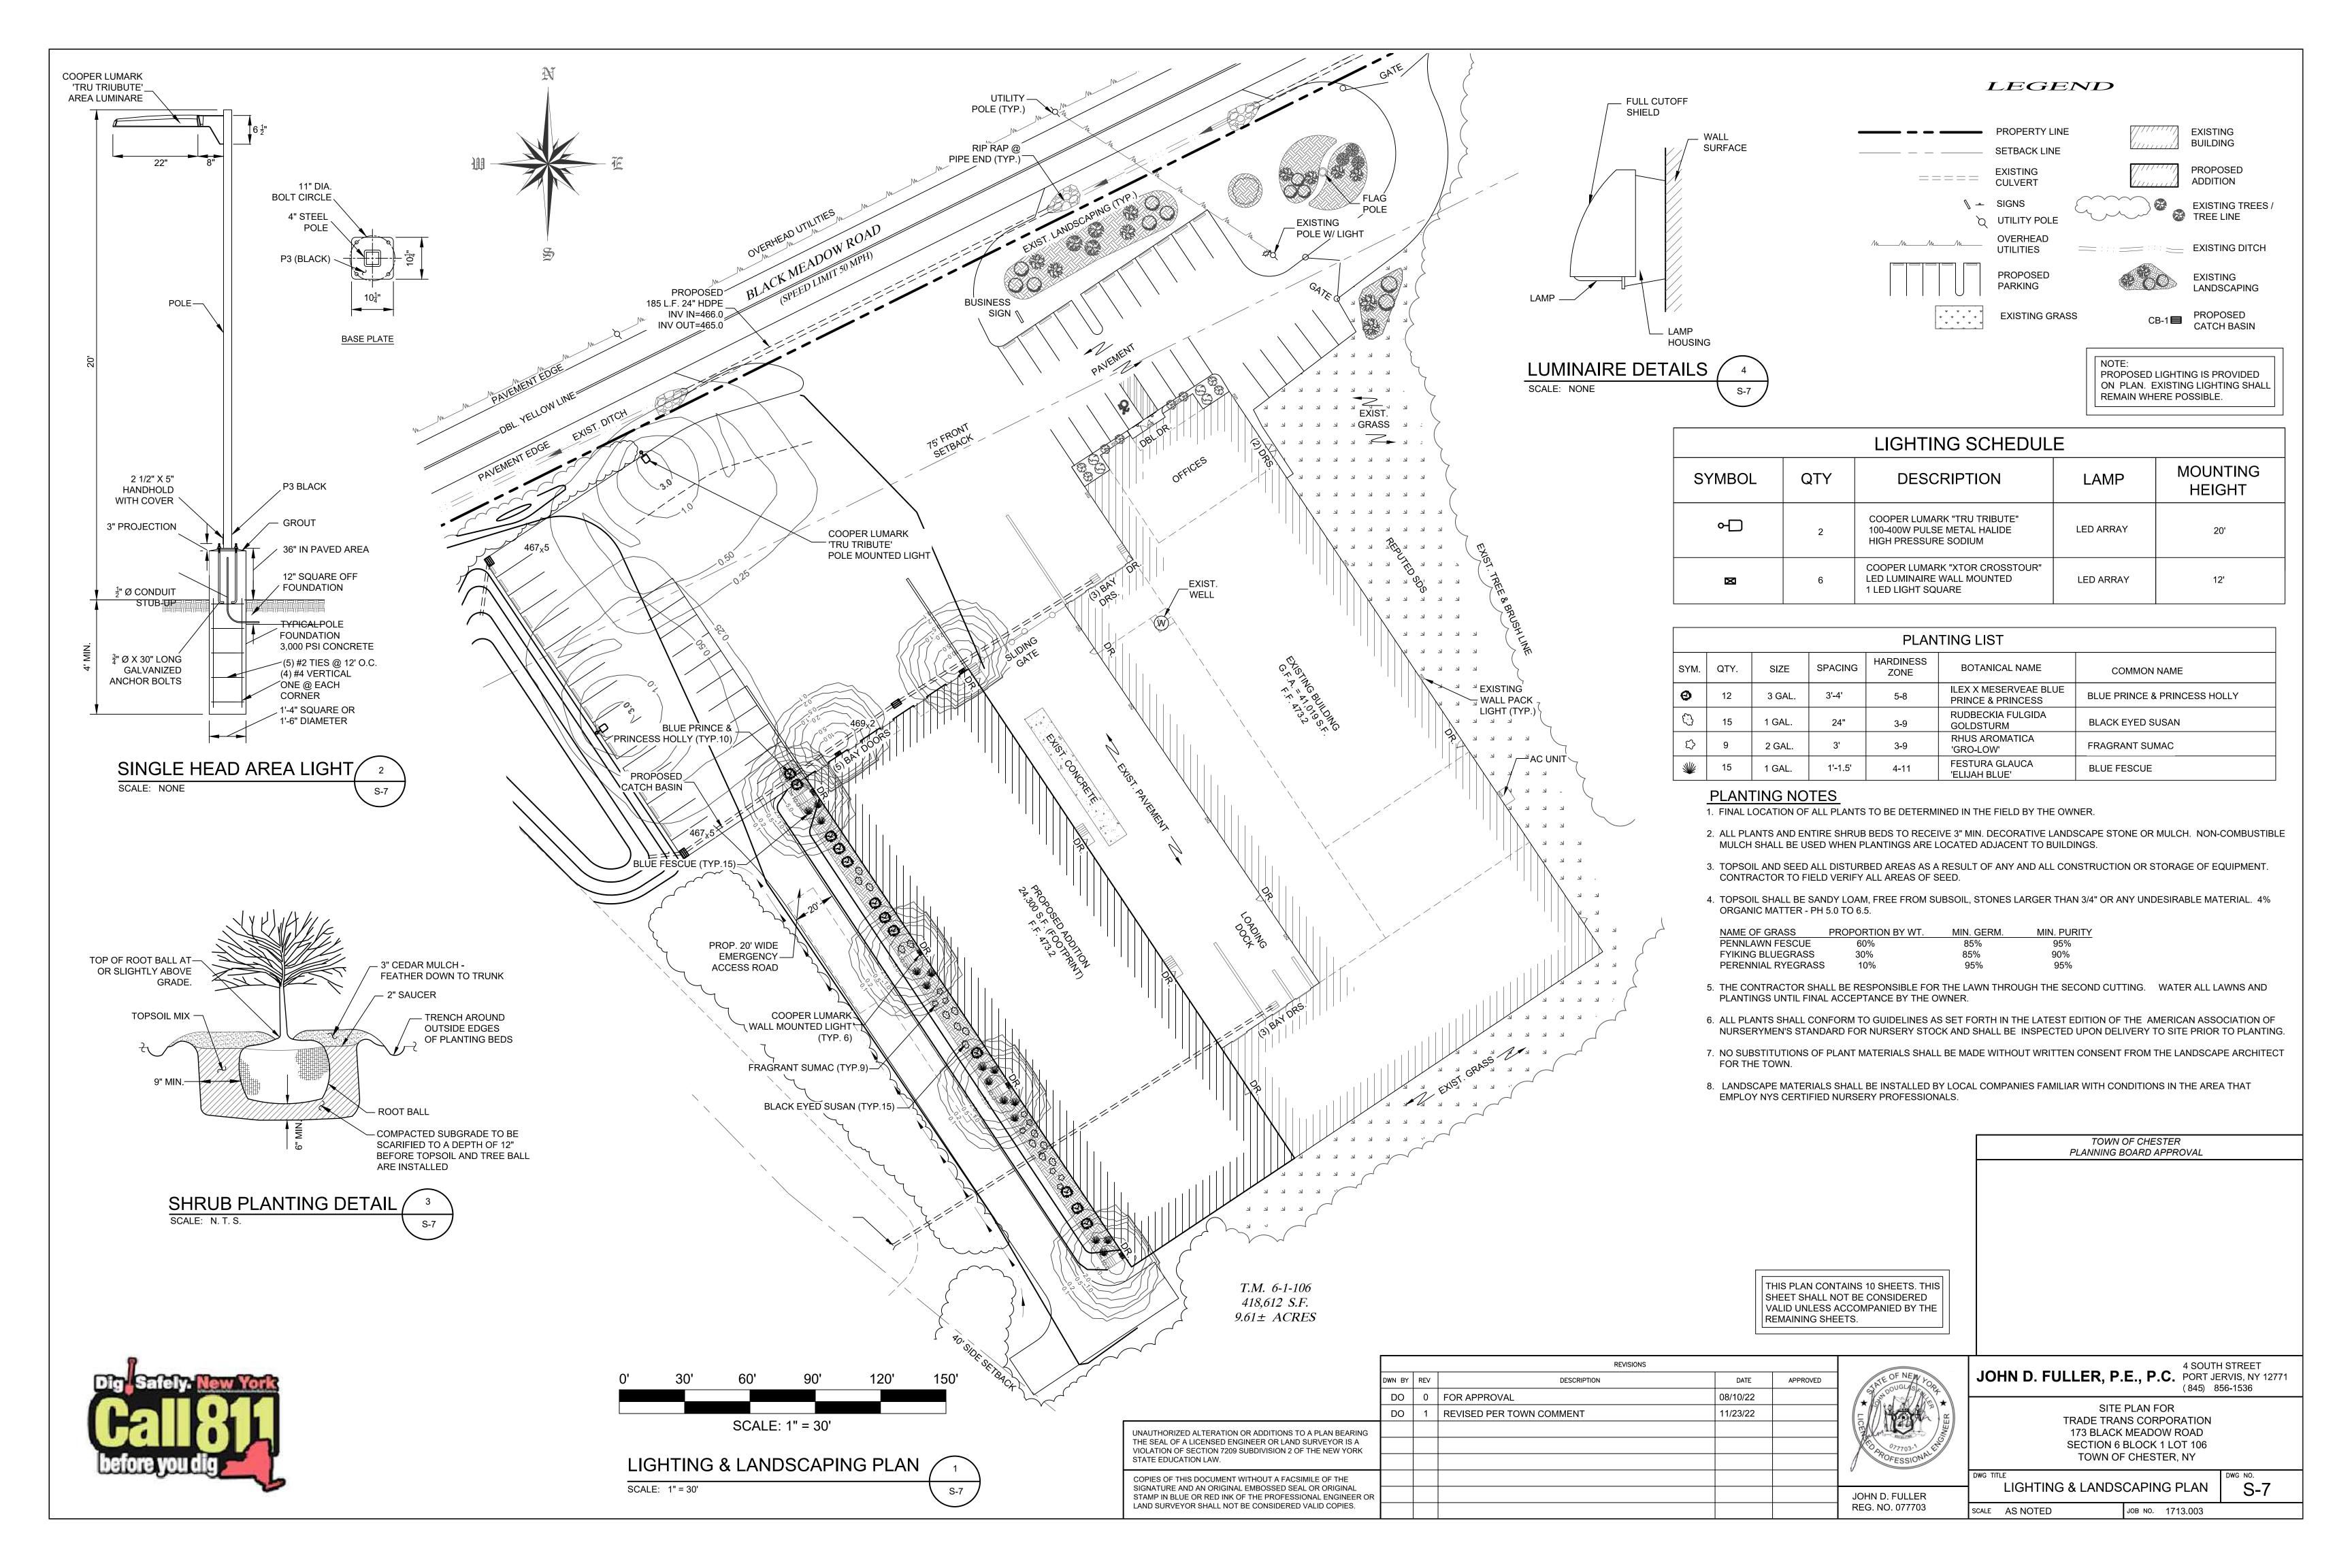

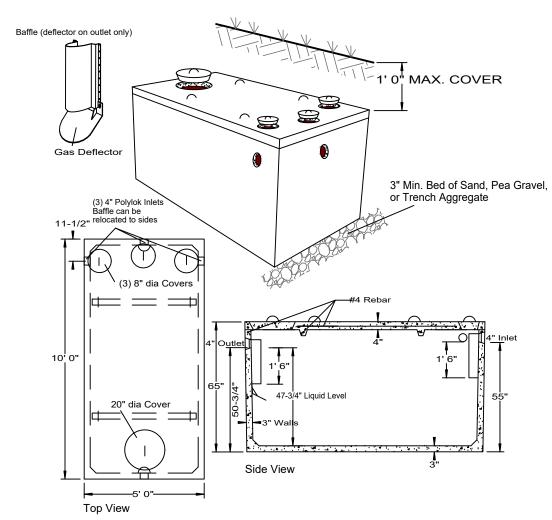


**SPECIFICATIONS** Concrete Min. Strength: 4,000 psi at 28 days MODEL ST-1250 / 1250 GALLONS Reinforcement: #4 Rebar, 6x6x10ga. WWM Air Entrainment: 5% Noodard's Concrete Products, Inc. Construction Joint: Butyl Rubber Sealant 629 Lybolt Road, Bullville, Pipe Connection: Polylok Seal (patented) NY 10915 Weight = 9,500 lbs (845) 361-3471 / Fax 361-1050 Load Rating: 300 psf


#### PRECAST CONCRETE SEPTIC TANK SCALE: N.T.S.




1. ALL LATERALS IN USE SHALL BE EQUIPPED WITH A FLOW LEVELER. 2. FLOW LEVELERS SHALL NOT COMPENSATE FOR MORE THAN 1 1/4" DIFFERENCE IN LATERAL INVERT ELEVATIONS. THE DISTRIBUTION BOX SHALL BE RELEVELED AND THE FLOW LEVELERS READJUSTED. . THE DISTRIBUTION BOX SHALL BE CHECKED 6-12 MONTHS AFTER INSTALLATION AND THE FLOW LEVELERS SHALL BE READJUSTED




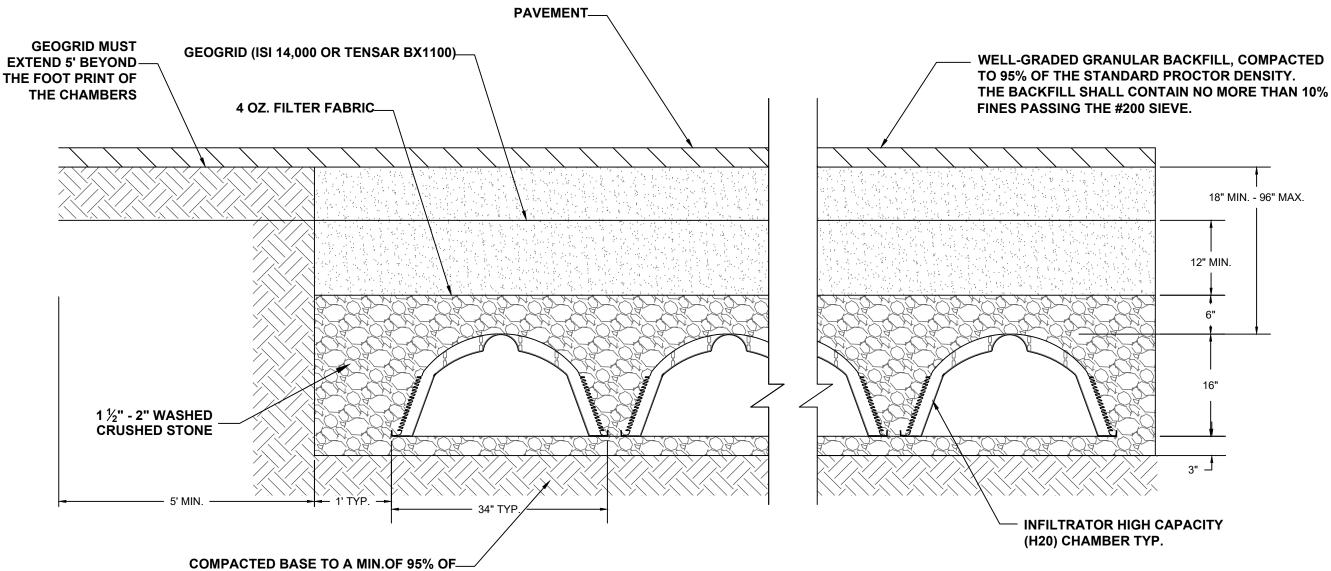

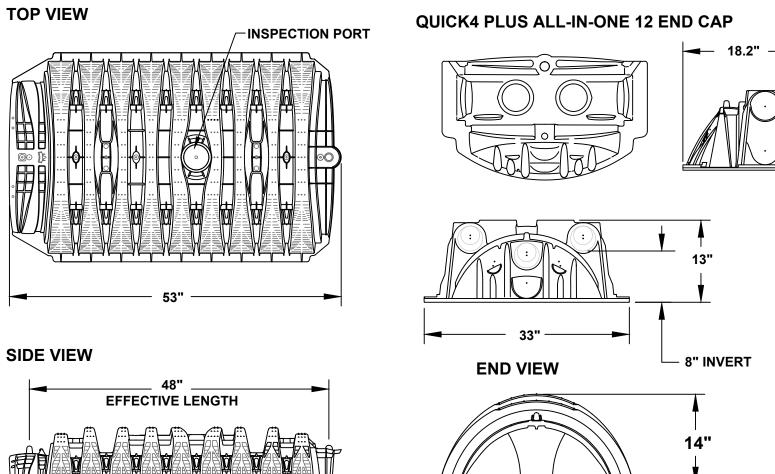


THE STANDARD PROCTOR DENSITY

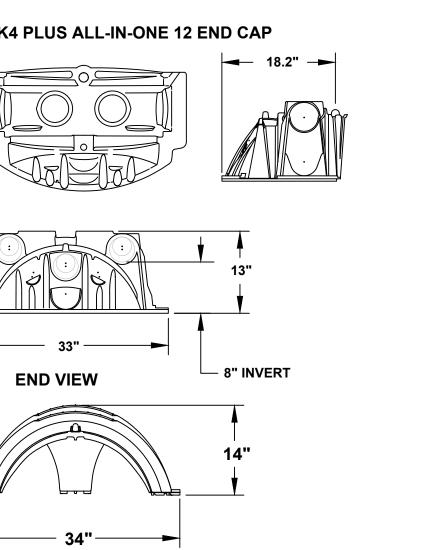

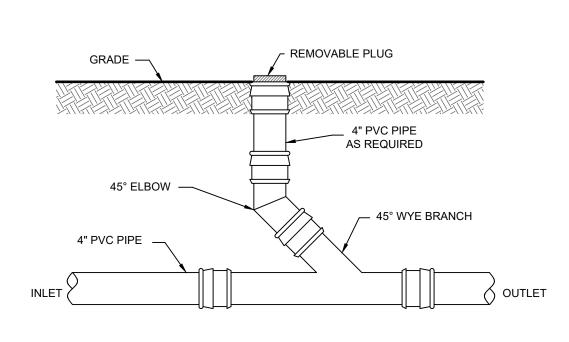



# INFILTRATOR WATER SYSTEMS HIGH CAPACITY (H20) CHAMBER TRENCH DETAIL

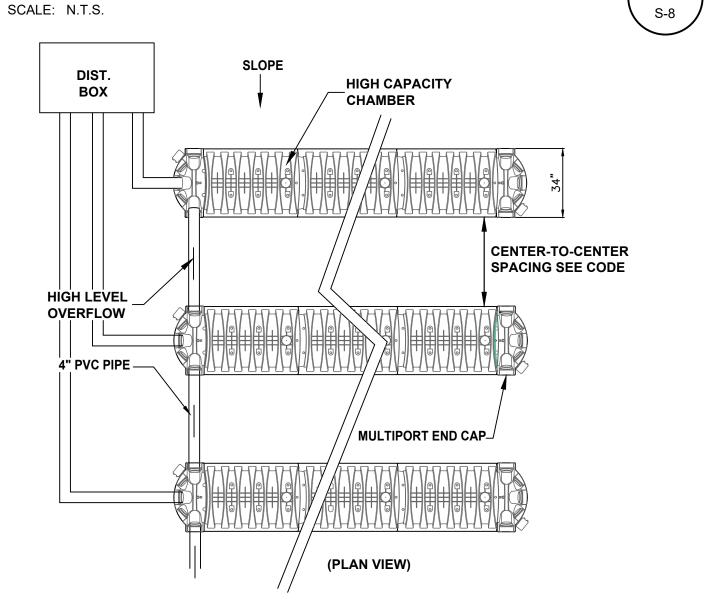

## MINIMUM SEPARATION DISTANCE (FEET) FROM

					•	•	
		TO STREAM, L			DD4114.05		
	WELL (f) OR	WATERCOUR WETLAND	,	PROPERT	DRAINAGE Y DITCH		
			D (b) DWELLING		(b) (g)		
HOUSE SEWER (WATERTIGHT JOINTS)	25' IF C.I. OR PVC W/ O-RING JOINTS, 50' OTHERWISE	25'	3'	10'			
SEPTIC TANK	50'	50'	10'	10'	10'		
EFFLUENT LINE TO DIST. BO	OX 50'	50'	10'	10'	10'		
DISTRIBUTION BOX	100'	100'	20'	10'	50'		
SEEPAGE PIT	150' (a)	100'	20'	10'	50'		
DRY WELL (ROOF AND FOO		25'	20'	10'	50'		
RAISED OR MOUND SYSTEM	· / 100 (a)	100'	20'	10'	50'		
INTERMITTEN SAND FILTER	(c) 100' (a)	100'	20'	10'	50'		
EVAPOTRANSPIRATION ABSORPTION SYSTEM (c)	100' (a)	50'	20'	10'	50'		
COMPOSTER	50'	50'	20'	10'	10'		
SANITARY PRIVY PIT	100'	50'	20'	10'	20'	SUBDIVI	
PRIVY, WATERTIGHT VAULT		50'	20'	10'	10'	BOUND	ARY
WELL		25'				50'	
ABSORPTION FIELD	100'(a)	100'	20'	10'	50'		TO INTERMITTENT
CI S ABSORPTION FIELD	ULVERT OR STORM EWER (GASKETED, TIGHT PIPE)	CURTAIN DRAIN	TOP OF EMBANKMENT STEEP SLOPE (1	OR PI	OLID CURTAIN ROOF OR FOO PES, SNOW S' EASEMEN	OTING TORAGE	STREAM, DRY WELL, CULVERT STORM SEWER (NON-GASKETED PIPE OR CATCH BASIN
(CON'T.)	35'	15'	25'	,	10'		50'

- (a) WHEN SEWAGE TREATMENT SYSTEMS ARE LOCATED IN COARSE GRAVEL OR UPGRADE AND IN THE GENERAL PATH OF DRAINAGE TO A WELL, THE CLOSEST PART OF THE TREATMENT SYSTEM SHALL BE AT LEAST 200' AWAY FROM THE WELL.
- (b) MEAN HIGH WATER MARK
- (c) FOR ALL SYSTEMS INVOLVING THE PLACEMENT OF FILL MATERIAL, SEPARATION DISTANCES ARE MEASURED FROM THE TOE OF SLOPE OF THE FILL.
- (d) ANY WATER SERVICE LINE UNDER PRESSURE (i.e., PUBLIC WATER SUPPLY MAIN, HOUSEHOLD SERVICE LINE, WELL TO HOUSEHOLD SERVICE LINE) LOCATED WITHIN TEN FEET OF ANY ABSORPTION FIELD, SEEPAGE PIT OR SANITARY PRIVY SHALL BE INSTALLED INSIDE A LARGER DIAMETER WATER MAIN TO PROTECT THE
- (e) ANY WATER SERVICE LINE UNDER PRESSURE (i.e., PUBLIC WATER SUPPLY MAIN, HOUSEHOLD SERVICE LINE, WELL TO HOUSEHOLD SERVICE LINE) CROSSING A SEWER SHALL BE INSTALLED WITH ONE FULL LENGTH OF WATER MAIN CENTERED ABOVE THE SEWER SO BOTH WATER CONNECTING JOINTS ARE AS FAR AS POSSIBLE FROM THE SEWER. SECTION 8.6 OF THE GLUMRB RECOMMENDED STANDARDS FOR WATER WORKS, SHALL
- BE FOLLOWED FOR SEPARATION OF WATER MAINS, SANITARY SEWERS AND STORM SEWERS. (f) THE MINIMUM SEPARATION DISTANCE BETWEEN A SEPTIC TANK AND A COMMUNITY TYPE PUBLIC WATER SUPPLY WELL SHOULD BE 100'. DISTRIBUTION BOXES AND ABSORPTION FACILITIES (e.g., ABSORPTION TRENCHES/BEDS, SEEPAGE PITS, RAISED SYSTEMS, MOUND SYSTEMS, ETC.) SHOULD BE LOCATED AT
- LEAST 200' FROM COMMUNITY TYPE PUBLIC WATER SUPPLY WELLS. (g) RECOMMENDED SEPARATION DISTANCES.

### MINIMUM SEPTIC TANK CAPACITIES

MINIMUM SEPTIC TANK CAPACITY = 1.5 TIMES THE DESIGN FLOW RATE 1.5 X 315 GPD = 472.5 GALLONS 1,250 GALLONS PROVIDED

#### SEPTIC CALCULATIONS

DESIGN FLOW = 21 EMPLOYEES @ 15 GPD PER EMPLOYEE = 315 GPD PERCOLATION RATE: 45-60 MIN.

TRENCH LENGTH REQUIRED = 315 GPD/0.45/2 = 350 L.F.

6 ROWS PROVIDED @ 60 = 360 L.F.

PLANNING BOARD APPROVAL

THIS PLAN CONTAINS 10 SHEETS. THIS SHEET SHALL NOT BE CONSIDERED VALID UNLESS ACCOMPANIED BY THE REMAINING SHEETS.

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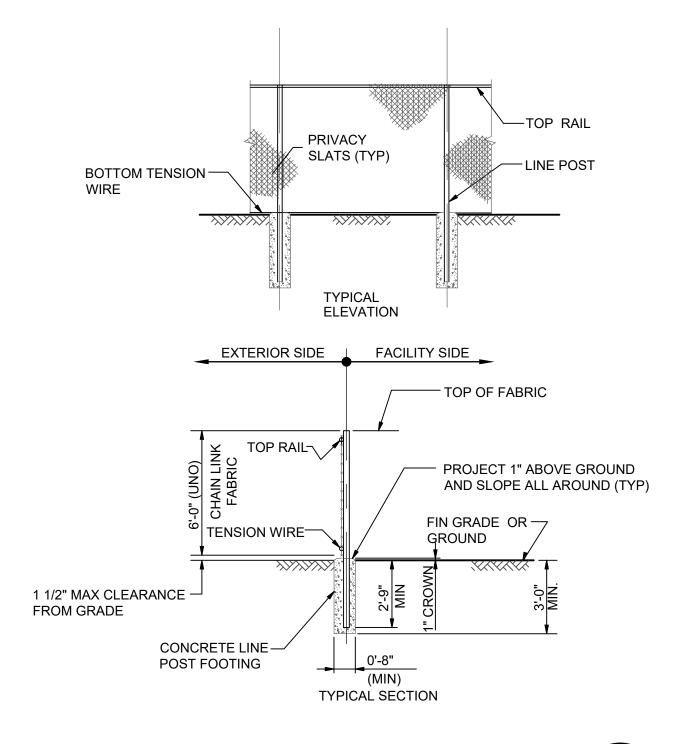
4 SOUTH STREET JOHN D. FULLER, P.E., P.C. PORT JERVIS, NY 12771

> SITE PLAN FOR TRADE TRANS CORPORATION 173 BLACK MEADOW ROAD SECTION 6 BLOCK 1 LOT 106 TOWN OF CHESTER, NY

TOWN OF CHESTER

S-8 SEPTIC DETAILS SCALE AS NOTED JOB NO. 1713.003

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COPIES OF THIS DOCUMENT WITHOUT A FACSIMILE OF THE SIGNATURE AND AN ORIGINAL EMBOSSED SEAL OR ORIGINAL STAMP IN BLUE OR RED INK OF THE PROFESSIONAL ENGINEER OR LAND SURVEYOR SHALL NOT BE CONSIDERED VALID COPIES.						JOHN D. FULLER
						REG. NO. 077703
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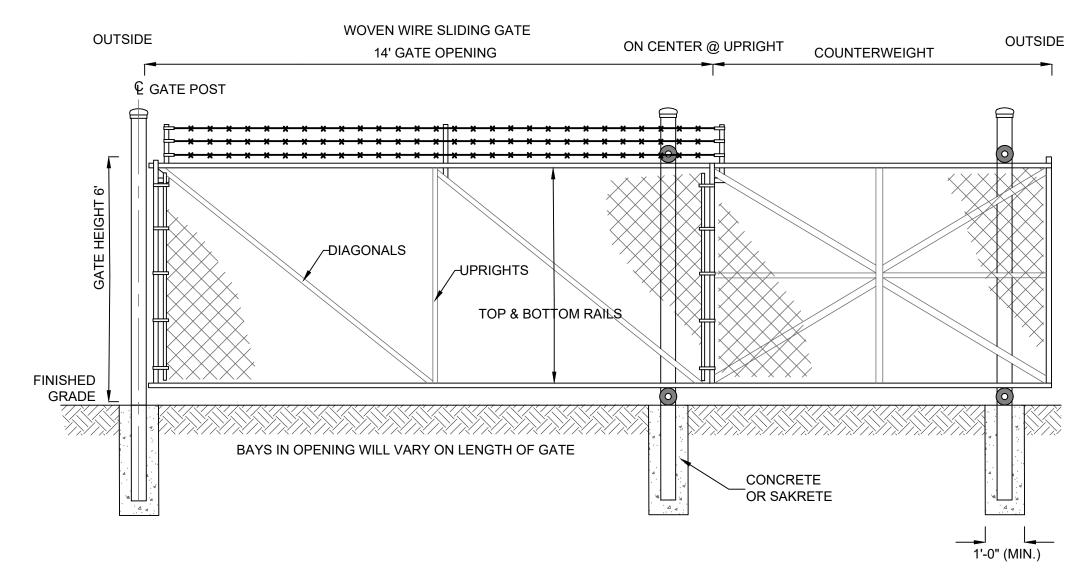





TYPICAL WOVEN WIRE FENCING NOTES

#### (INSTALL FENCING PER ASTM F-567)

- 1. LINE POST: 2-3/8"Ø SCHEDULE 40 PIPE PER ASTM-F1083. 2. TOP RAIL & BRACE RAIL: 1 1/4"Ø SCHEDULE 40 PIPE PER ASTM-F1083.
- 3. FABRIC: 11 GA. CORE WIRE SIZE 2" MESH, CONFORMING TO ASTM-A392 CLASS 1.
- 4. TIE WIRE: MINIMUM 11 GA GALVANIZED STEEL INSTALL A SINGLE
- WRAP TIE WIRE AT POSTS AND RAILS AT MAX. 24" INTERVALS. INSTALL HOG RINGS ON TENSION WIRE AT 24" INTERVALS.
- 5. TENSION WIRE: 7 GA. GALVANIZED STEEL.
- 6. HEIGHT = 4' VERTICAL.
- 7. LINE POSTS ARE 5' O.C. NOMINAL AND NOT TO EXCEED 10' 8. ALL WORK SHALL CONFORM WITH THE PROJECT SPECIFICATIONS.



CHAIN LINK SLIDING GATE DETAIL S-9

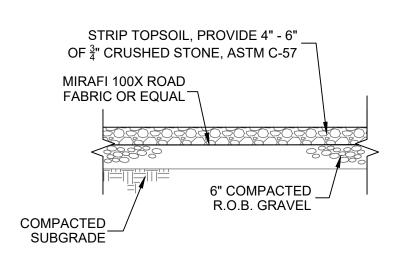

**GRAVEL PARKING DETAIL** 

TOWN OF CHESTER PLANNING BOARD APPROVAL

REVISIONS DWN BY REV DESCRIPTION DATE APPROVED DO 0 FOR APPROVAL 08/10/22 DO 1 REVISED PER TOWN COMMENT 11/23/22 UNAUTHORIZED ALTERATION OR ADDITIONS TO A PLAN BEARING THE SEAL OF A LICENSED ENGINEER OR LAND SURVEYOR IS A VIOLATION OF SECTION 7209 SUBDIVISION 2 OF THE NEW YORK STATE EDUCATION LAW. COPIES OF THIS DOCUMENT WITHOUT A FACSIMILE OF THE SIGNATURE AND AN ORIGINAL EMBOSSED SEAL OR ORIGINAL JOHN D. FULLER STAMP IN BLUE OR RED INK OF THE PROFESSIONAL ENGINEER OR LAND SURVEYOR SHALL NOT BE CONSIDERED VALID COPIES. REG. NO. 077703

JOHN D. FULLER, P.E., P.C. PORT JERVIS, NY 12771 SITE PLAN FOR

TRADE TRANS CORPORATION 173 BLACK MEADOW ROAD SECTION 6 BLOCK 1 LOT 106 TOWN OF CHESTER, NY

4 SOUTH STREET

(845) 856-1536

CONSTRUCTION DETAILS S-9 SCALE AS NOTED JOB NO. 1713.003

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