





SIDE VIEW
VIEW1
SCALE 1 : 12

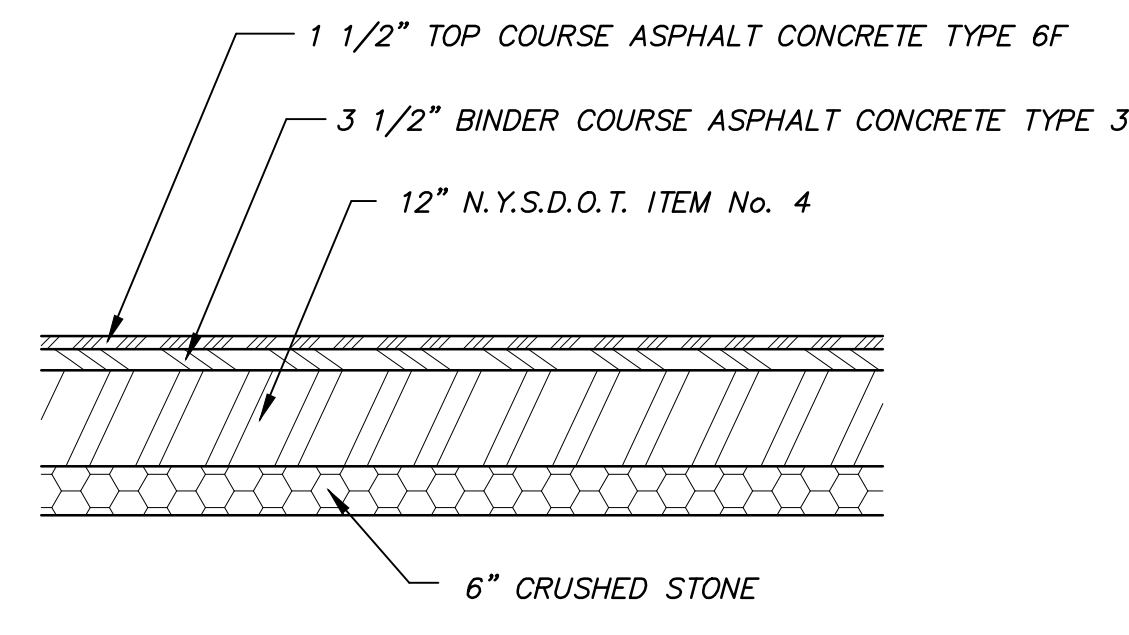

**MAIN ENTRANCE
CROSS SECTION DETAIL**
SCALE : NONE

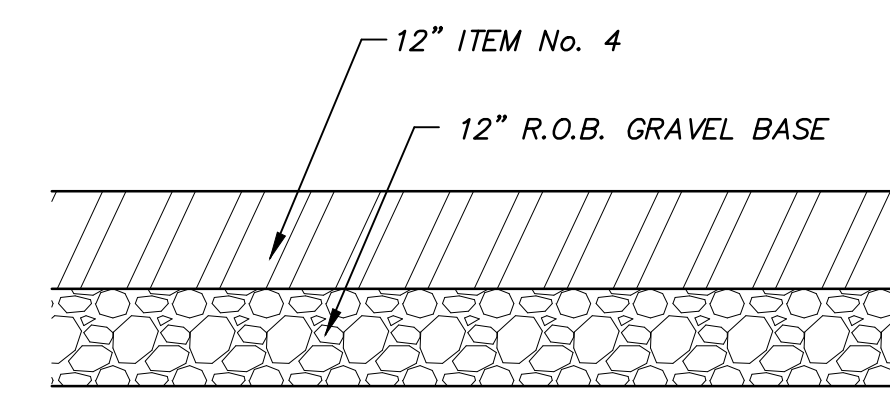


**DRIVEWAY AND GRAVEL ROAD
CROSS SECTION DETAIL**
SCALE : NONE

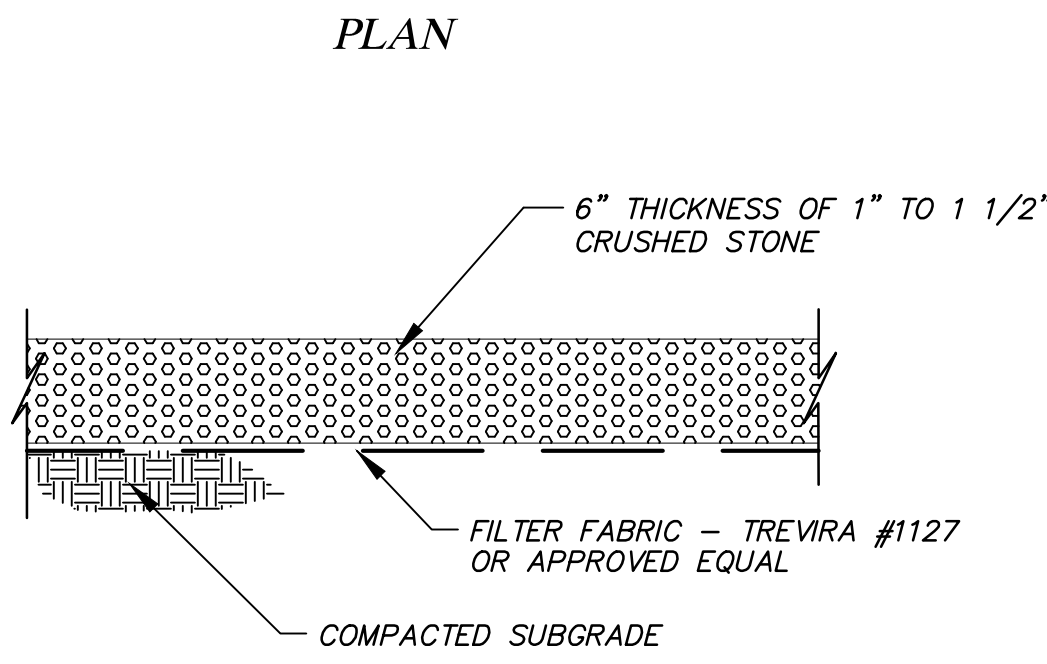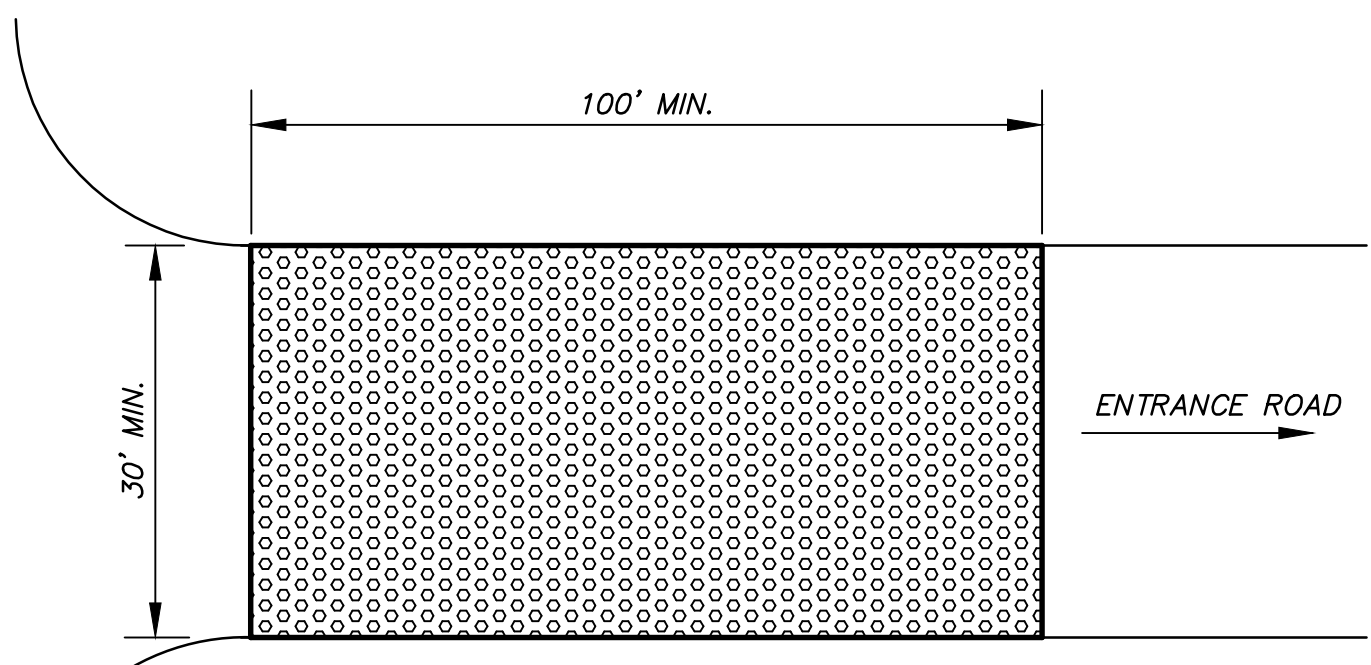

SECTION


- NOTE:**
- ENTRANCE SHALL BE MAINTAINED AS CONDITIONS DEMAND TO PREVENT TRACKING OF SEDIMENT ONTO PUBLIC RIGHTS OF WAY.
 - ALL SEDIMENTATION STRUCTURES WILL BE INSPECTED AND MAINTAINED ON A REGULAR BASIS.
 - A CRUSHED STONE, VEHICLE WHEEL-CLEANING BLANKET WILL BE INSTALLED WHENEVER A CONSTRUCTION ACCESS ROAD INTERSECTS AND PAVED ROADWAY. SAID BLANKET WILL BE COMPOSED OF 6\"/>
 - ALL DRIVEWAYS MUST BE STABILIZED WITH 1\"/>
 - PAVED ROADWAYS MUST BE KEPT CLEAN AT ALL TIMES.
 - ALL CATCH BASIN INLETS WILL BE PROTECTED WITH A CRUSHED STONE OR HAYBALES FILTER (FILTER DETAILS APPEAR ON PLAN).
 - ALL STORM DRAINAGE OUTLETS WILL BE STABILIZED, AS REQUIRED, BEFORE DISCHARGE POINTS BECOME OPERATIONAL.
 - ALL SOIL EROSION AND SEDIMENT CONTROL STRUCTURES MUST BE DETAILED ON THE PLAN.

**STABILIZED
CONSTRUCTION ENTRANCE DETAIL**
NOT TO SCALE

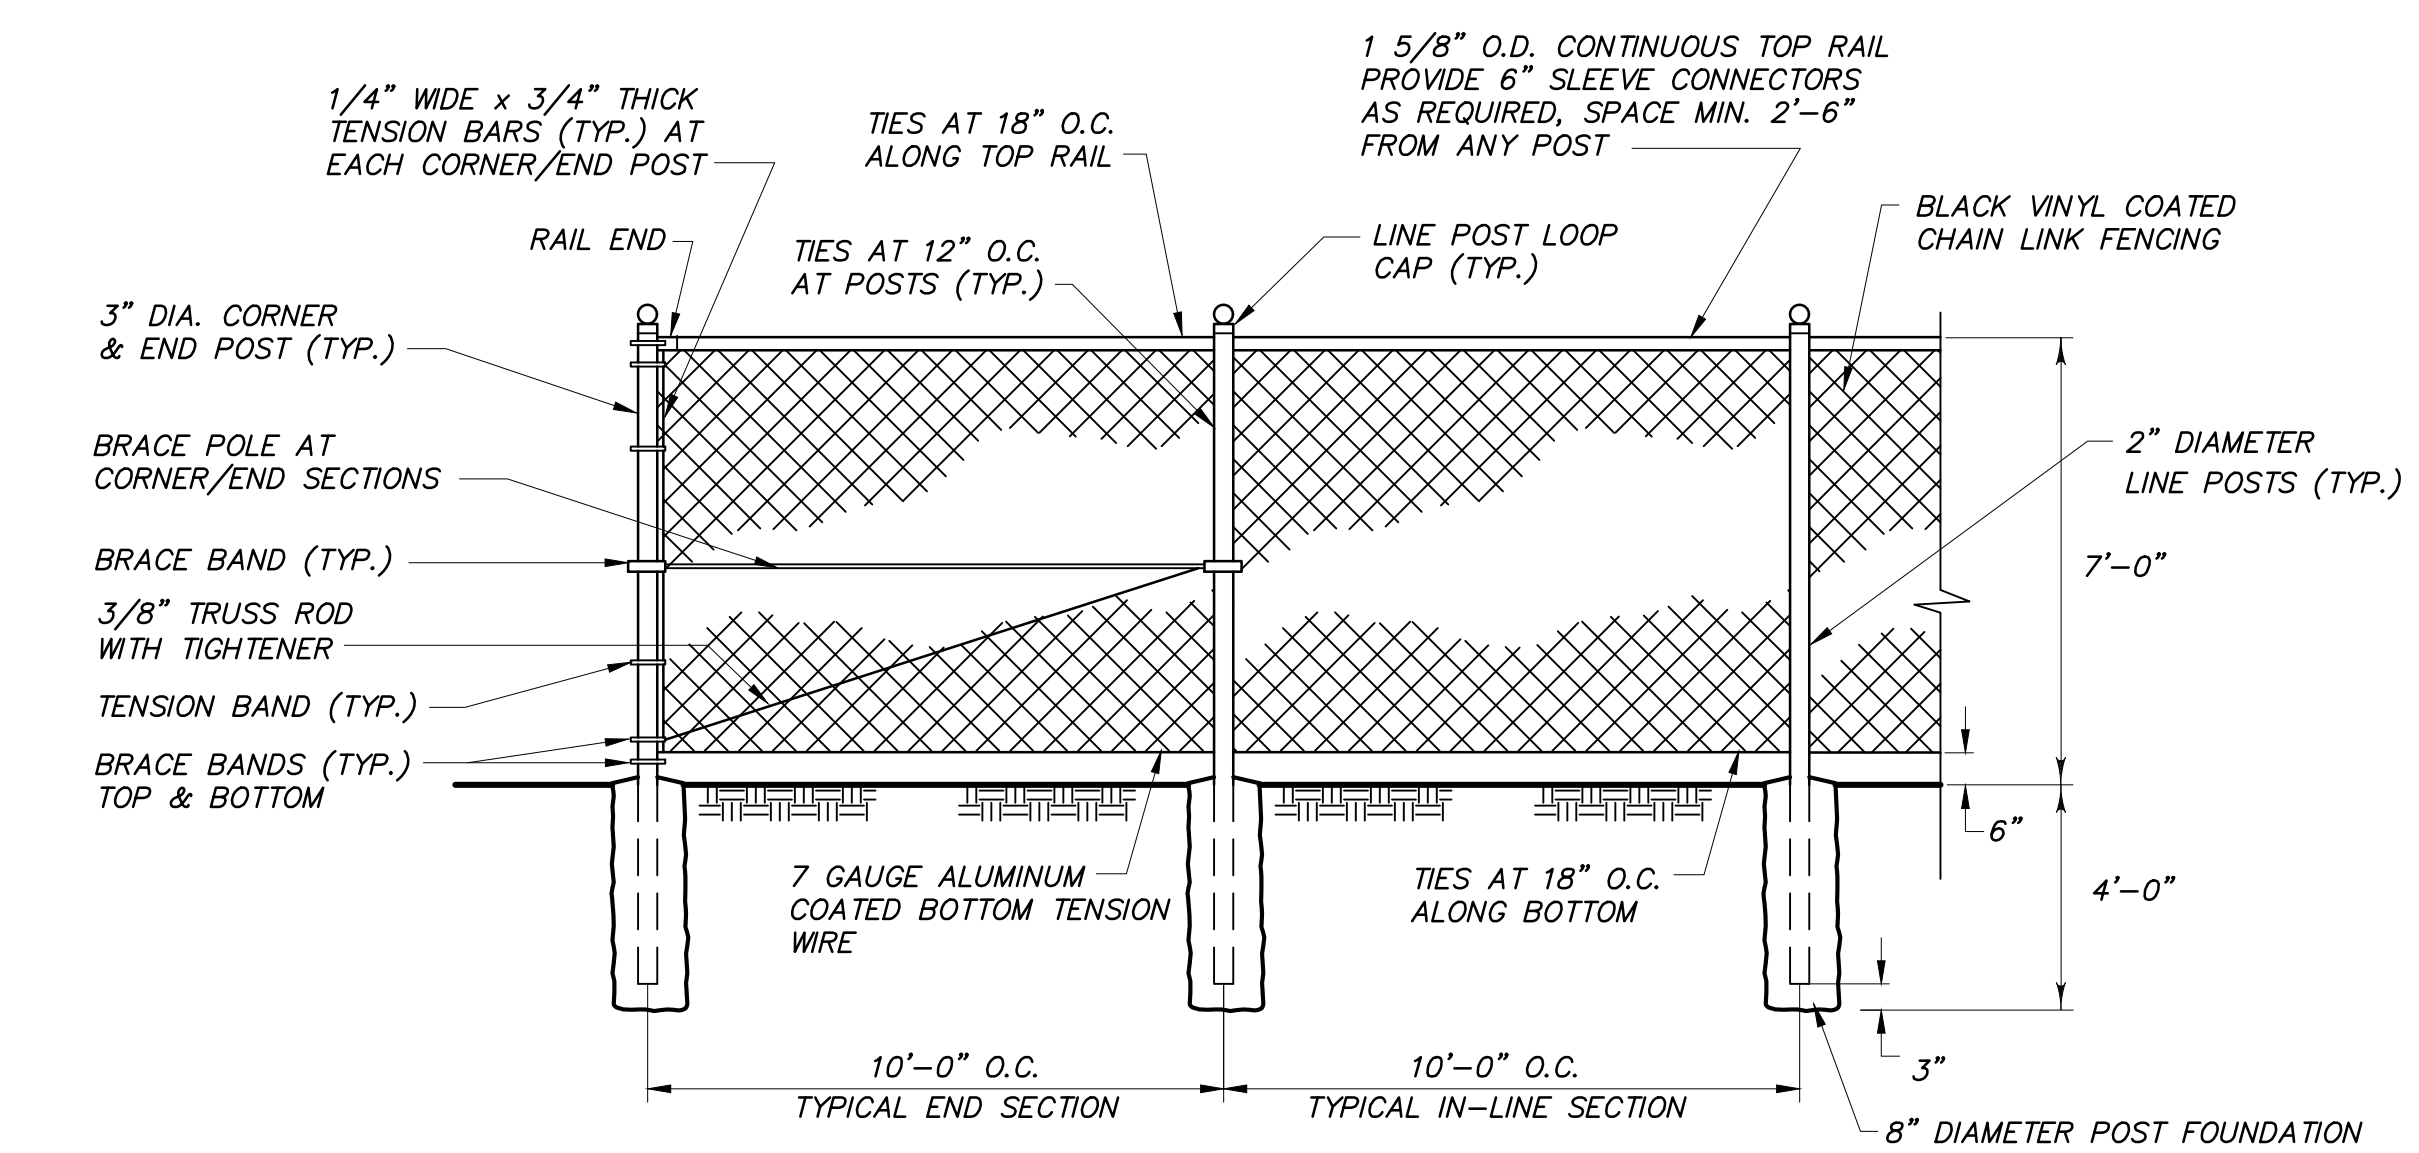


- NOTES:**
- ALL POSTS, RAILS, HARDWARE AND COMPONENTS TO BE GALVANIZED STEEL.
 - ALL TIES TO BE 9 GAGE.
 - INSTALL GRACE ROLL ASSEMBLIES IN EACH DIRECTION FROM CORNER POSTS AND AT ALL END POSTS.
 - BRACE/TENSION BANDS TO BE 1/8\"/>
 - FENCE SHALL BE BLACK EPOXY COATED.

CHAIN LINK FENCE DETAIL
NOT TO SCALE

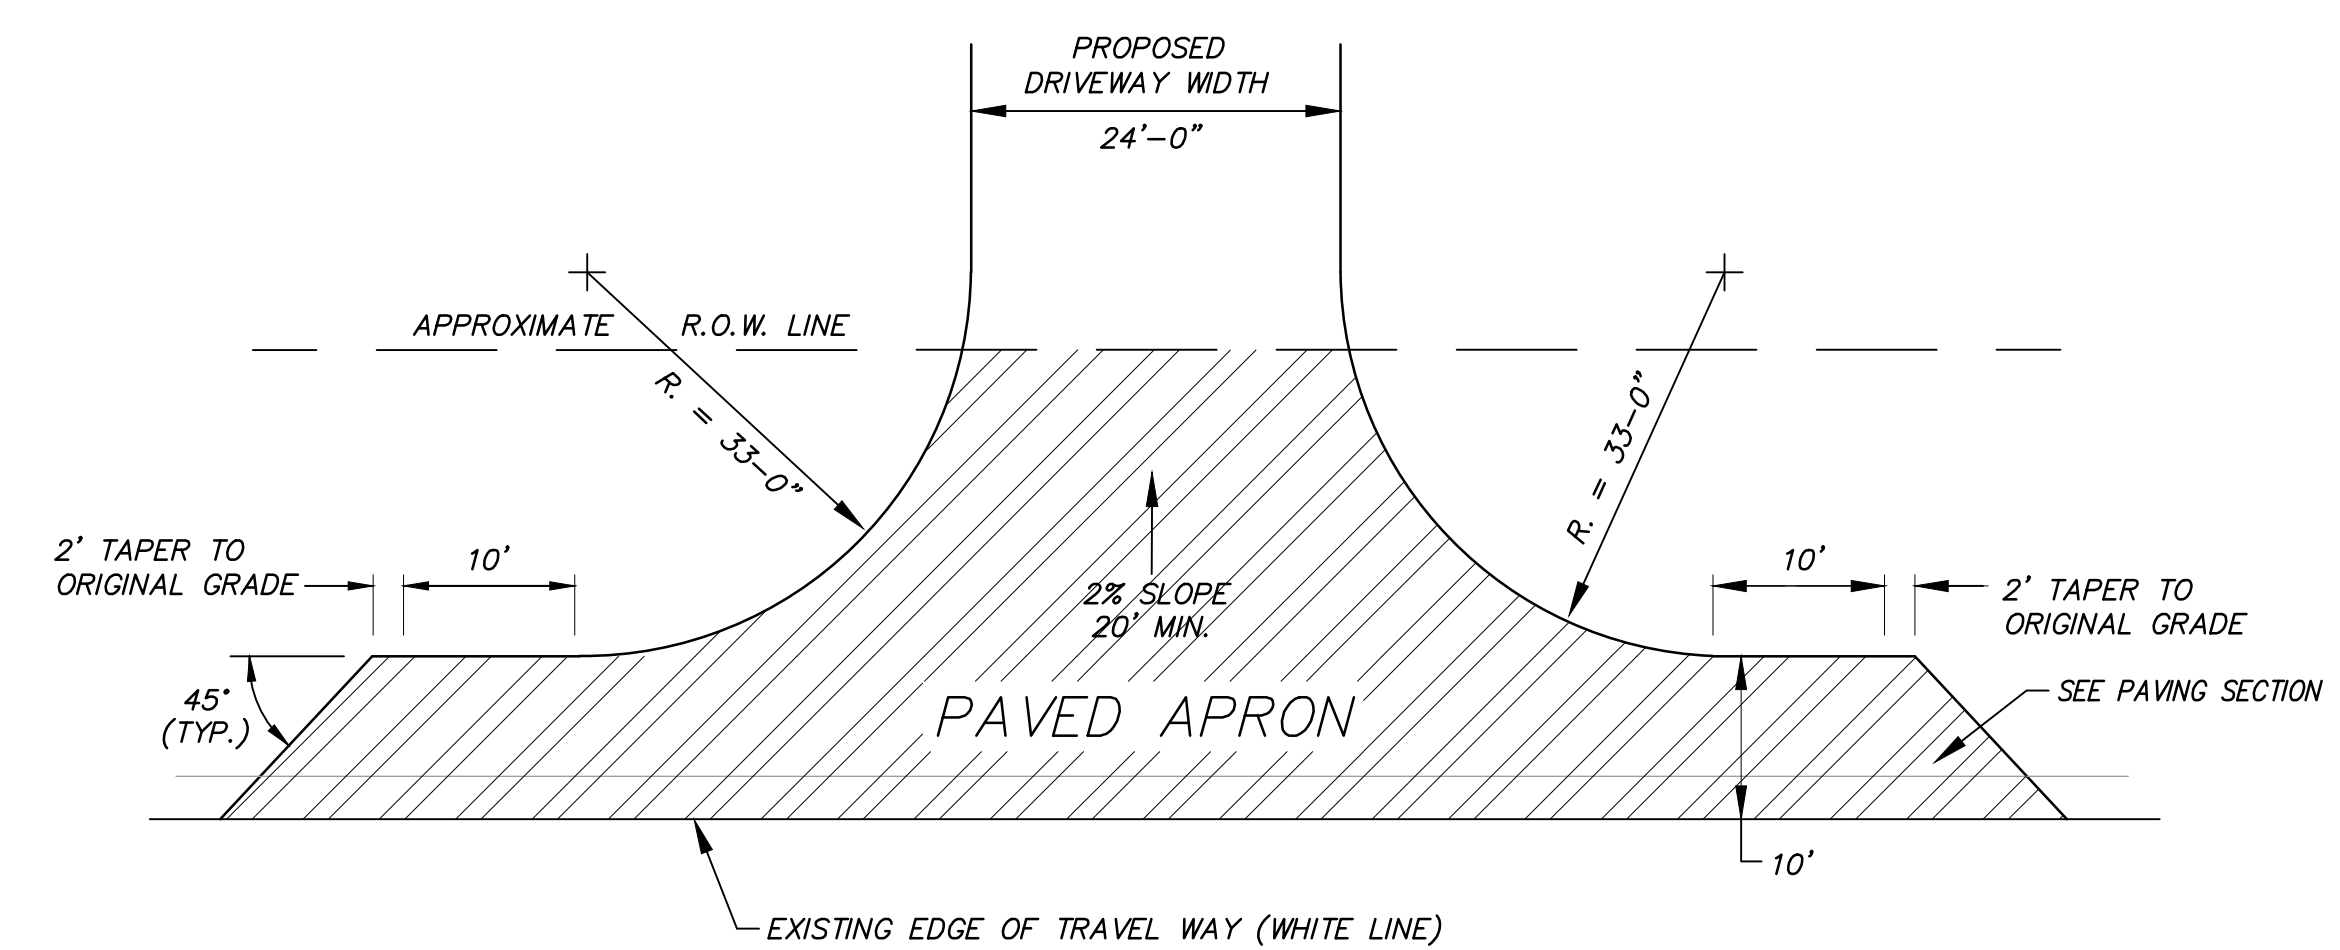


TYPICAL COMMERCIAL DRIVEWAY DETAIL
NOT TO SCALE

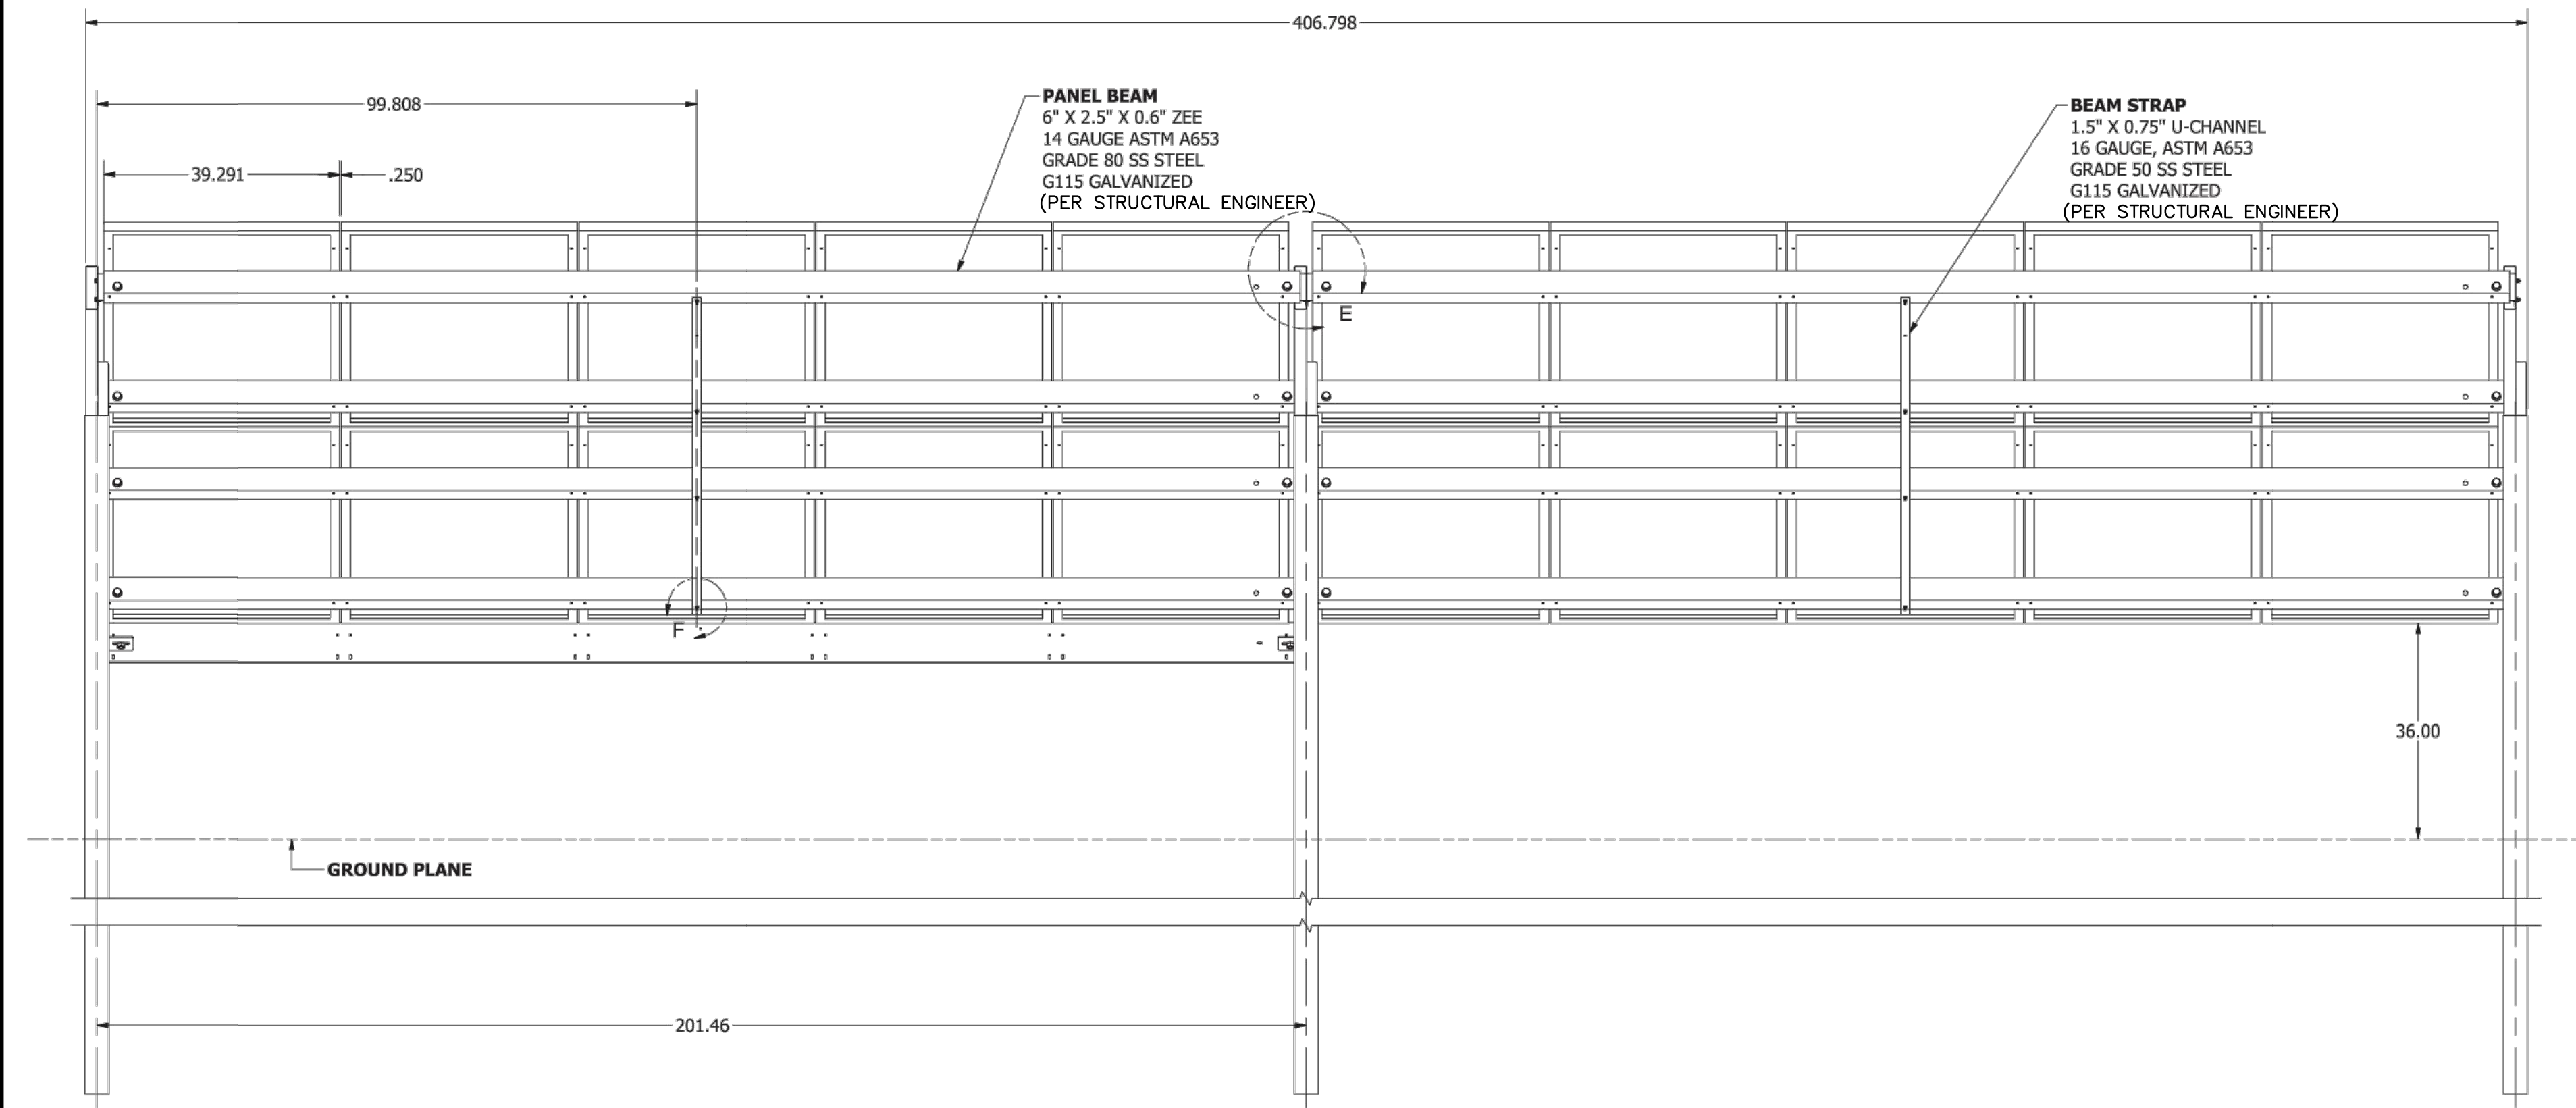


REAR VIEW
VIEW3
SCALE 1 / 18

NOTE: UNIT SHOWN IS ILLUSTRATIVE. FINAL INSTALLATION OF THIS UNIT OR APPROVED EQUAL NOT TO EXCEED 12' IN HEIGHT.

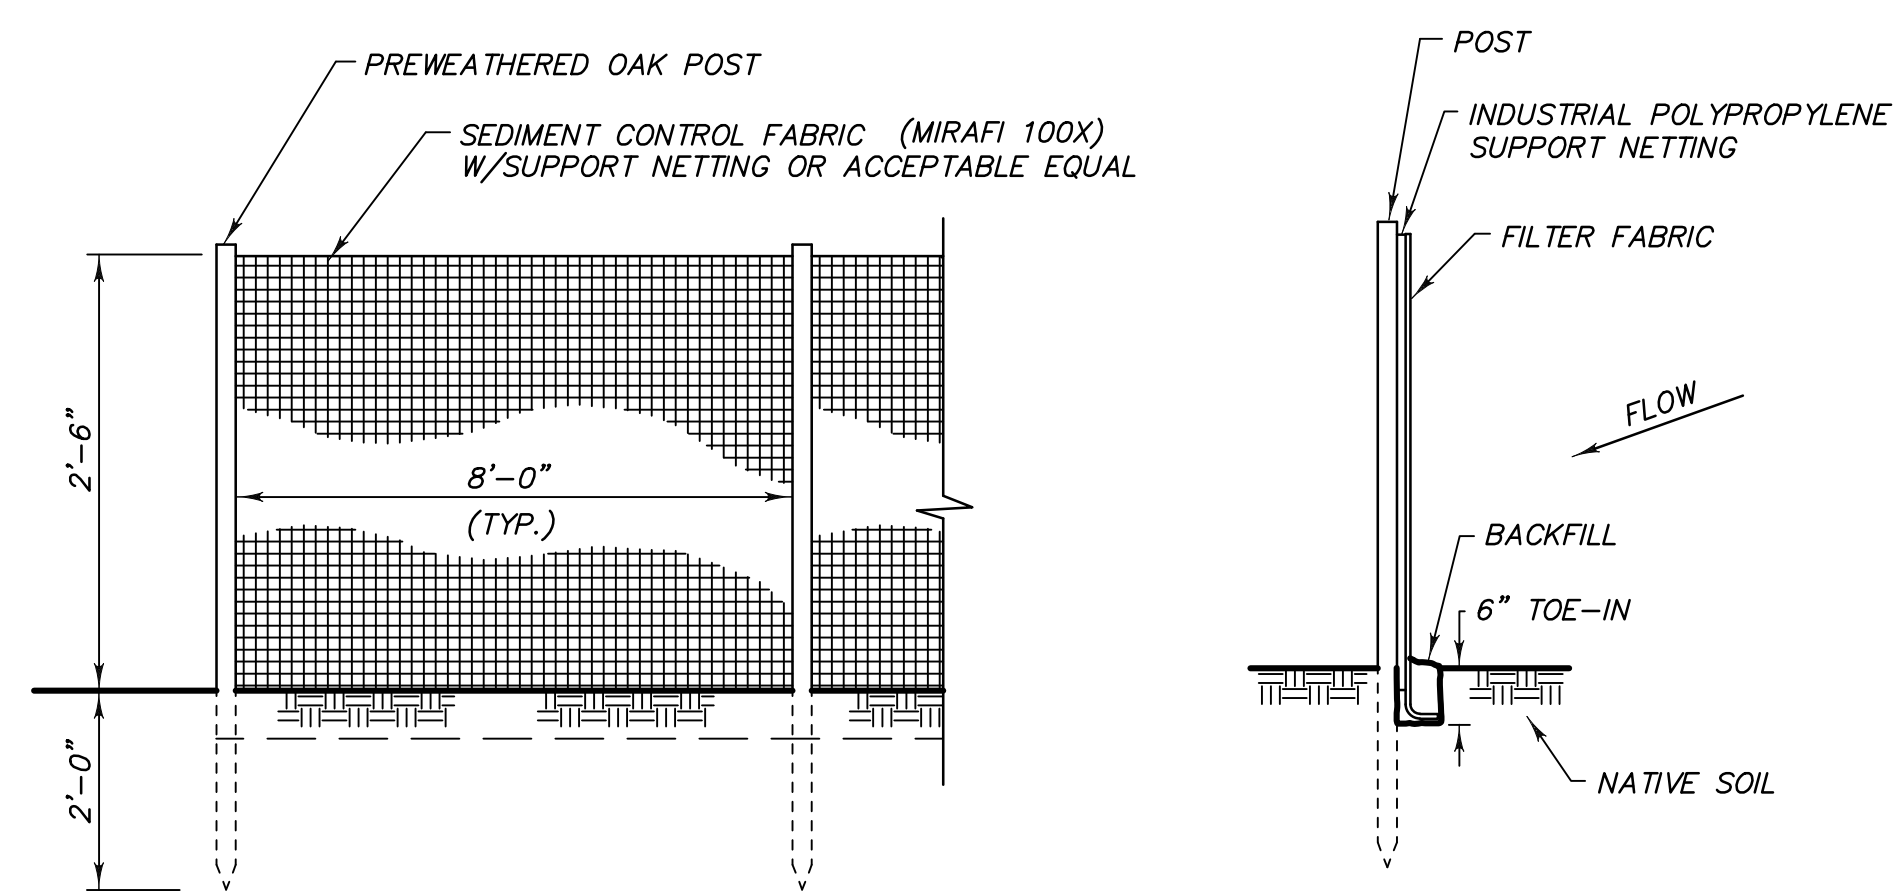

- CONSTRUCTION NOTES FOR FABRICATED SILT FENCE**
- SILT FENCE TO BE FASTENED SECURELY TO FENCE POSTS WITH PLASTIC TIES OR STAPLES.
 - FILTER CLOTH TO BE FASTENED SECURELY TO WOVEN WIRE FENCE WITH AS PER MANUFACTURERS SPECIFICATIONS.
 - WHEN TWO SECTIONS OF FILTER CLOTH ADJOIN EACH OTHER THEY SHALL BE BOUND TOGETHER WITH TWO POSTS AND FABRIC OVERLAPPED TO PREVENT FLOW-THROUGH.
 - MAINTENANCE SHALL BE PERFORMED AS NEEDED AND MATERIAL REMOVED WHEN "BULGES" DEVELOP IN THE SILT FENCE.
- POSTS: 1 1/4\"/>

**SILT FENCE
EROSION CONTROL BARRIER**
NOT TO SCALE

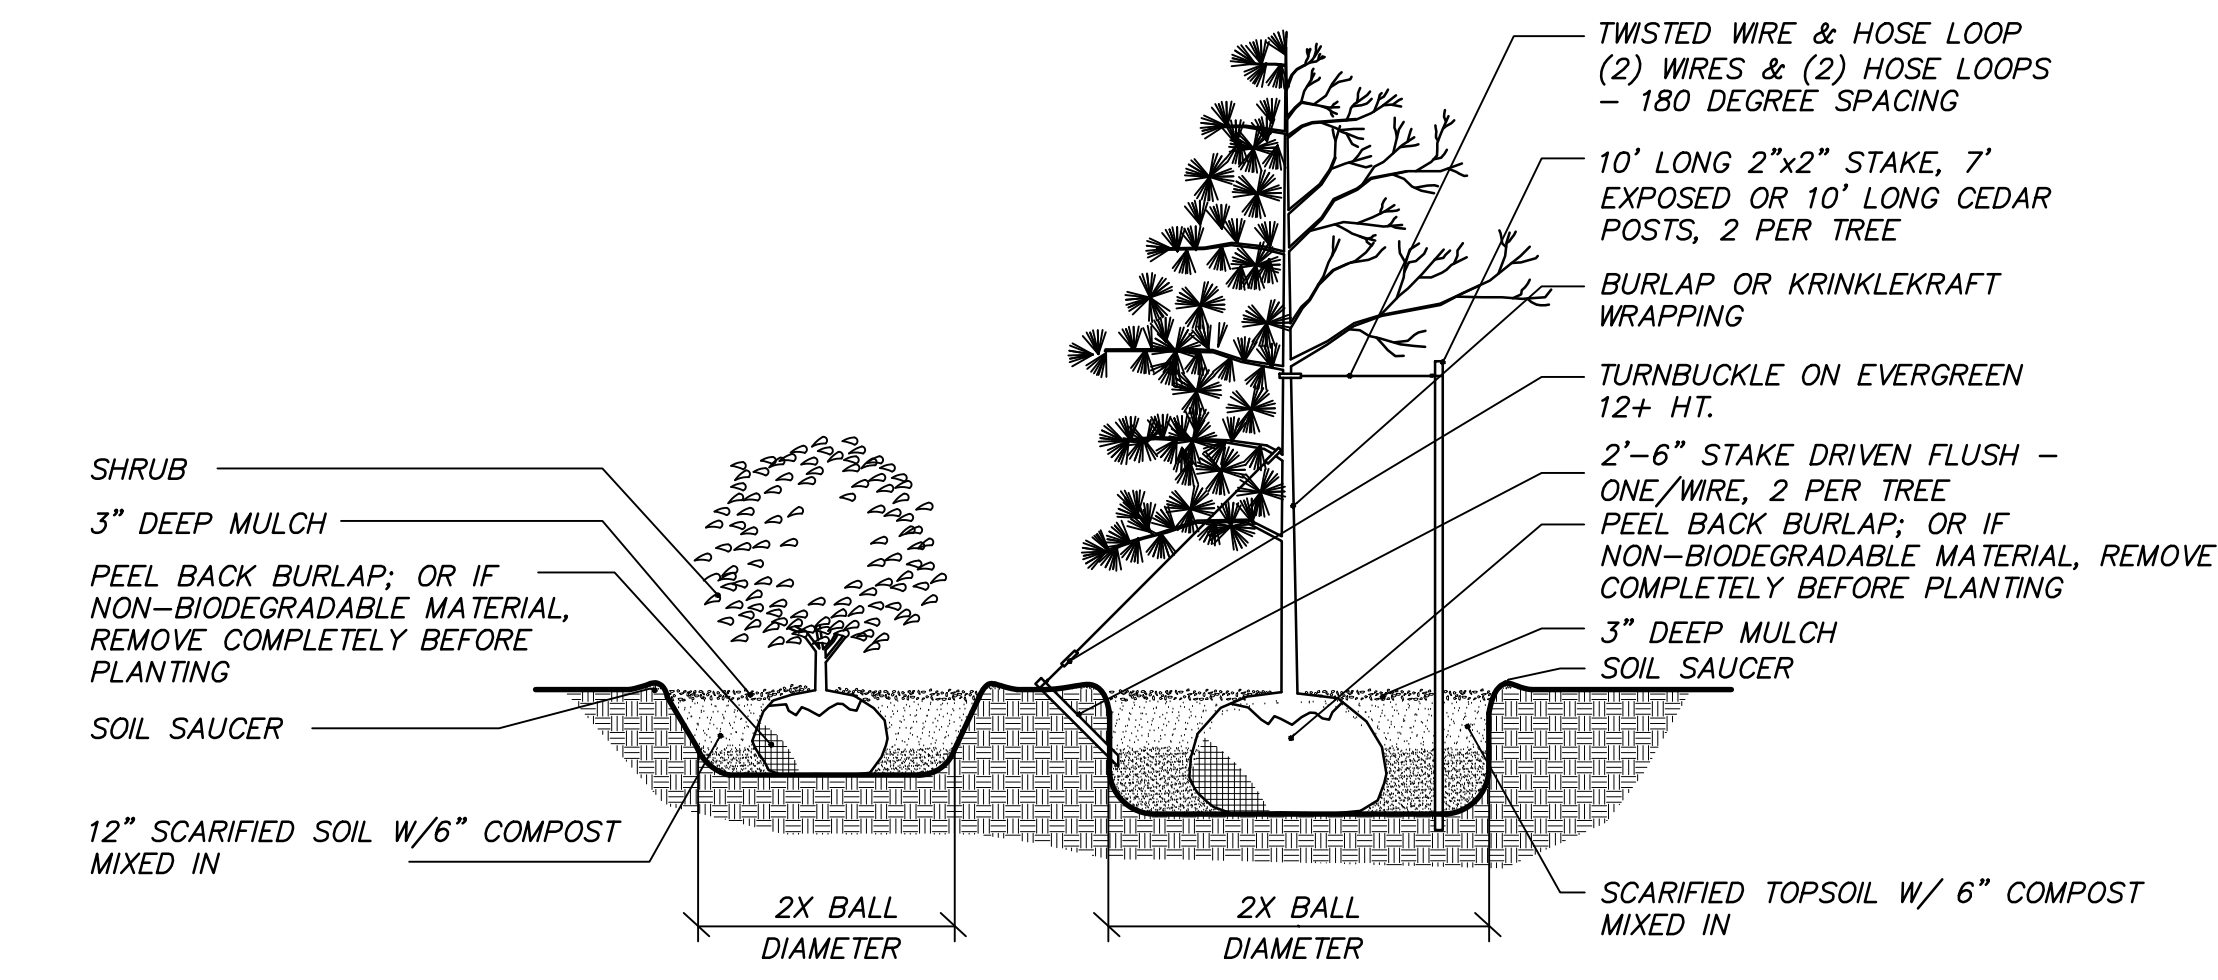


PLANTING DETAIL
SCALE: NONE

SEEDING REQUIREMENTS

- LIME AND FERTILIZER SHALL BE APPLIED AT A RATE IN ACCORDANCE WITH THE SEEDING RECOMMENDATIONS BELOW AND THE SOIL TEST RESULTS ACCORDING TO THE NEW YORK STATE COOPERATIVE EXTENSION ANNUAL PUBLICATION: "CORNELL RECOMMENDS FOR FIELD CROPS."
- AREAS TO BE RECLAIMED SHALL BE SEEDED FOR STABILIZATION AT THE RATE OF 0.8 LB/1,000 S.F. OF ASCS SOIL CONSERVATION SEED MIXTURE, AND 2 LB/1,000 S.F. OF GRASS RYE. FOLLOWING STABILIZATION, THE SEEDING REQUIREMENTS SHOWN ON THE APPROVED PLANS SHALL BE ADHERED TO.
- HAY OR STRAW MULCH SHALL BE APPLIED AT THE RATE OF 100 LB/1,000 S.F. HYDROSEEDING MAY BE USED TO CONSOLIDATE STEPS A THROUGH C DEPENDING ON THE RECOMMENDED FERTILIZATION RATES.
- NORTH AMERICAN GREEN SC 150 EROSION CONTROL BLANKET TO BE PLACED ON SWALES AND DETENTION OUTLETS AND STAPLED DOWN ACCORDING TO THE MANUFACTURER'S RECOMMENDATIONS.
- SILT FENCING AND HAY BALE CHECK DAMS WILL BE INSTALLED AS SHOWN ON EROSION CONTROL PLANS AND SHALL REMAIN UNTIL VEGETATION IS FULLY ESTABLISHED.
- FOLLOWING FINAL SEEDED PREPARATION GRASSES SHALL BE SEEDED WITH 1.5 LB/1,000 S.F. OF THE FOLLOWING MIXTURE:
 - PERENNIAL RYEGRASS
 - RED TOP WHITE CLOVER
 - BIRDFOOT TREFOIL

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LIVINGSTON MANOR, NEW YORK 12758

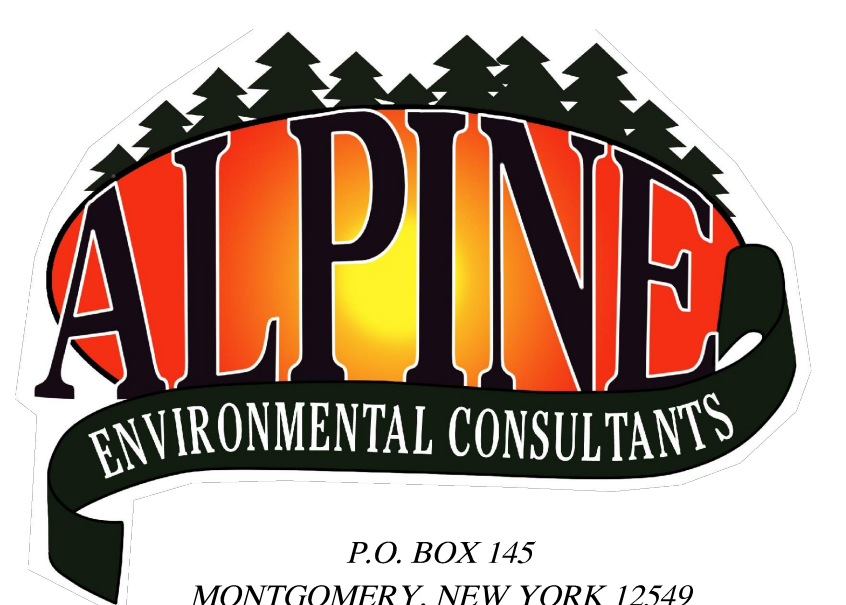

Miscellaneous Details

TOWN OF CHESTER		ORANGE COUNTY, NEW YORK	
DATE	SCALE	JOB NUMBER	SHEET NUMBER
12/05/17	1 = 100'	1655	2