


AREAS SHOWN ON THE PLAN AND SPECIFIED BELOW ARE TO RECEIVE A 3" LAYER OF BARK MULCH. BARK MULCH AREAS INCLUDE ALL PLANTING BEDS, SHADE TREES AND ALL OTHER AREAS AS SHOWN ON THE PLAN. THE MULCH AREAS SHALL BE UNDERLAIN WITH A POLYETHYLENE OR FABRIC WEED BARRIER.

ONLY HARDWOOD BARK MULCH SHALL BE USED AND SHALL NOT CONTAIN LEAVES, TWIGS, BRANCHES, WOOD SHAVINGS, DIRT, STONES, CODS OF TURF OR OTHER FOREIGN MATERIAL OR DEBRIS. BARK MULCH SHALL NOT EXCEED 2" IN ANY

POLYETHYLENE OR FABRIC WEED BARRIER SHALL BE A PRODUCT DESIGNED FOR THIS PURPOSE AND SHALL BE BLACK IN COLOR.


WHEN THE 3" BARK MULCH LAYER IS SPREAD, THE SURFACE OF THE MULCH WILL BE FLUSH WITH ADJACENT AREAS. PROVIDE A SAUCER RIM AS PER DETAILS. IF, PRIOR TO FINAL ACCEPTANCE OF THE PROJECT, ANY BARK MULCH HAS BEEN DISPLACED, THE DISPLACED AREAS WILL BE RESTORED IN ACCORDANCE WITH THE PLANS AND SPECIFICATIONS, AT NO ADDITIONAL COST TO THE OWNER. LANDSCAPING DETAILS

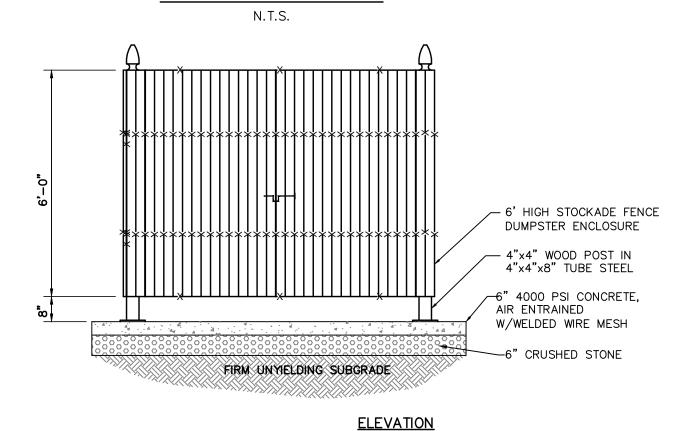

13'-0"

12'-0"

<u>PLAN</u>

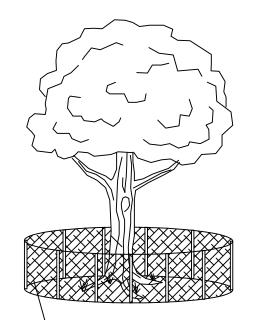

PLACE PLASTIC SNOW FENCE OR SIMILAR BARRIER AROUND THE TREE 1 FT. BEYOND CROWN

SHOWN ABOVE. ANY TREE TO REMAIN THAT MAY SUSTAIN DAMAGE DURING CONSTRUCTION SHALL BE PROTECTED AS SHOWN ABOVE.

ANY TREE TO REMAIN THAT MAY SUSTAIN DAMAGE

DURING CONSTRUCTION SHALL BE PROTECTED AS


1. NO STOCKPILING OF MATERIALS, VEHICULAR TRAFFIC OR STORAGE OF EQUIPMENT OR MACHINERY SHALL BE ALLOWED WITHIN THE LIMIT OF THE FENCING.

2. FENCING SHALL NOT BE MOVED OR REMOVED UNLESS APPROVED BY THE VILLAGE ENGINEER. 3. WORK WITHIN THE PROTECTED AREA SHALL BE DONE MANUALLY

UNDER THE SUPERVISION OF THE VILLAGE'S ENGINEER. 4. FENCING SIGNAGE MUST BE POSTED — 'TREE PROTECTION AREA


TREE PROTECTION DETAIL

ENTRANCE PROHIBITED. TO REPORT VIOLATORS CALL 845-986-3423.'

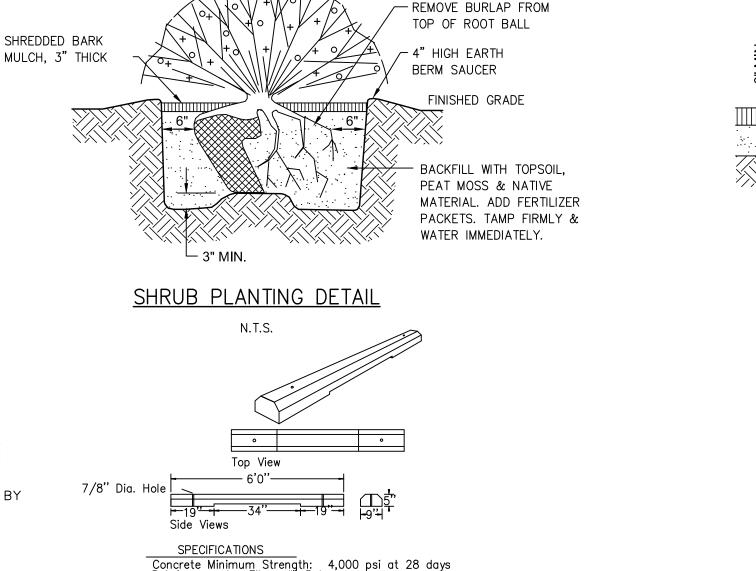

Concrete Minimum Strength: 4,000 psi at 28 days Reinforcement: Fiber, #4 Rebar Air Entrainment: 5% Weight: 250 lbs PRECAST PARKING BUMPERS MODEL SBB Woodard's Concrete Products, Inc. 629 Lybolt Road, Bullville, NY 10915

(914) 361-3471 / Fax 361-1050

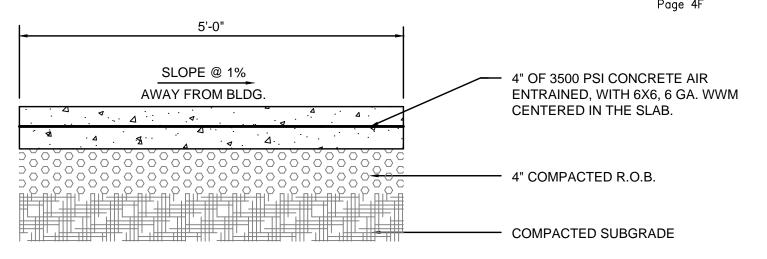

FĚZŒ Ò PÁU ÁÓ ÒÁÓÜUUT ÁZŒ Ò PÁŒVÁJ€»Á/U ÁÒ ŒÔ PÁÙ WÔ Ô Ò Ò Ö Œ Õ ÁÙ ŠŒÓ È

2. JOINTER TO BE 1" DEEP. JOINT SPACING SHALL BE EQUAL TO WIDTH OF WALK FOR SPACING.

3. INSTALL 1/2" PRE-MOLDED EXPANSION JOINT AT 24' O.C. AND WHERE SIDEWALK IS AGAINST CONCRETE CURBS, BUILDINGS, AND OTHER STRUCTURES.

CONCRETE SIDEWALK DETAIL

N.T.S.


## ┌ GROUNDCOVER -SHREDDED HARDWOOD BARK MULCH, 3" THK. BACKFILL VARIES `\_EXISTING MIXTURE SUBSOIL SEE PLANT LIST PLAN VIEW

GROUNDCOVER PLANTING DETAIL

N.T.S.

1'-0" RESERVED PARKING FINISHED GRADE

HANDICAP SIGN DETAIL

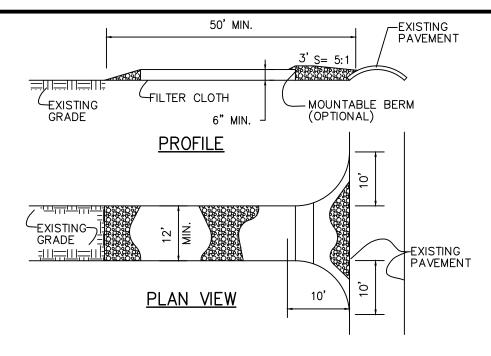

### GRAVEL CONSTRUCTION BLANKET

#### GRAVEL CONSTRUCTION ENTRANCE BLANKET SPECIFICATIONS:

SINGLE FAMILY LOT.


- 1. STONE SIZE USE 1"-4" STONE, OR RECLAIMED OR RECYCLED CONCRETE EQUIVALENT.
- LENGTH AS REQUIRED, BUT NOT LESS THAN 50 FT.
- THICKNESS NOT LESS THAN SIX (6) INCHES. WIDTH - TWELVE (12) FT. MINIMUM, BUT NOT LESS THAN THE FULL
- WIDTH AT POINTS WHERE INGRESS OR EGRESS OCCURS. FILTER CLOTH - WILL BE PLACED OVER THE ENTIRE AREA PRIOR TO PLACING OF STONE. FILTER WILL NOT BE REQUIRED ON A
- SURFACE WATER ALL SURFACE WATER FLOWING OR DIVERTED TOWARD CONSTRUCTION ENTRANCES SHALL BE PIPED ACROSS THE ENTRANCE. IF PIPING IS IMPRACTICAL, A MOUNTABLE BERM WITH 5:1 SLOPES WILL BE PERMITTED.
- MAINTENANCE THE ENTRANCE SHALL BE MAINTAINED IN A CONDITION WHICH WILL PREVENT TRACKING OR FLOWING OF SEDIMENT ONTO PUBLIC RIGHT-OF-WAY. THIS MAY REQUIRE PERIODIC TOP DRESSING WITH ADDITIONAL STONE AS CONDITIONS DEMAND AND REPAIR AND/OR CLEAN OUT OF ANY MEASURES USED TO TRAP SEDIMENT. ALL SEDIMENT SPILLED, DROPPED, WASHED OR TRACKED ONTO PUBLIC RIGHT-OF-WAY MUST BE REMOVED
- IMMEDIATELY. WASHING - WHEELS SHALL BE CLEANED TO REMOVE SEDIMENT PRIOR TO ENTRANCE ONTO PUBLIC RIGHT-OF-WAY. WHEN WASHING IS REQUIRED, IT SHALL BE DONE ON A AREA STABILIZED WITH STONE
- AND WHICH DRAINS INTO A APPROVED SEDIMENT TRAPPING DEVICE. PERIODIC INSPECTION AND NEEDED MAINTENANCE SHALL BE PROVIDED AFTER EACH RAIN.

## SOIL EROSION NOTES

- 1. SILT FENCE BARRIERS SHALL BE INSTALLED PRIOR TO CONSTRUCTION.
- 2. DISTURBANCE TO BE LIMITED TO THE MINIMUM NECESSARY FOR THE GRADING
- AND CONSTRUCTION OF THE DWELLING, DRIVEWAY, LAWN, UTILITIES, ETC.
- 3. TEMPORARY SEEDING WITH ANNUAL RYE GRASS OR OTHER RAPID GROWING MIXTURE SHALL BE PERFORMED ON DISTURBED SOIL REMAINING
- VACANT FOR MORE THAN ONE MONTH AS FOLLOWS: a. LOOSEN SEEDED BY DISCING TO 4" DEPTH.

d. MULCH WITH STRAW MULCH (90 lbs. per 1000 s.f.)

- b. FERTILIZE AS PER SOIL TEST OR APPLY 5-10-10 FERTILIZER (20 lbs. per 1000 s.f.) c. SEED WITH PERENNIAL RYEGRASS (20 lbs. per 1000 s.f.)
- 4. ALL DISTURBED AREAS TO BE MULCHED TO PREVENT EROSION, THE CONTRACTOR SHALL COMPLY WITH ALL REQUESTS OF THE TOWN
- ENGINEER OR BUILDING INSPECTOR DURING CONSTRUCTION WITH REGARD TO EROSION CONTROL DEVICES.
- 5. EROSION CONTROL MEASURES SHALL REMAIN IN PLACE AND BE MAINTAINED BY THE CONTRACTOR UNTIL PERMANENT STABILIZATION HAS BEEN ESTABLISHED.

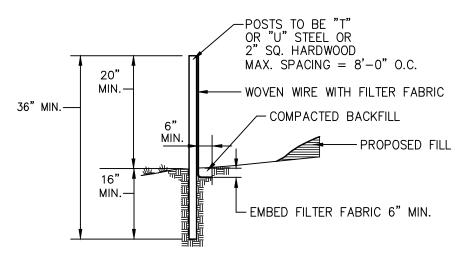

## SILT FENCE DETAIL

1. WHERE TWO SECTIONS OF FILTER CLOTH ADJOIN EACH OTHER, THEY

- MAINTENANCE SHALL BE PERFORMED AS NEEDED AND MATERIAL
- REMOVED WHEN "BULGES" DEVELOP IN THE SILT FENCE.
- SILT FENCE FABRIC TO BE MIRAFI 100X OR APPROVED EQUAL. 4. WOVEN WIRE FENCE (MIN. 14.5 GAUGE, MAX 6" MESH SPACING)

4	3/20/18	FOR PLANNING BOARD REVIEW
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ISSUE	DATE	DESCRIPTION

### SITE PLAN FOR TIN BARN BREWING INC.

SECTION 17, BLOCK 1, LOT 20.2 TOWN OF CHESTER ORANGE COUNTY, NEW YORK

## CONSTRUCTION DETAILS




DAVID A. GETZ, P.E.

17 RIVER STREET WARWICK, NEW YORK 10990


N.Y.S. LIC. No. 61265 SCALE JOB NO. AS NOTED


4"x4" WOOD \_ 6" CONCRETE SLAB W/WELDED WIRE MESH POST (TYP)-'-0" (TYP) 8"x8" STEEL PLATE (TYP) HANDICAP PARKING WASTE DUMPSTER ≤ SIGN (SEE DETAIL) ←6' HIGH STOCKADE FENCE DUMPSTER ENCLOSURE CAR VAN (2) 6' WOODEN STOCKADE FENCE DOOR


**DUMPSTER AREA DETAIL** NOT TO SCALE

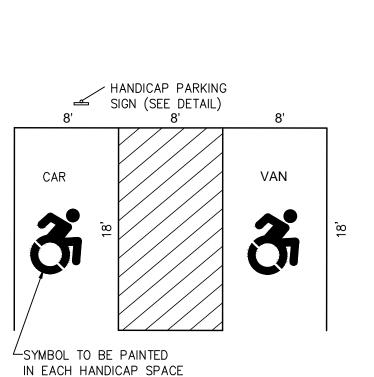


HANDICAP PARKING DETAIL N.T.S.

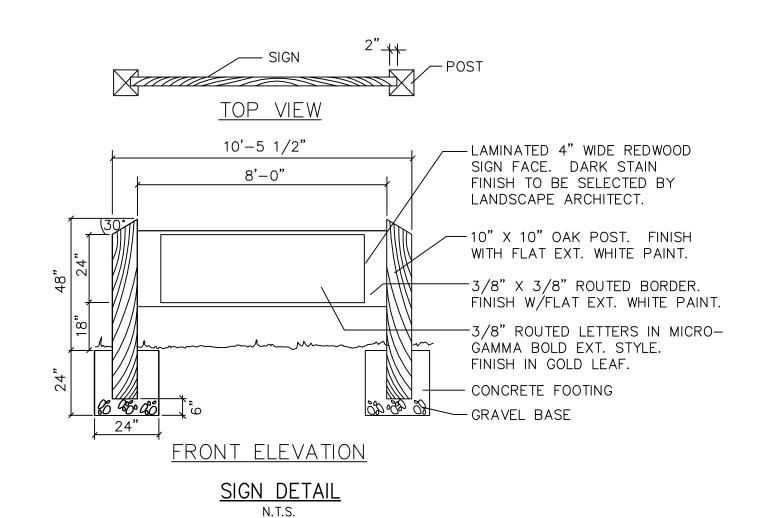

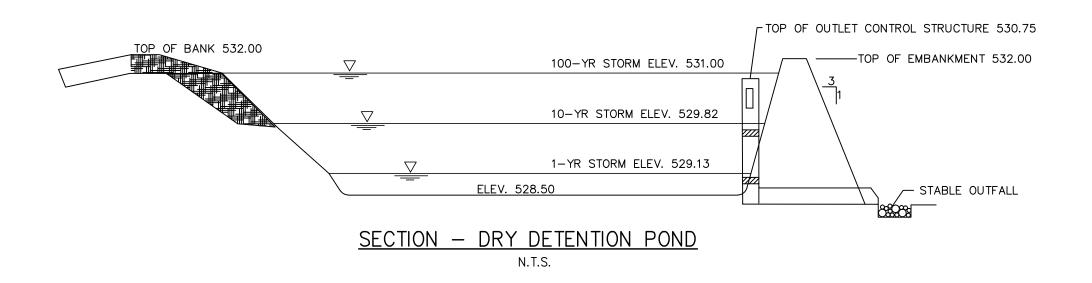

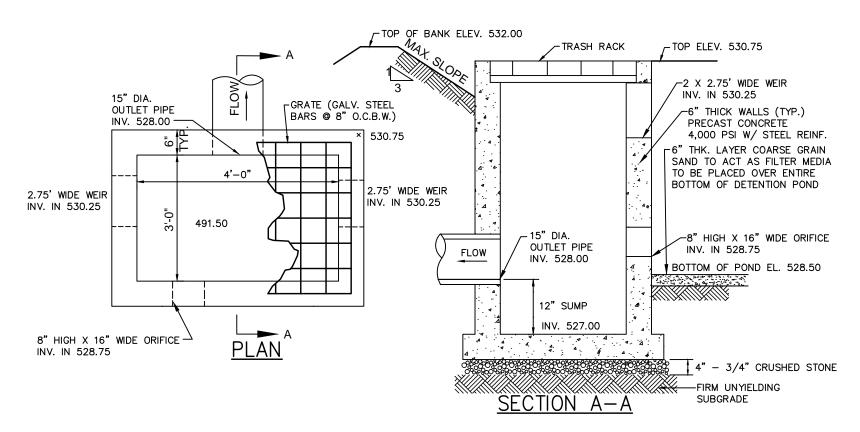


OUTLET CONTROL STRUCTURE
N.T.S.

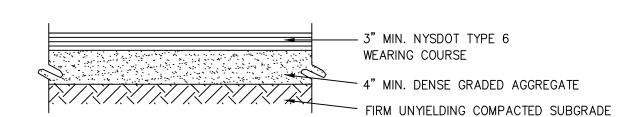

TYPICAL DRIVEWAY PAVEMENT SECTION

N.T.S.

NOTE: REFER ALSO TO TOWN OF CHESTER PAVEMENT SECTION.

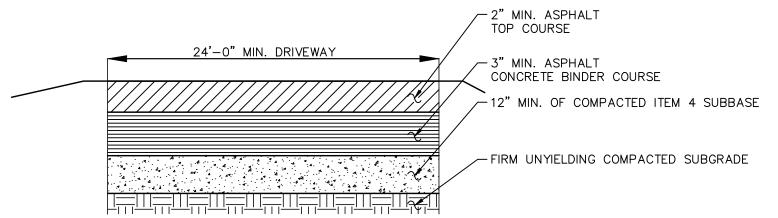


#### NOTES:


- 1. THIS PAVEMENT SECTION APPLIES TO ALL NEW PAVEMENT INSTALLED WITHIN THE TOWN OF CHESTER'S RIGHT-OF-WAY AND FOR THE FULL WIDTH OF THE NEW DRIVEWAY, FROM THE EDGE OF TRAVEL LANE FOR 15 FT.
- 2. ALL ASPHALT IS REQUIRED TO BE SAW CUT PARALLEL AND/OR PERPENDICULAR TO THE EDGE OF PAVEMENT TO PROVIDE A CLEAN TIE INTO THE EXISTING PAVEMENT.
- 3. ALL EDGES OF EXISTING ASPHALT ARE REQUIRE TO BE SWEPT AND TACK COATED PRIOR TO ANY (TEMPORARY AND PERMANENT) PAVING.
- 4. THE ROADWAY SHALL BE KEPT CLEAN AT ALL TIMES DURING CONSTRUCTION. THERE SHOULD NOT BE ANY DIRT, MUD OR DEBRIS ON LAKE STATION ROAD.
- 5. APPROPRIATE TRAFFIC CONTROL MEASURES SHALL BE IN PLACE DURING CONSTRUCTION OR WHEN LAKE STATION ROAD IS OBSTRUCTED IN ANY WAY DUE TO ACTIVITIES AT THE


## TOWN OF CHESTER PAVEMENT SECTION

NOT TO SCALE

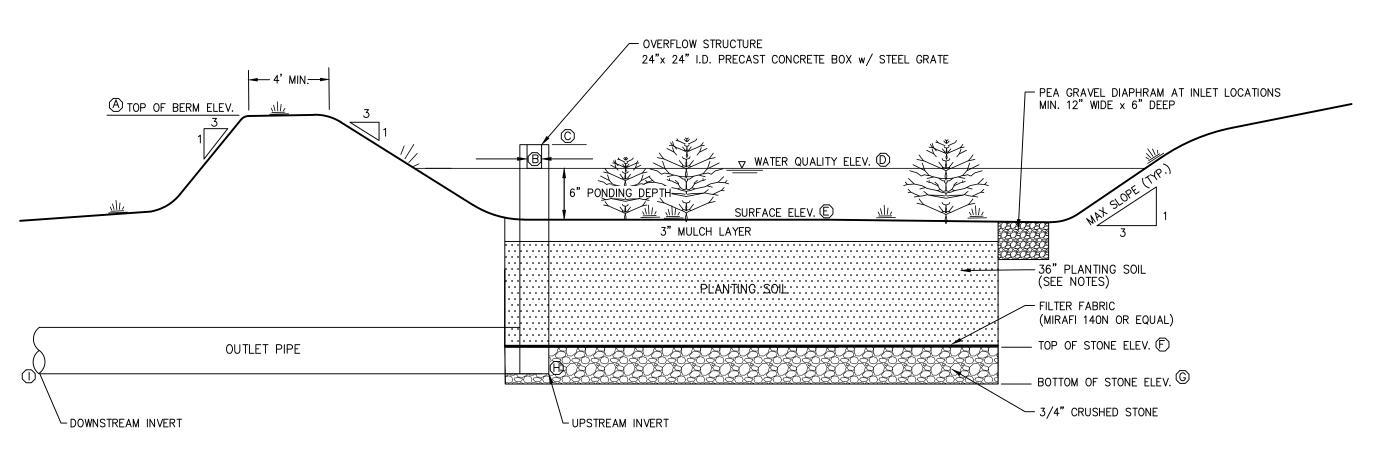


## SECTION -- BIORETENTION SYSTEM

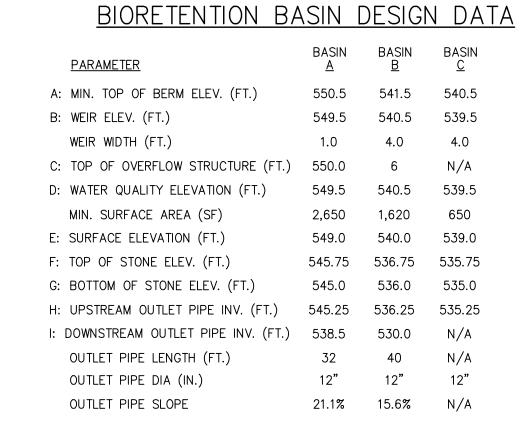


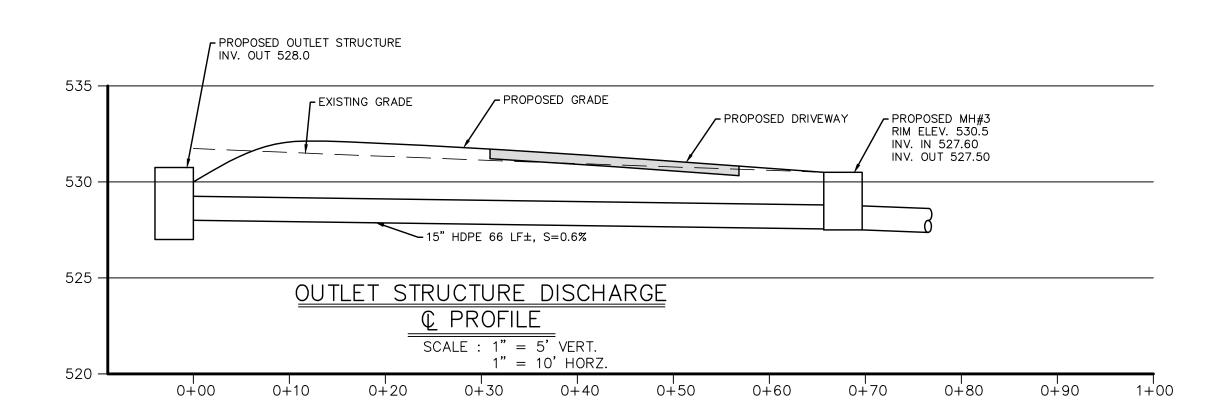

4	3/20/18	FOR PLANNING BO	DARD REVIEW						
3	1/29/18	FOR PLANNING BO	DARD REVIEW						
2	11/21/17 FOR PLANNING BOARD REVIEW								
1	4/10/17	FOR NYSDEC REV	IEW						
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		BARN I SECTION 17, TOWN ORANGE COL	BLOCK 1, LOT OF CHESTER JNTY, NEW	20.2 YORK					
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	17 RI	CONSU PH. 845-9 VER STREET W DAVID	AN & GI LTING EN 86-7737 FAX 8 VARWICK, NEV A. GETZ, P.E. LIC. No. 61268	GINEERS 845–986–0245 W YORK 1099	5				
DR/	AWN BY JV	CHECKED BY DAG	SCALE AS NOTED	JOB NO. 2052	SHEET NO. 5 OF 6				
	<del>-</del>		-						

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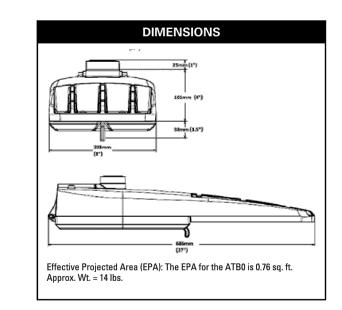
#### Autobahn Series ATB0 Roadway Lighting
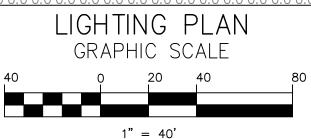
#### PRODUCT OVERVIEW

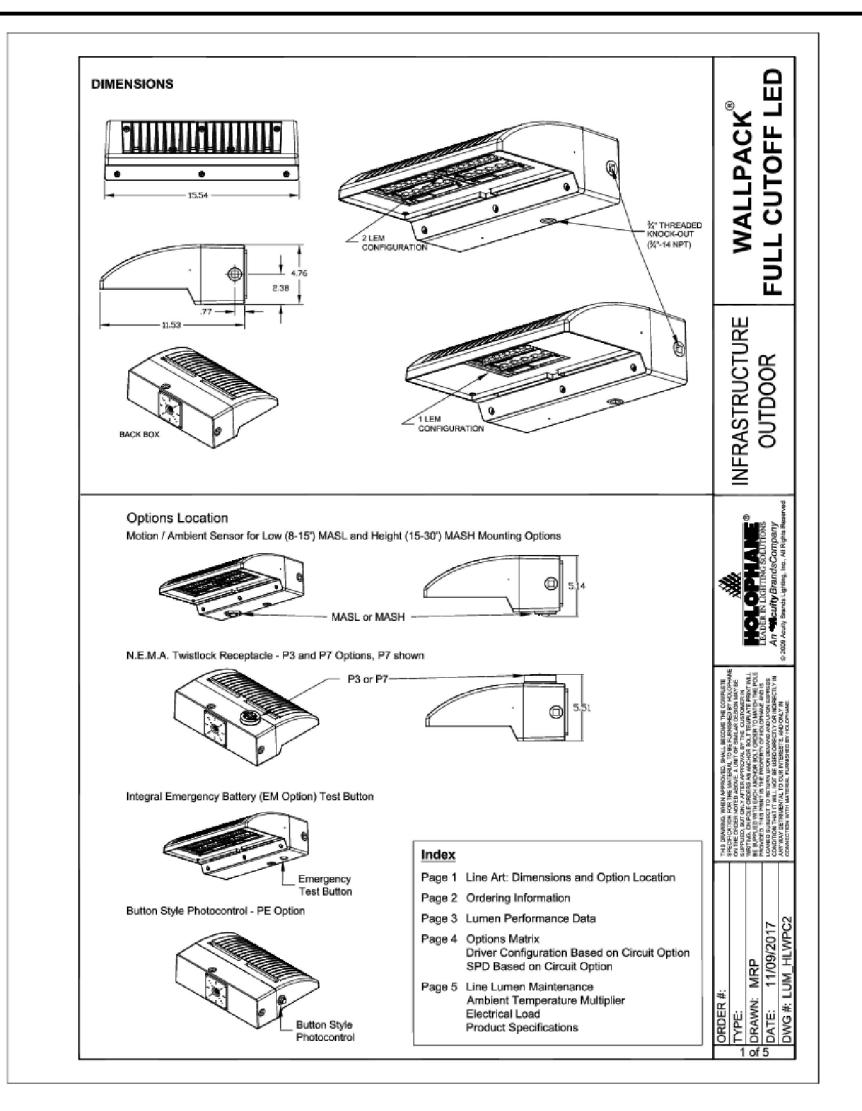

# Applications: Roadways Off ramps

#### Roadways Off ramps Residential streets Parking lots



#### STANDARDS

DesignLights Consortium® (DLC) qualified product. Not all versions of this product may be DLC qualified. Please check the DLC Qualified Products List at <a href="https://www.designlights.org/QPL">www.designlights.org/QPL</a> to confirm which versions are qualified. Color temperatures of ≤ 3000K must be specified for International Dark-Sky Association certification.

Rated for -40°C to 40°C ambient CSA Certified to U.S. and Canadian standards Complies with ANSI: C136.2, C136.10, C136.14, C136.31, C136.15, C136.37

#### Features:

## OPTICAL

Same Light: Performance is comparable to 70-250W HPS roadway luminaires. White Light: Correlated color temperature - 4000K, 70 CRI minimum, 3000K,

70 CRI minimum or optional 5000K, 70 CRI minimum.

Unique IP66 rated LED light engines provided 0% uplight and restrict backlight to within sidewalk depth, providing optimal application coverage and optimal pole spacing. Available in Type II, III, IV, and V roadway distributions.

#### ELECTRICAL

Expected Life: LED light engines are rated >100,000 hours at 25°C, L70. Electronic driver has an

expected life of 100,000 hours at a 25°C ambient.

Lower Energy: Saves an expected of 40-60% over comparable HID luminaires.

Robust Surge Protection: Three different surge protection options provide a minimum of ANSI C136.2 10kV/5kA protection. 20kV/10kA protection is also available.

#### MECHANICAL

Includes standard AEL lineman-friendly features such as tool-less entry, 3 station terminal block and quick disconnects. Bubble level located inside the electrical compartment for easily leveling

Rugged die-cast aluminum housing and door are polyester powder-coated for durability and corrosion resistance. Rigorous five-stage pre-treating and painting process yields a finish that achieves a scribe creepage rating of 7 (per ASTM D1654) after over 5000 hours exposure to salt fog chamber (operated per ASTM B117).

Mast arm mount is adjustable for arms from 1-1/4" to 2" (1-5/8" to 2-3/8" 0.D.) diameter. Provides a 3G vibration rating per ANSI C136.31

Wildlife shield is cast into the housing (not a separate piece).

NEMA 3 pin photocontrol receptacle is standard, with the Acuity designed ANSI standard 7 pin receptacle optionally available.

Premium solid state locking style photocontrol - PCSS (10 year rated life) Extreme long life solid state locking style photocontrol - PCLL (20 year rated life).


Multi-level dimming available to provide scheduled dimming as specified by the customer.

Optional onboard Adjustable Output module allows the light output and input wattage to be modified to meet site specific requirements, and also can allow a single fixture to be flexibly applied in many different applications.

Note: Specifications subject to change without notice. Actual performance may differ as a result of end-user environment and application.

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LIGHT POLE FOOTING DETAIL

N.T.S.

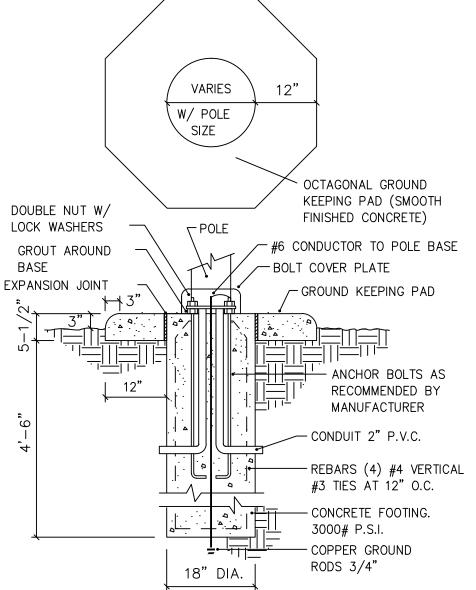1. Readings shown are based on a total LLF of as shown at grade. Data
references the extrapolated performance projections in a 25c ambient
based on 10,000 hrs of LED testing (per IESNA LM-80-08 and projected
per IESNA TM-21-11).

2. Please refer to the "luminaire locations" for mounting heights.

3. Product information can be obtained at www.Holophane.com or through your local agency.

Description	Symbol	Avg	Max	Min	Max/Min	Avg/Min
Parking Lot	$\Diamond$	2.3 fc	6.0 fc	0.8 fc	7.5:1	2.9:1
Roadway		2.4 fc	9.0 fc	0.5 fc	18.0:1	4.8:1
Site	T +	0.5 fc	9.0 fc	0.0 fc	N/A	N/A

Schedule											
Symbol	Label	Quantity	Manufacturer	Catalog Number	Description	Lamp	Number Lamps	Filename	Lumens Per Lamp	Light Loss Factor	Wattage
Ô	А	5	American Electric Lighting	ATB0 20BLEDE10 XXXXX R4 4K/5K	ATB0 SERIES LED 1000MA TYPE 4 4000K/5000K CCT	LED Array	1	ATB0_20BLEDE10_XXXXX_R 4_4K_5K.ies	8569	0.98	72
^ M	В	2	American Electric Lighting	ATB0 20BLEDE10 XXXXX R3 4K/5K	ATB0 SERIES LED 1000MA TYPE 3 4000K/5000K CCT	LED Array	1	ATB0_20BLEDE10_XXXXX_R 3_4K_5K.ies	8606	0.98	71
^	С	4	American Electric Lighting	ATB0 20BLEDE10 XXXXX R2 4K/5K	ATB0 SERIES LED 1000MA TYPE 2 4000K/5000K CCT	LED Array	1	ATB0_20BLEDE10_XXXXX_R 2_4K_5K.ies	8506	0.98	71
^	D	1	American Electric Lighting	ATB0 20BLEDE10 XXXXX R4 4K/5K HSS	ATB0 SERIES LED 1000MA TYPE 4 4000K/5000K CCT HSS	LED Array	1	ATB0_20BLEDE10_XXXXX_R 4_4K_5K_HSS.ies	6775	0.98	72
^	Е	4	American Electric Lighting	ATB0 20BLEDE10 XXXXX R5 4K/5K	ATB0 SERIES LED 1000MA TYPE 5 4000K/5000K CCT	LED Array	1	ATB0_20BLEDE10_XXXXX_R 5_4K_5K.ies	8879	0.98	71
$\stackrel{\wedge}{\boxtimes}$	VV	4	Holophane	HLWPC2 P20 40K XX T3M XXXXX 80CRI XXXXX 2CI	Wallpack Full Cutoff LED, LED Performance Package P20, 4000 series CCT, Voltage, Type III Medium with 80 CRI LEDs and 2 independent circuits	LED	1	HLWPC2_P20_40K_XX_T3M_ XXXXX_80CRI_XXXXX_2CI.ie s	4617	0.92	49

4	3/20/18	FOR PLANNING BOARD REVIEW
3	1/29/18	FOR PLANNING BOARD REVIEW
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# TIN BARN BREWING INC.

SECTION 17, BLOCK 1, LOT 20.2 TOWN OF CHESTER ORANGE COUNTY, NEW YORK

## CONSTRUCTION DETAILS



DAVID A. GETZ, P.E. N.Y.S. LIC. No. 61265

N BY CHECKED BY SCALE JOB NO. SHEET NO. DAG AS NOTED 2052 6 OF 6