

OWNER OF RECORD

ZONING TAX ID

IP (INDUSTRIAL PARK DISTRICT) SECTION 06 BLOCK 01 LOT 106

418,612 S.F. / 9.61± ACRES

KIPS BAY HOLDINGS OF WARWICK, LLC.

TOTAL LOT AREA

SITE PLAN FOR **TRADE TRANS CORPORATION 173 BLACK MEADOW ROAD SECTION 6 BLOCK 1 LOT 106 TOWN OF CHESTER** ORANGE COUNTY, N.Y.


T-1 S-1 S-2 S-3 S-4 S-5 S-6 S-7 S-8 S-9 S-10


THIS PLAN CONTAINS 12 SHEETS. THIS SHEET SHALL NOT BE CONSIDERED VALID UNLESS ACCOMPANIED BY THE REMAINING SHEETS.


JNAUTHORIZED ALTERATION OR ADDITIONS TO A PLAN BEARING THE SEAL OF A LICENSED ENGINEER OR LAND SURVEYOR IS A VIOLATION OF SECTION 7209 SUBDIVISION 2 OF THE NEW YORK STATE EDUCATION LAW.

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DWN BY REV DESCRIPTION DO 0 FOR APPROVAL DO REVISED PER TOWN COMMENT DO 2 REVISED PER TOWN COMMENT DO 3 REVISED LIGHTING PLAN



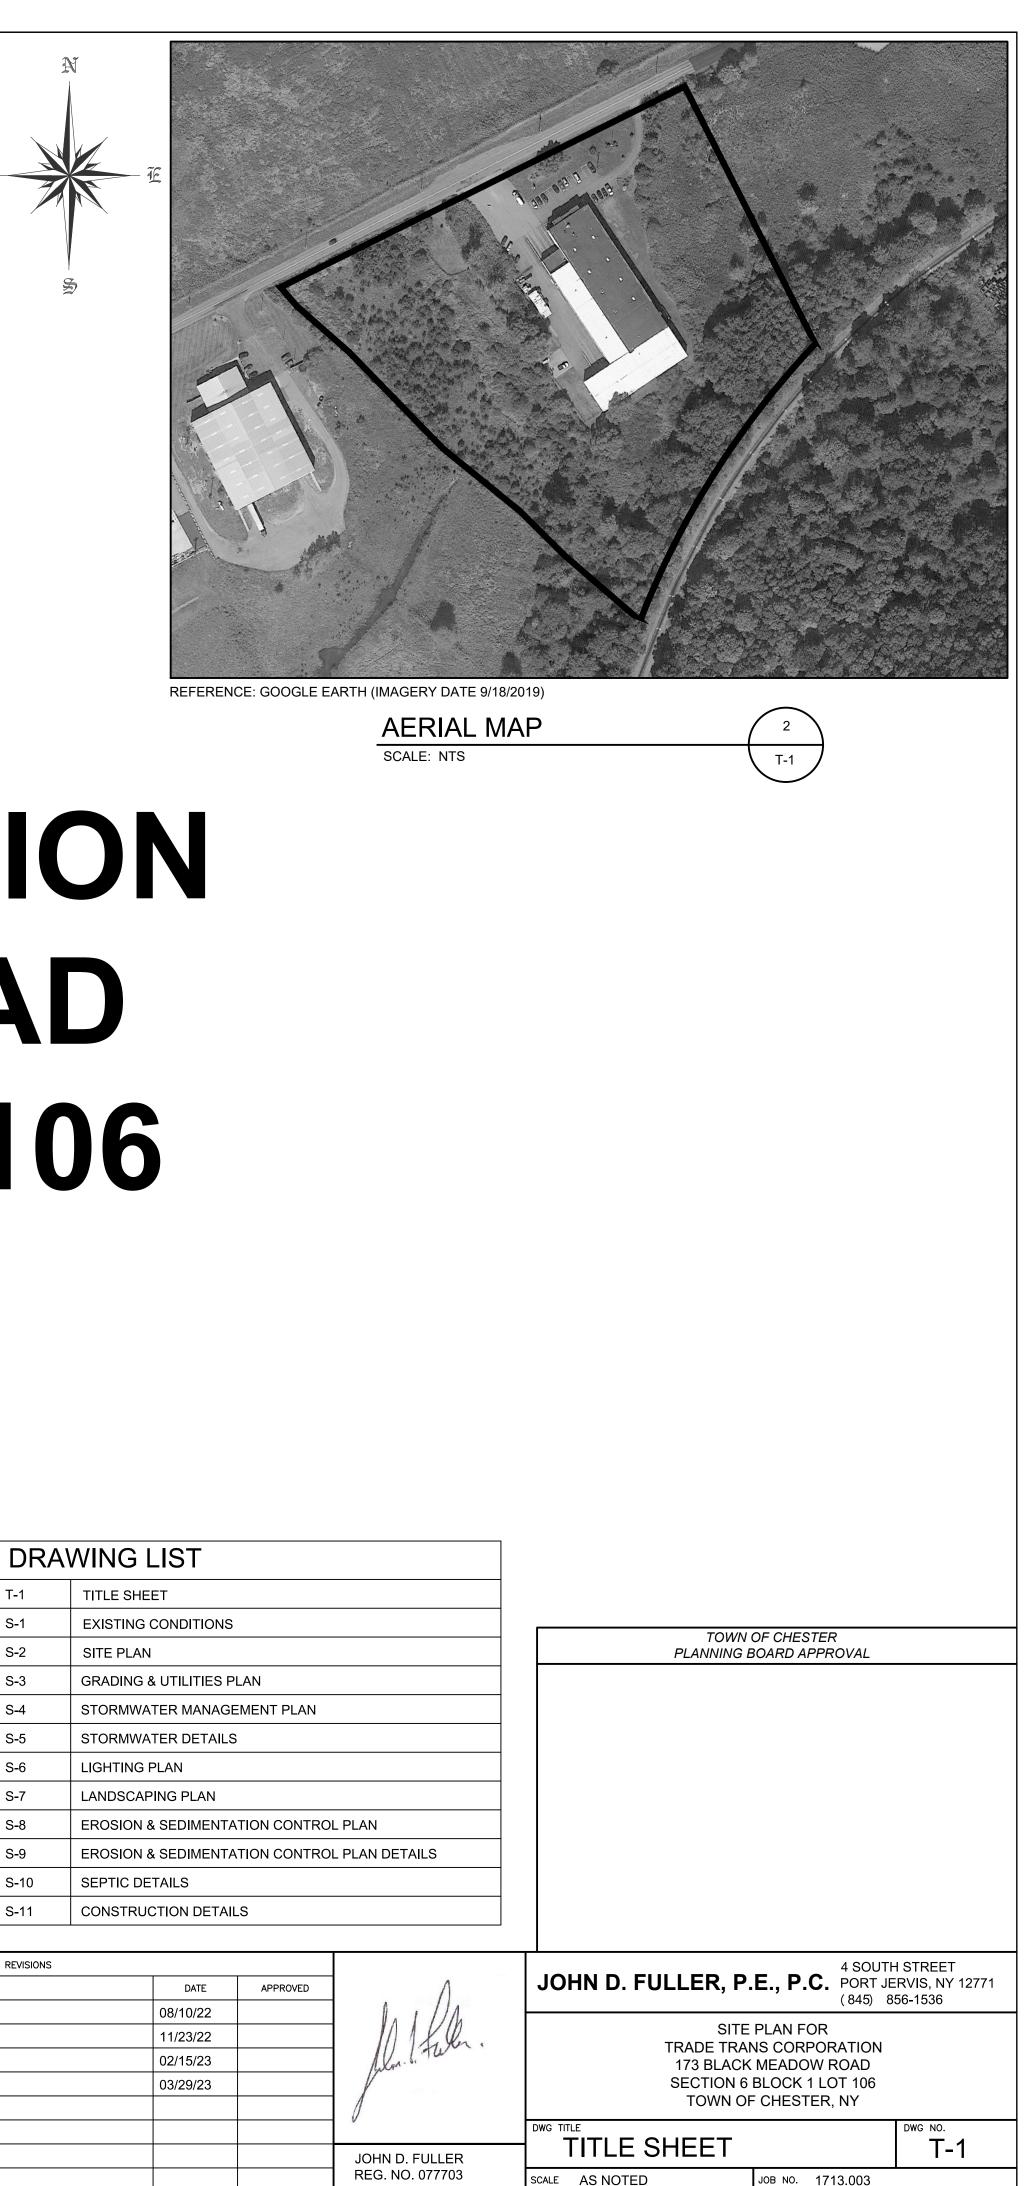

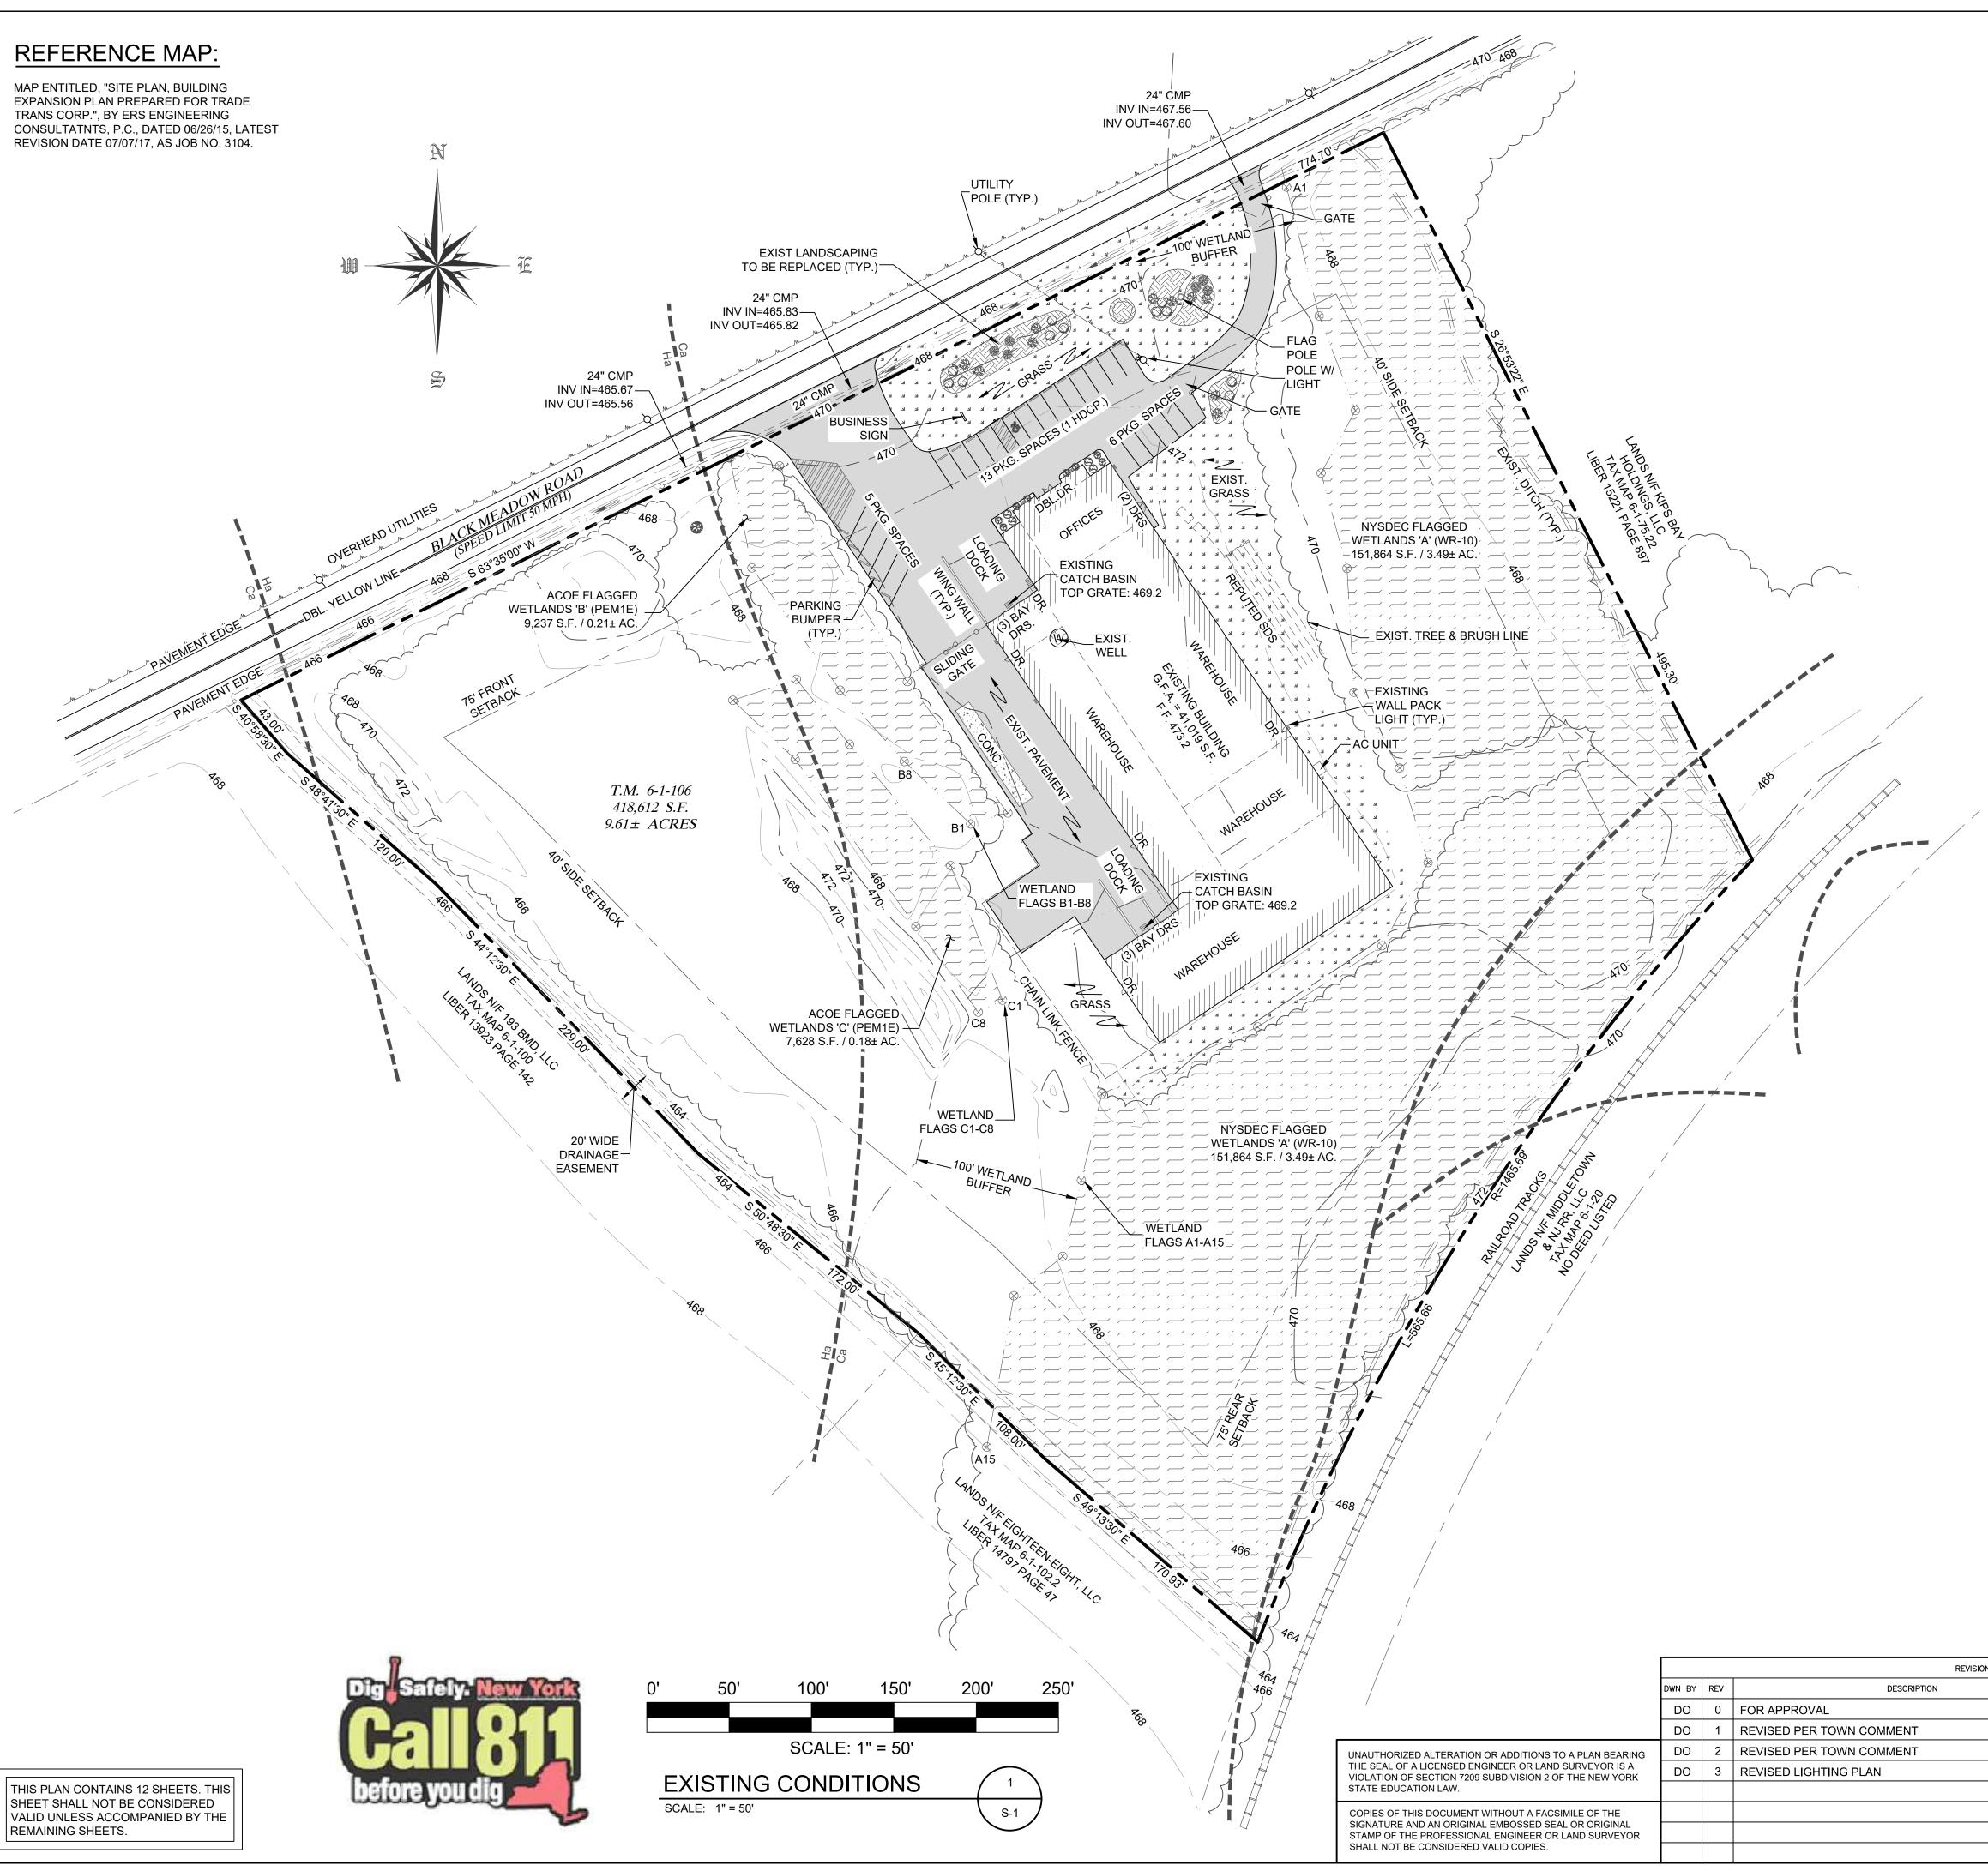

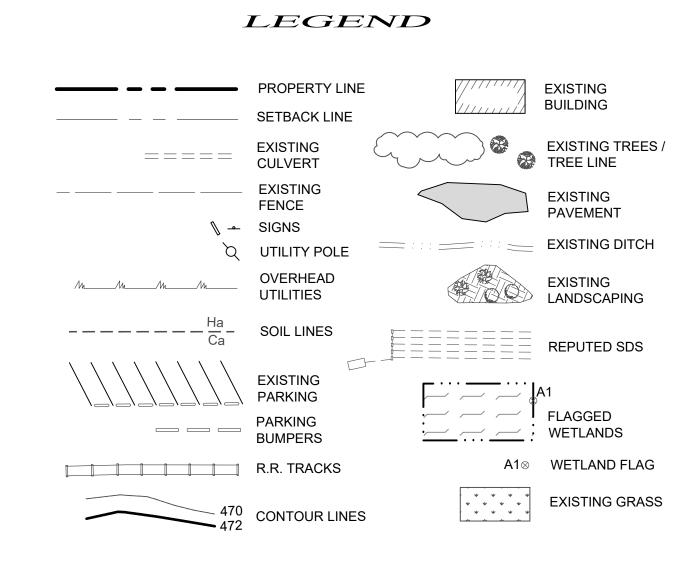GENERAL NOTES

1. OWNER OF RECORD / APPLICANT: KIPS BAY HOLDINGS OF WARWICK, LLC 173 BLACK MEADOW ROAD CHESTER, NY 10918


- 2. TAX MAP DESIGNATION: SECTION 6 BLOCK 1 LOT 106
- 3. PARCEL ZONED: IP (INDUSTRIAL PARK DISTRICT)
- 4. TOTAL AREA: 418,612 S.F. / 9.61± ACRES
- 5. THE ENTIRE SITE IS LOCATED WITHIN FLOOD ZONE AE.
- 6. EXISTING USE: WAREHOUSE / WHOLESALE

BULK TABLE REQUIREMENTS:

ZONED DISTRICT: IP (INDUSTRIAL PARK DISTRICT)


	MINIMUM REQUIREMENTS	EXISTING
LOT AREA:	2 ACRES	9.61 ACRES
LOT WIDTH:	200 FEET	750.4± FEET
LOT DEPTH:	200 FEET	628.3± FEET
FRONT YARD:	75 FEET	99.2± FEET
REAR YARD:	75 FEET	155.9± FEET
1 SIDE YARD:	70 FEET	202.2± FEET
BOTH SIDES:	140 FEET	431.6± FEET
	MAXIMUM PERMITTED	
BLDG. HEIGHT:	45 FEET	< 45 FEET
LOT COVERAGE:	40 %	18.7 %

				TOWN OF CHESTER PLANNING BOARD APPROVAL		
IS	DATE	APPROVED	Δ	JOHN D. FULLEF	4 SOUTH R. P.E., P.C. PORT JEF	STREET RVIS, NY 12771
	08/10/22	AFFROVED	n . //_		(845) 85	
	11/23/22		MILO		SITE PLAN FOR	
	02/15/23		Alm liture.		TRANS CORPORATION	
	03/29/23			SECTI	ON 6 BLOCK 1 LOT 106	
			1		VN OF CHESTER, NY	
						dwg no. S-1
			JOHN D. FULLER REG. NO. 077703	SCALE AS NOTED	JOB NO. 1713.003	0-1

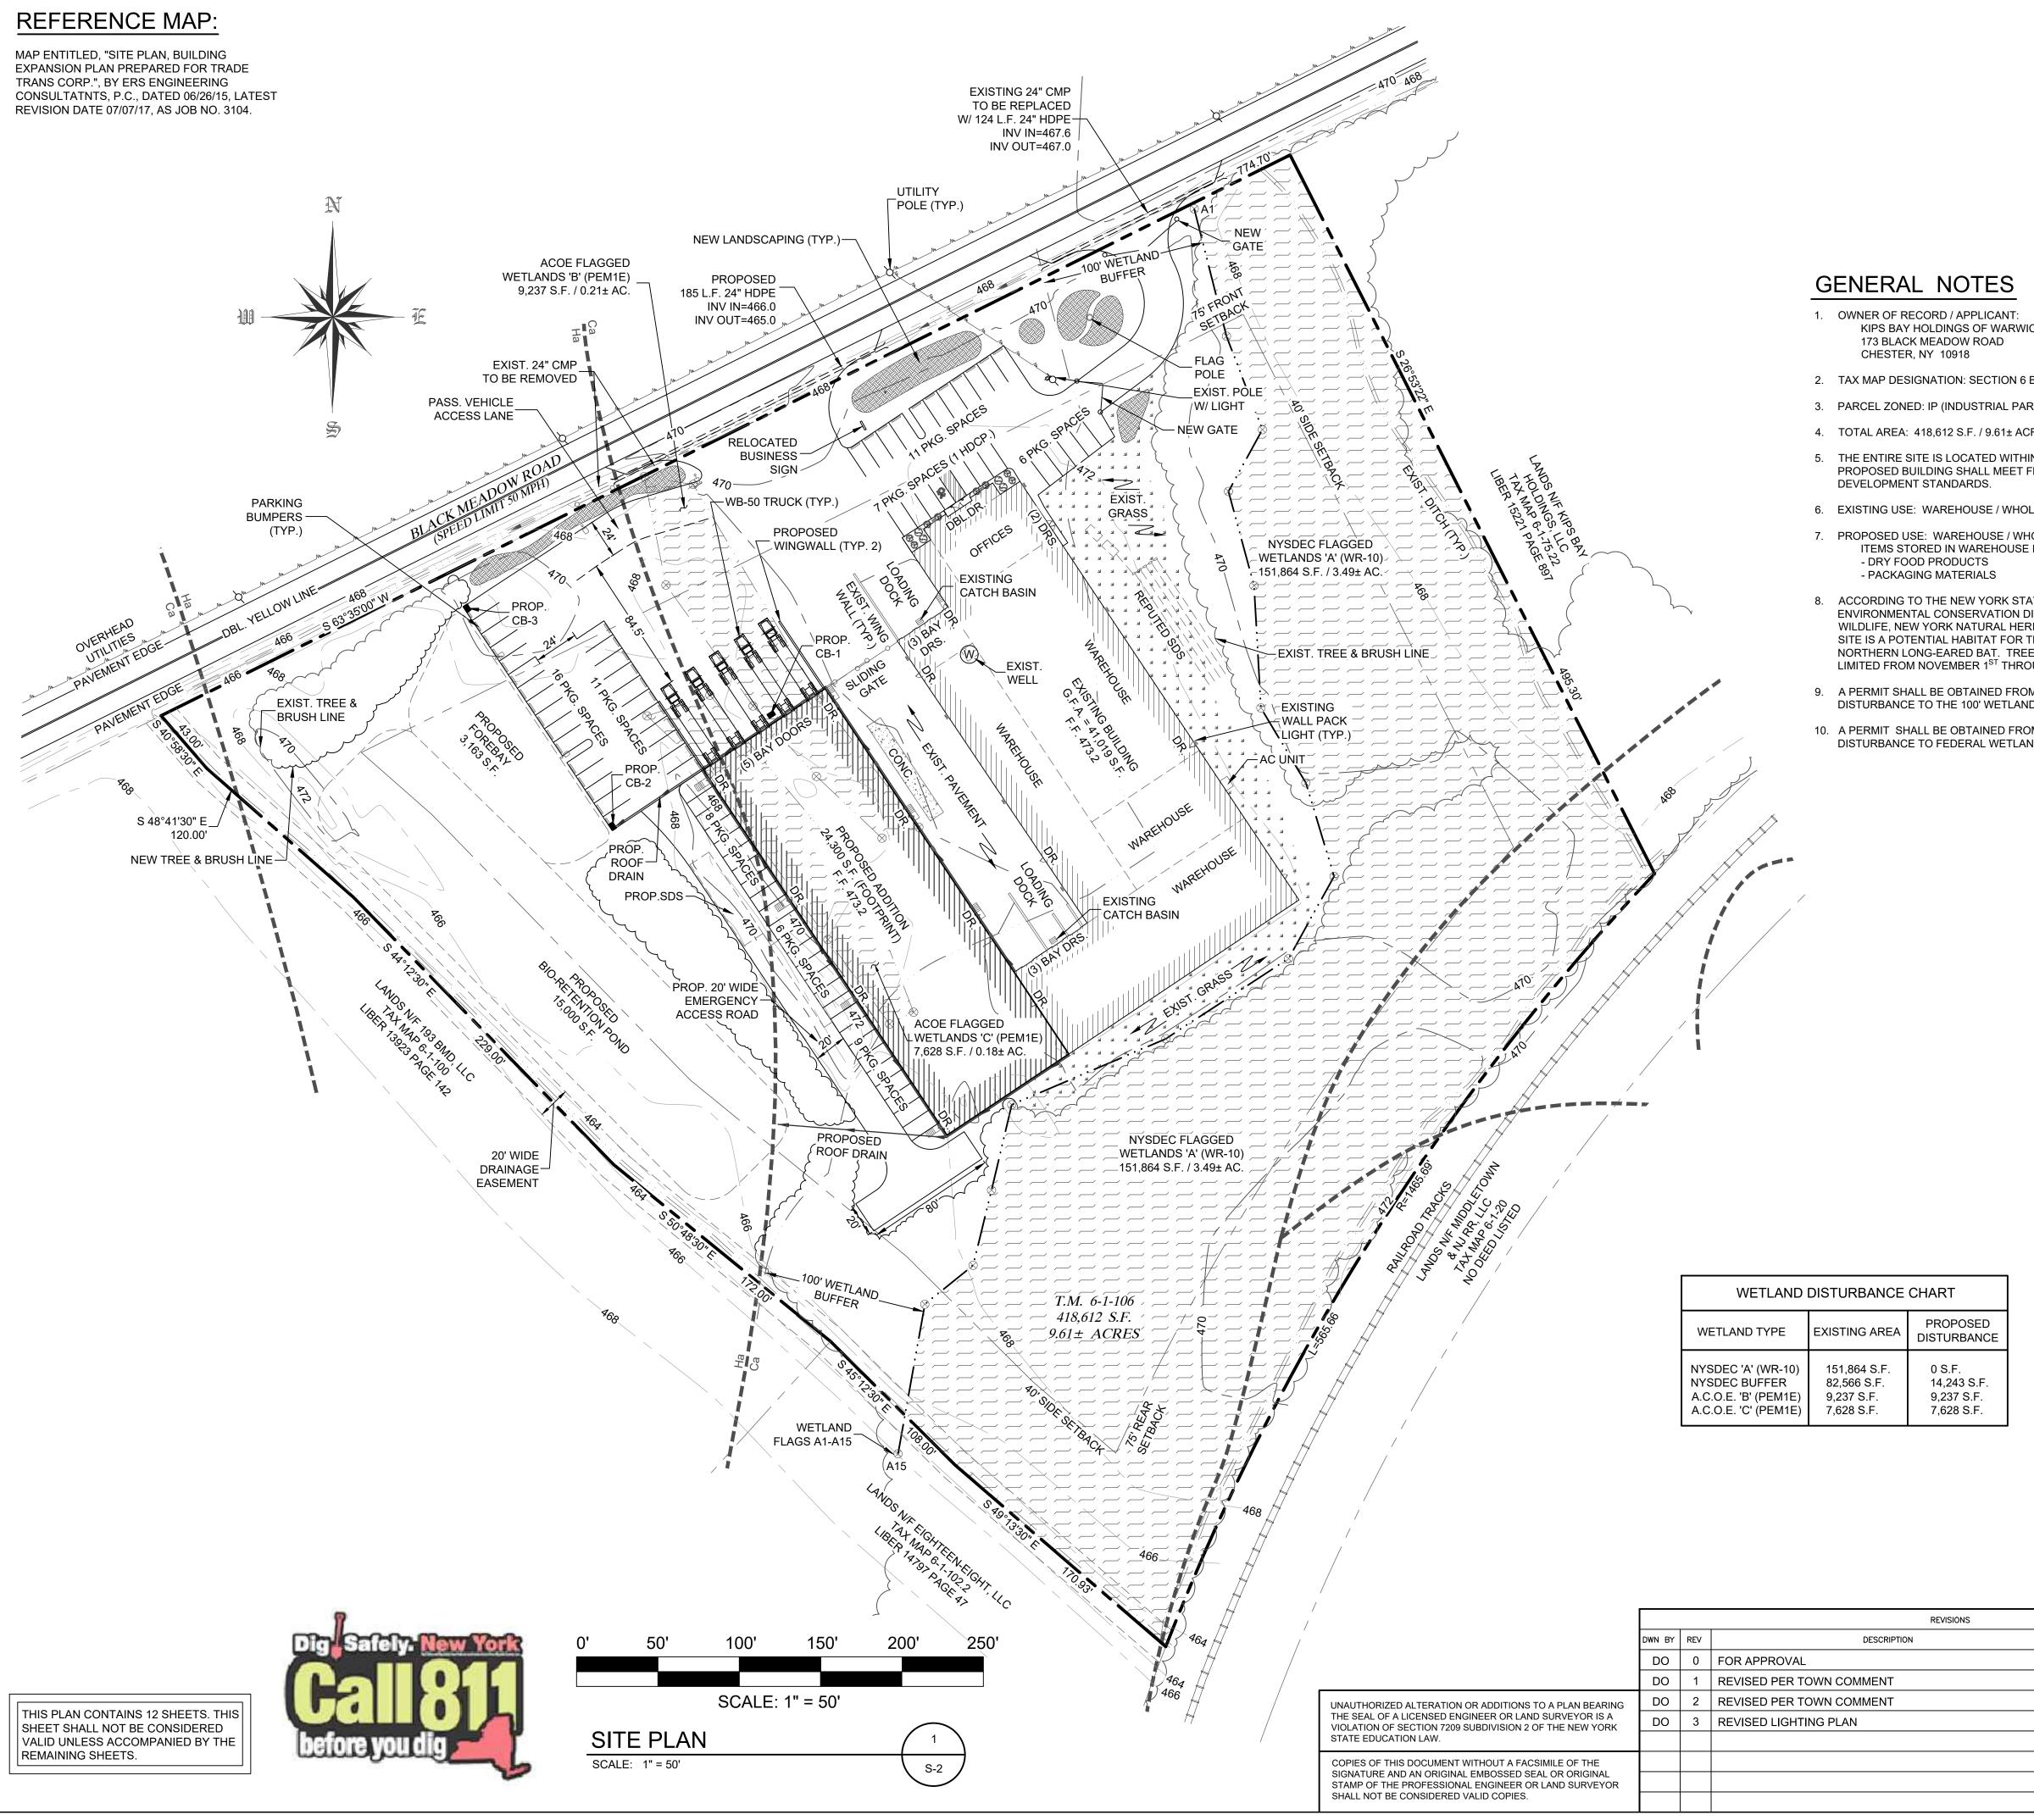


LEGEND

		 PROPERTY LINE SETBACK LINE 		EXISTING BUILDING
	=====	EXISTING CULVERT		PROPOSED ADDITION
	N .	L SIGNS		EXISTING TREES / TREE LINE
	MuMuMuMu	OVERHEAD UTILITIES		PROPOSED PAVEMENT
	Ha Ha Ca	- SOIL LINES		EXISTING DITCH
		PROPOSED		LANDSCAPE BEDS
CK, LLC		PARKING		REPUTED SDS
BLOCK 1 LOT 106		BUMPERS		A1 FLAGGED
RK DISTRICT)				WETLANDS
RES		170 CONTOUR LINES	${\sf A1}_{\otimes}$	WETLAND FLAG
FLOODPLAIN	* * * * * * * * * *	EXISTING GRASS	CB-1	PROPOSED CATCH BASIN
LESALE	L <u>u u u</u>			
IOLESALE INCLUDE:				
ATE DEPARTMENT OF DIVISION OF FISH AND RITAGE PROGRAM, THE THE BOG TURTLE AND E CLEARING SHALL BE DUGH MARCH 31 ST . M THE NYSDEC FOR DS ADJACENT AREA. OM THE ACOE FOR NDS.	ZONED LOT AI LOT W LOT DI FRONT REAR	IDTH: 200 FEET EPTH: 200 FEET I YARD: 75 FEET YARD: 75 FEET	PARK DISTRICT) PROPOSED NTS 9.61 ACRES 750.4± FEET 628.3± FEET 99.2± FEET 155.9± FEET	<u>S:</u>
		YARD: 70 FEET SIDES: 140 FEET	143.4± FEET 345.6± FEET	
		MAXIMUM PERMITTED)	
		HEIGHT: 45 FEET OVERAGE: 40 %	< 45 FEET 25.9 %	
	PAR	KING CALCUL	ATIONS:	
	EXISTING 41 PROPOS 24 TOTAL S TOTAL S TOTAL S	G BLDG = 41,019 S.F. ,019 S.F. / 500 = 82 SPACES	ROSS FLOOR AREA REQUIRED* PROVIDED* PACES REQUIRED 49 = 73 NCLUDES 1 HANDIC R 24 SPACES ON	
			TOWN OF CHESTEI	
			INING BOARD APPE	CUAL
DATE APPROVED	η. Λ.	JOHN D. FULLE	R, P.E., P.C.	4 SOUTH STREET PORT JERVIS, NY 12771 (845) 856-1536
11/23/22	Mtalen.		SITE PLAN FOR E TRANS CORPOR	RATION
02/15/23 03/29/23	fular in	SECT	BLACK MEADOW	OT 106
	l l	DWG TITLE	WN OF CHESTER	R, NY DWG NO.
	JOHN D. FULLER REG. NO. 077703			S-2
		SCALE AS NOTED	JOB NO. 17	13.003

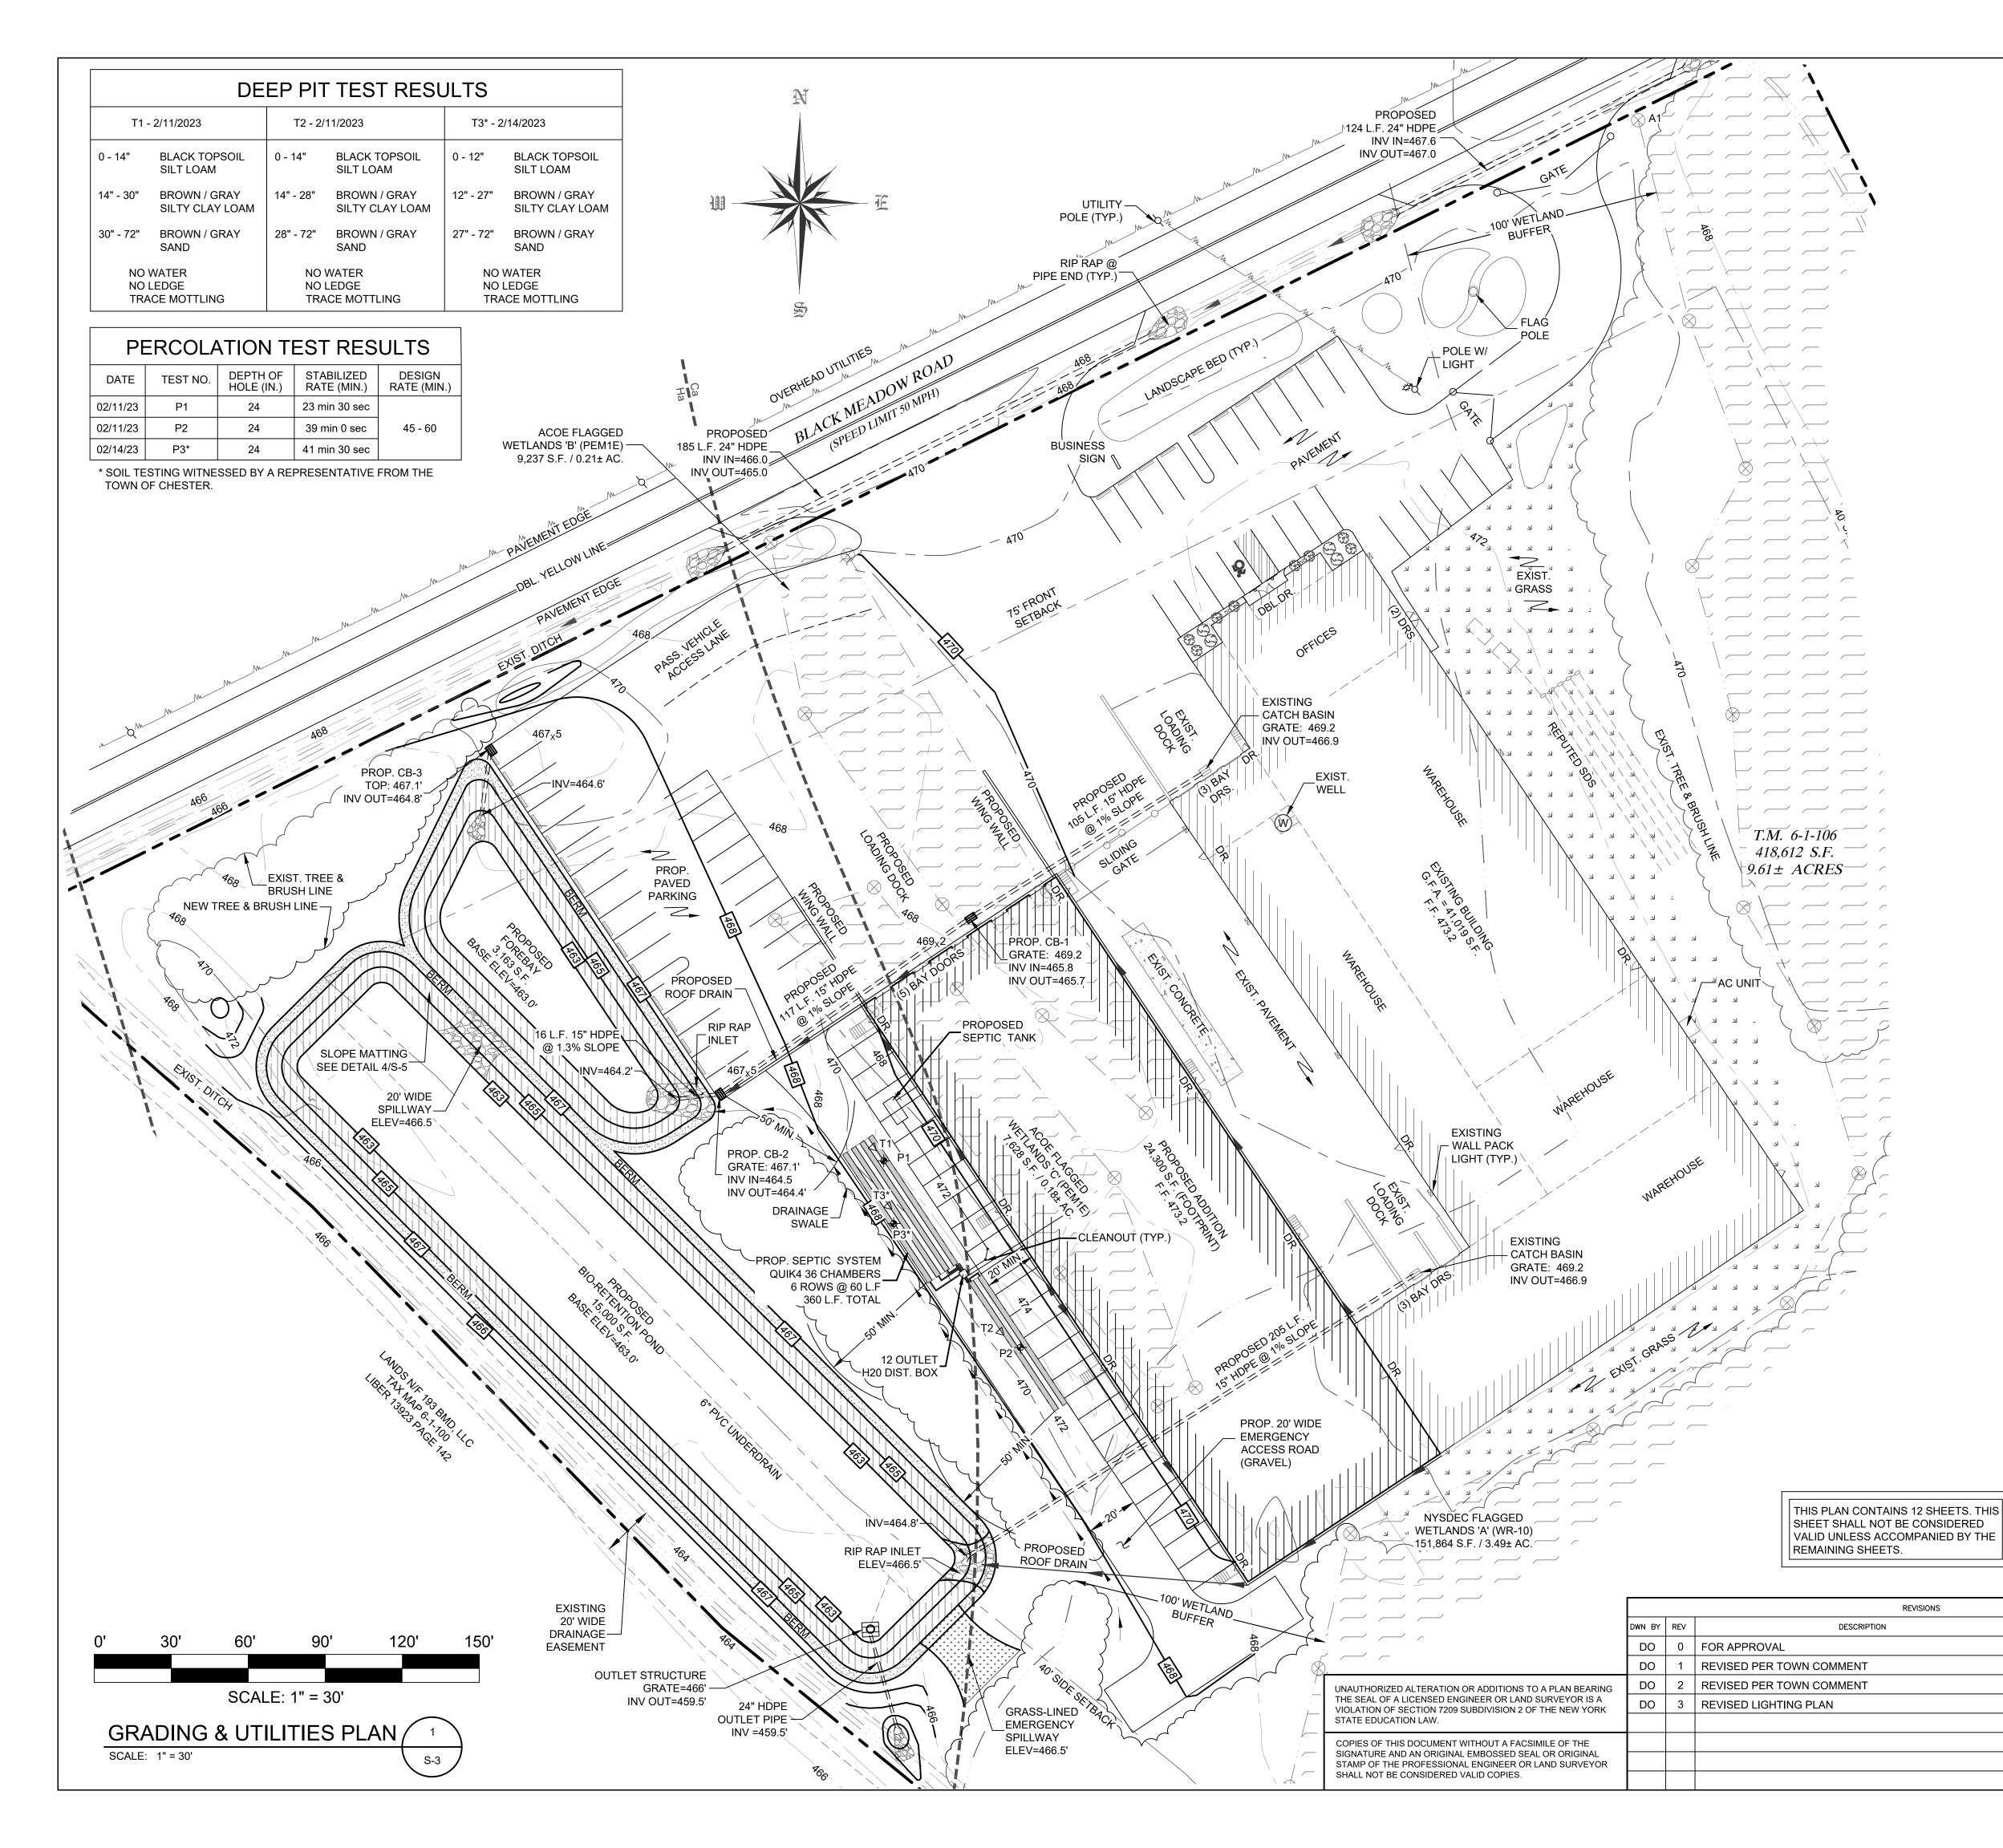

LEGEND

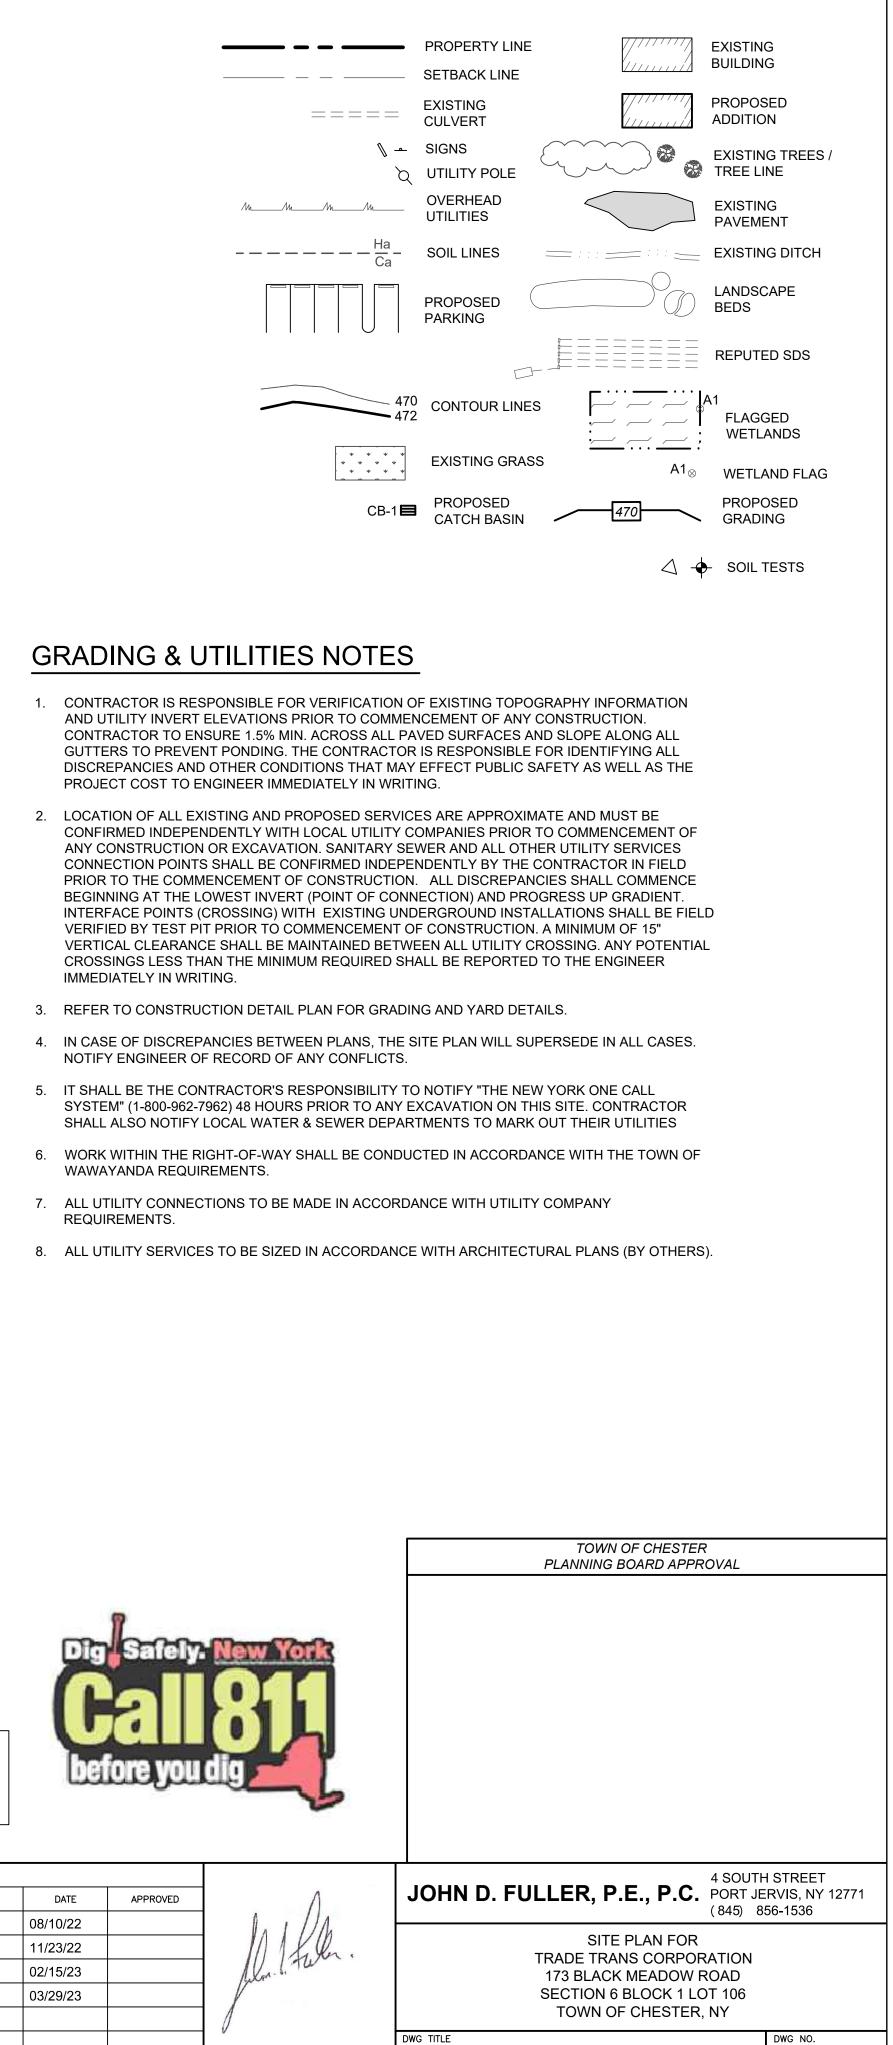

S-3


GRADING & UTILITIES PLAN


JOB NO. 1713.003


SCALE AS NOTED

JOHN D. FULLER

REG. NO. 077703

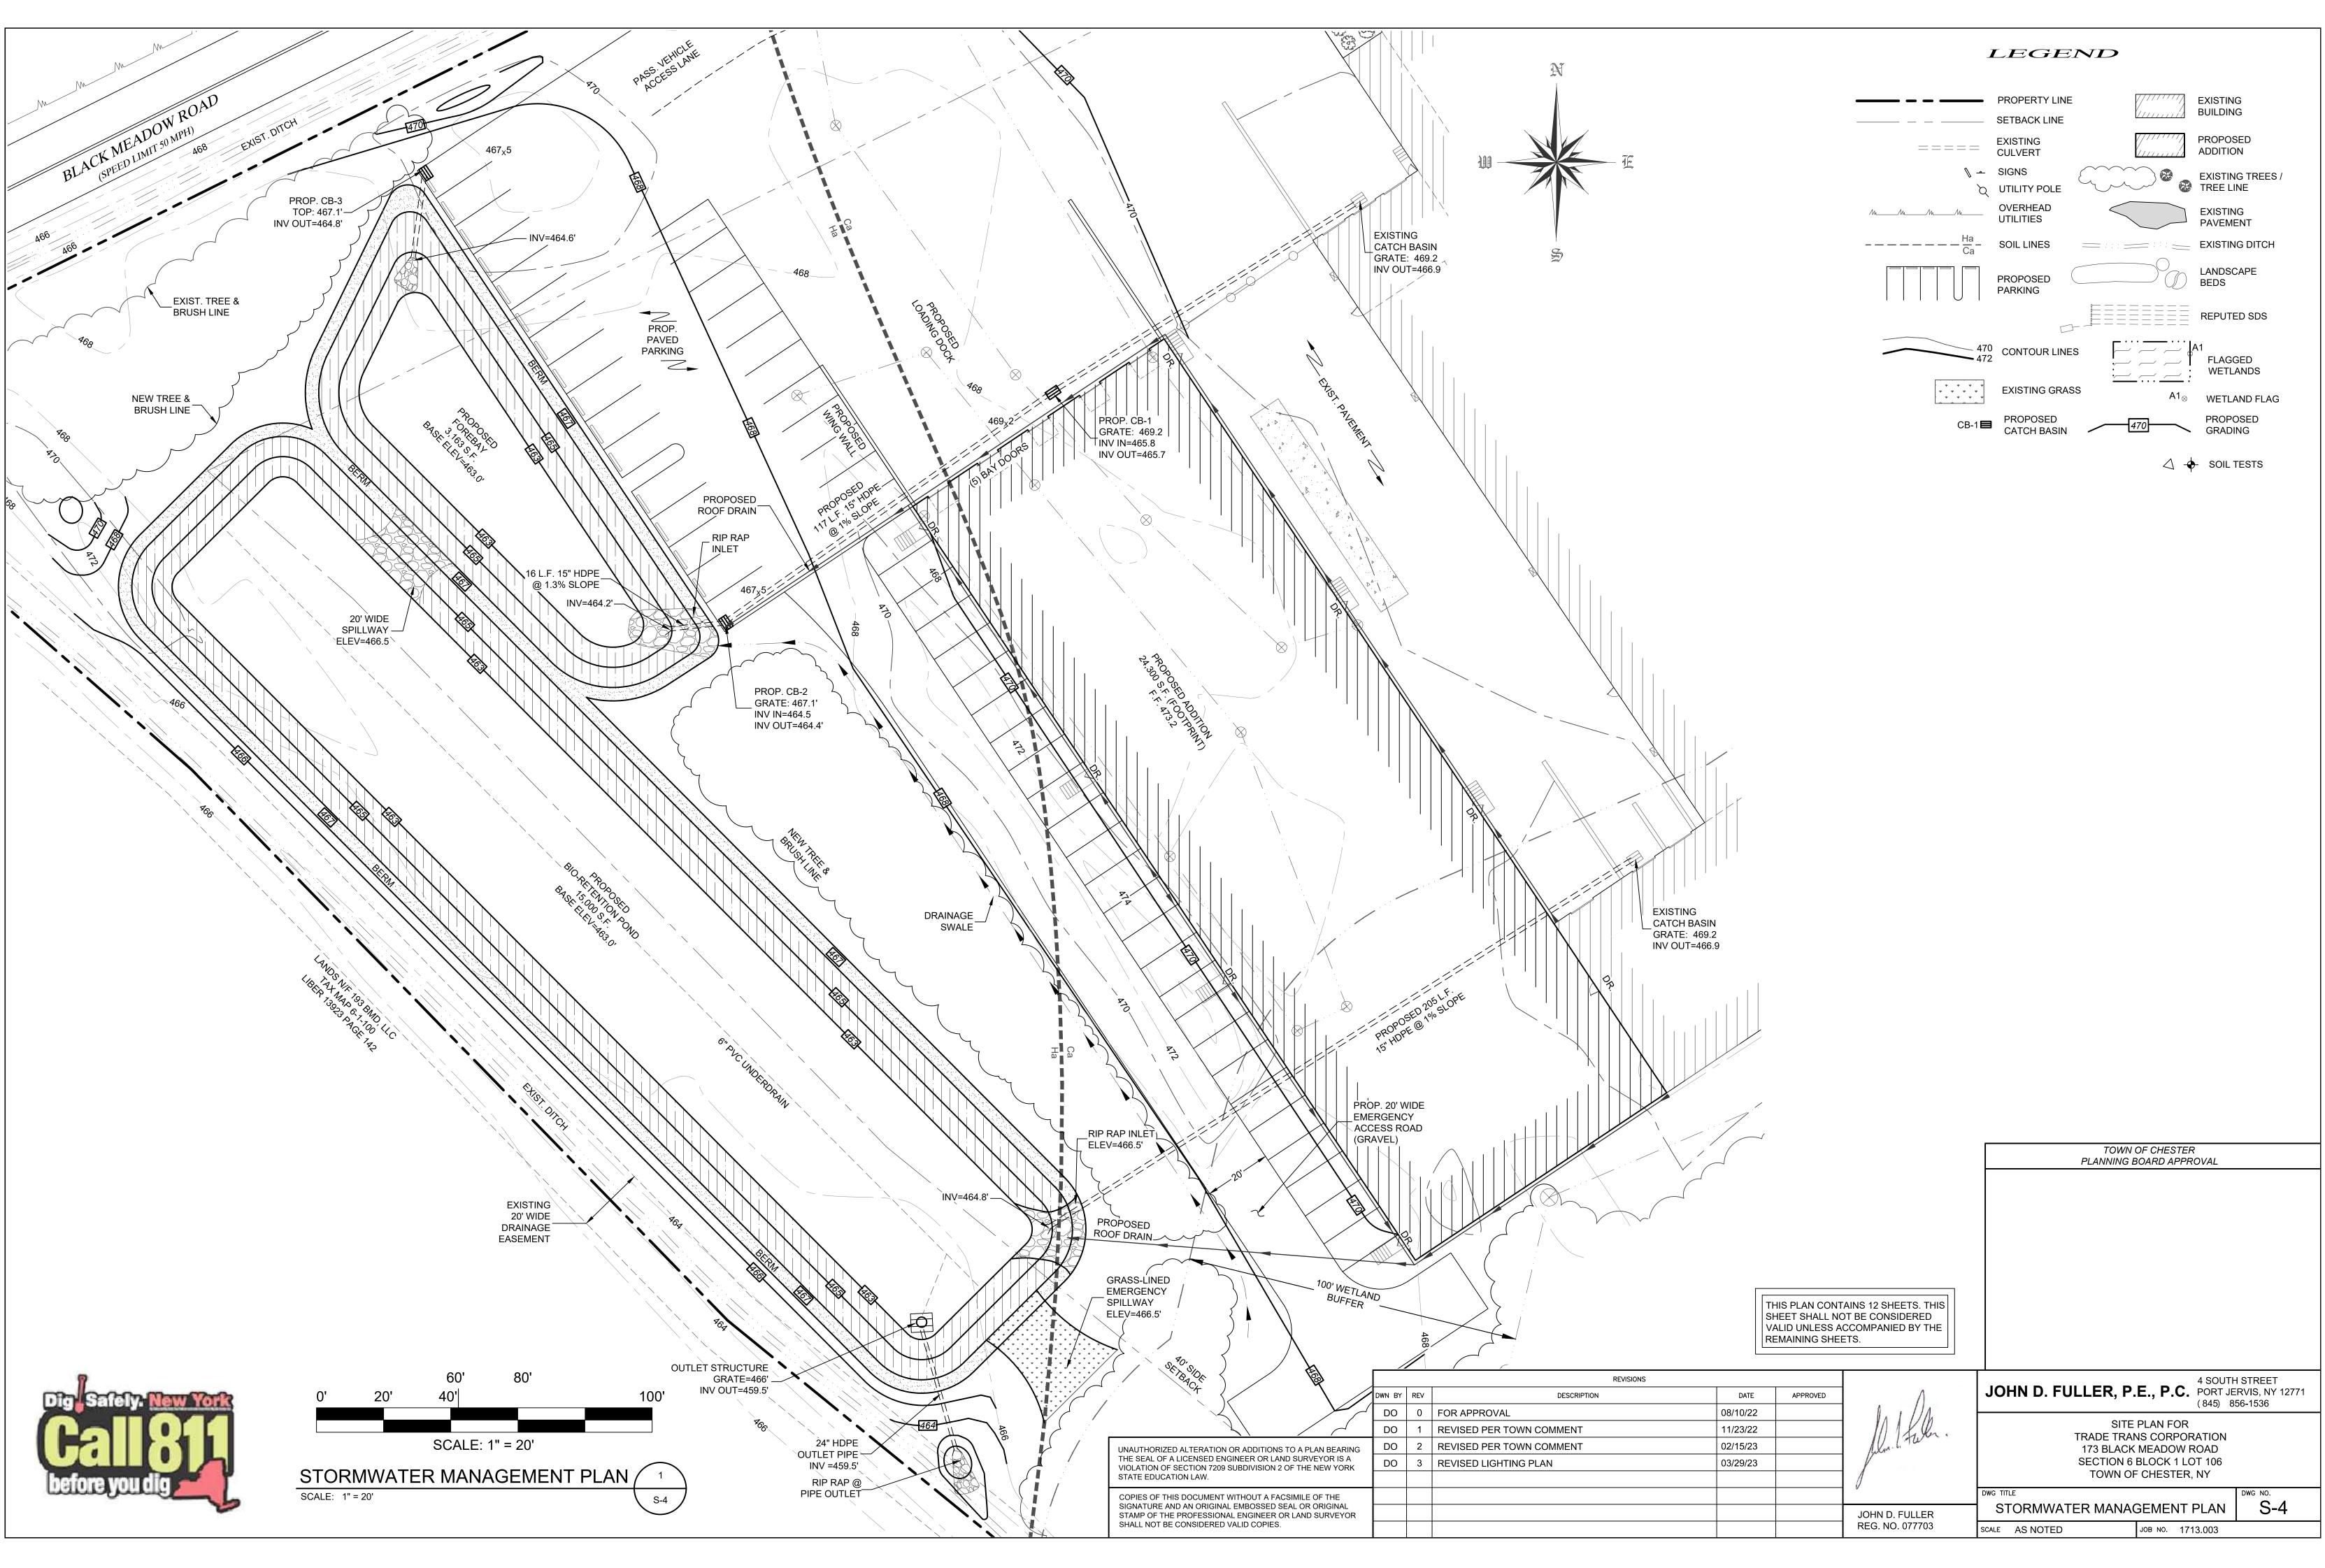


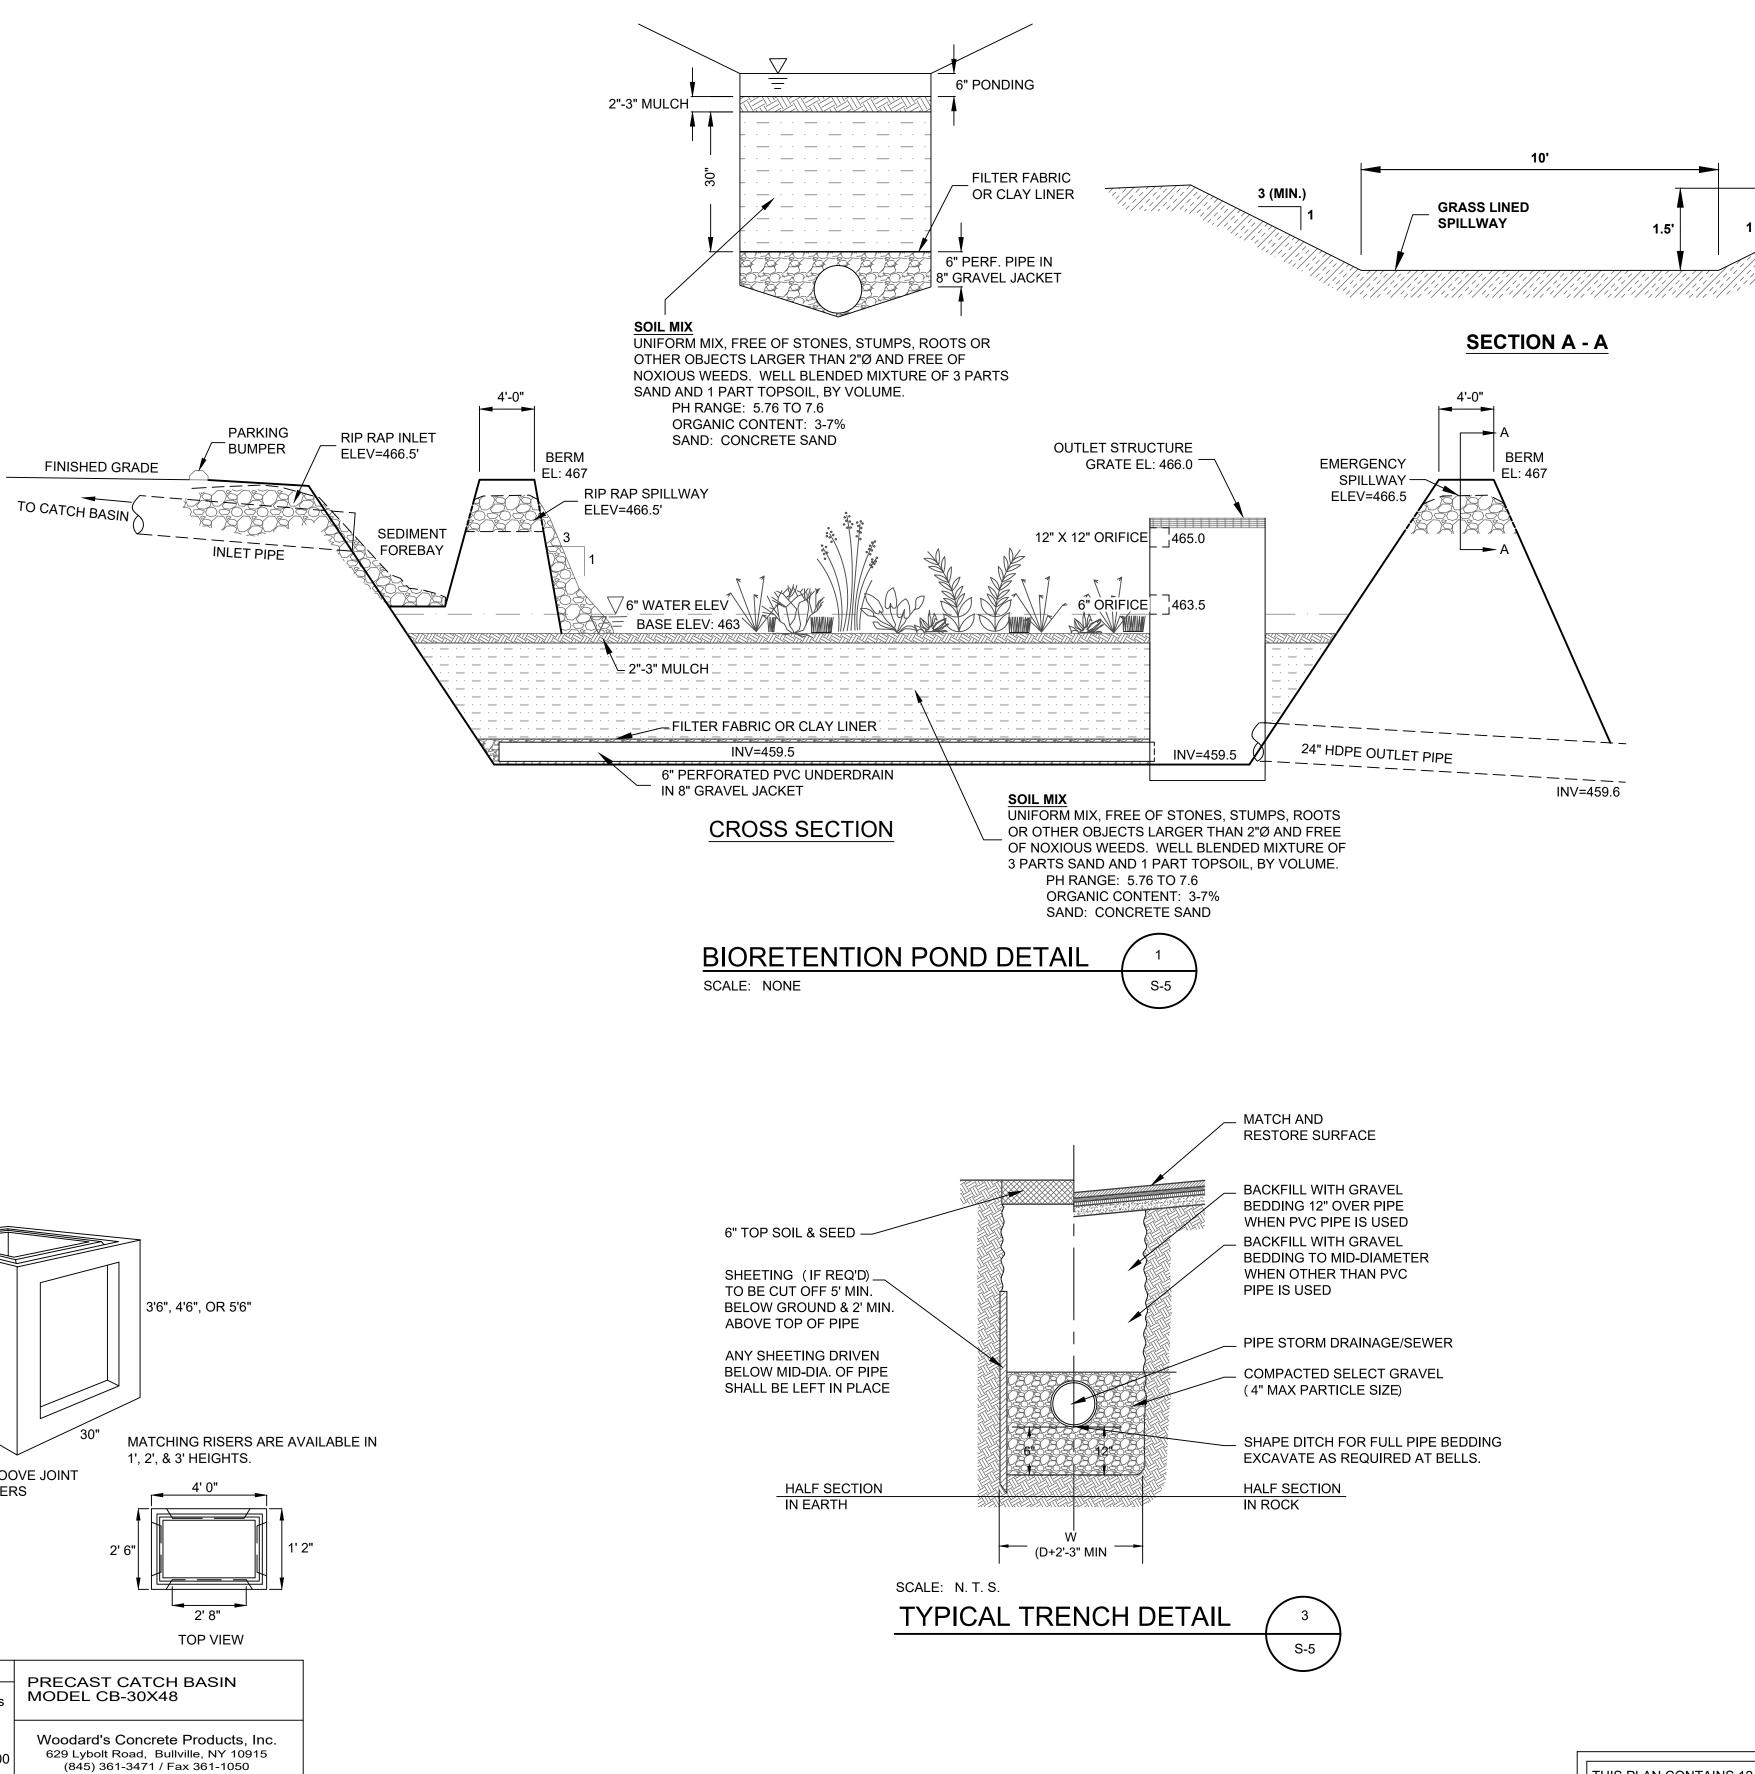

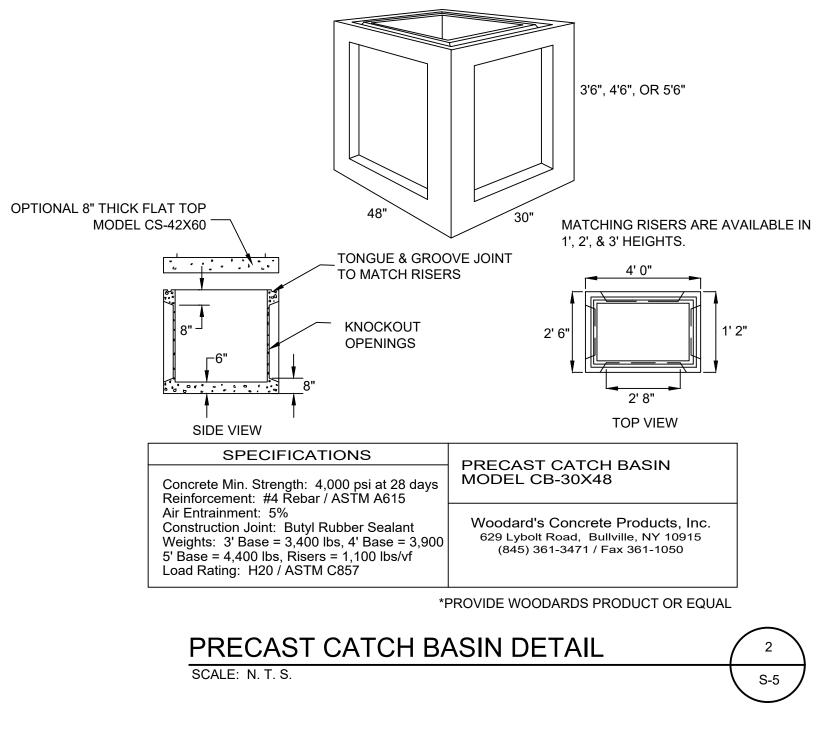

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				REVISION
		DWN BY	REV	DESCRIPTION
		DO	0	FOR APPROVAL
_		DO	1	REVISED PER TOWN COMMENT
UNAUTHORIZED	UNAUTHORIZED ALTERATION OR ADDITIONS TO A PLAN BEARING	DO	2	REVISED PER TOWN COMMENT
	THE SEAL OF A LICENSED ENGINEER OR LAND SURVEYOR IS A VIOLATION OF SECTION 7209 SUBDIVISION 2 OF THE NEW YORK	DO	3	REVISED LIGHTING PLAN
	STATE EDUCATION LAW.			
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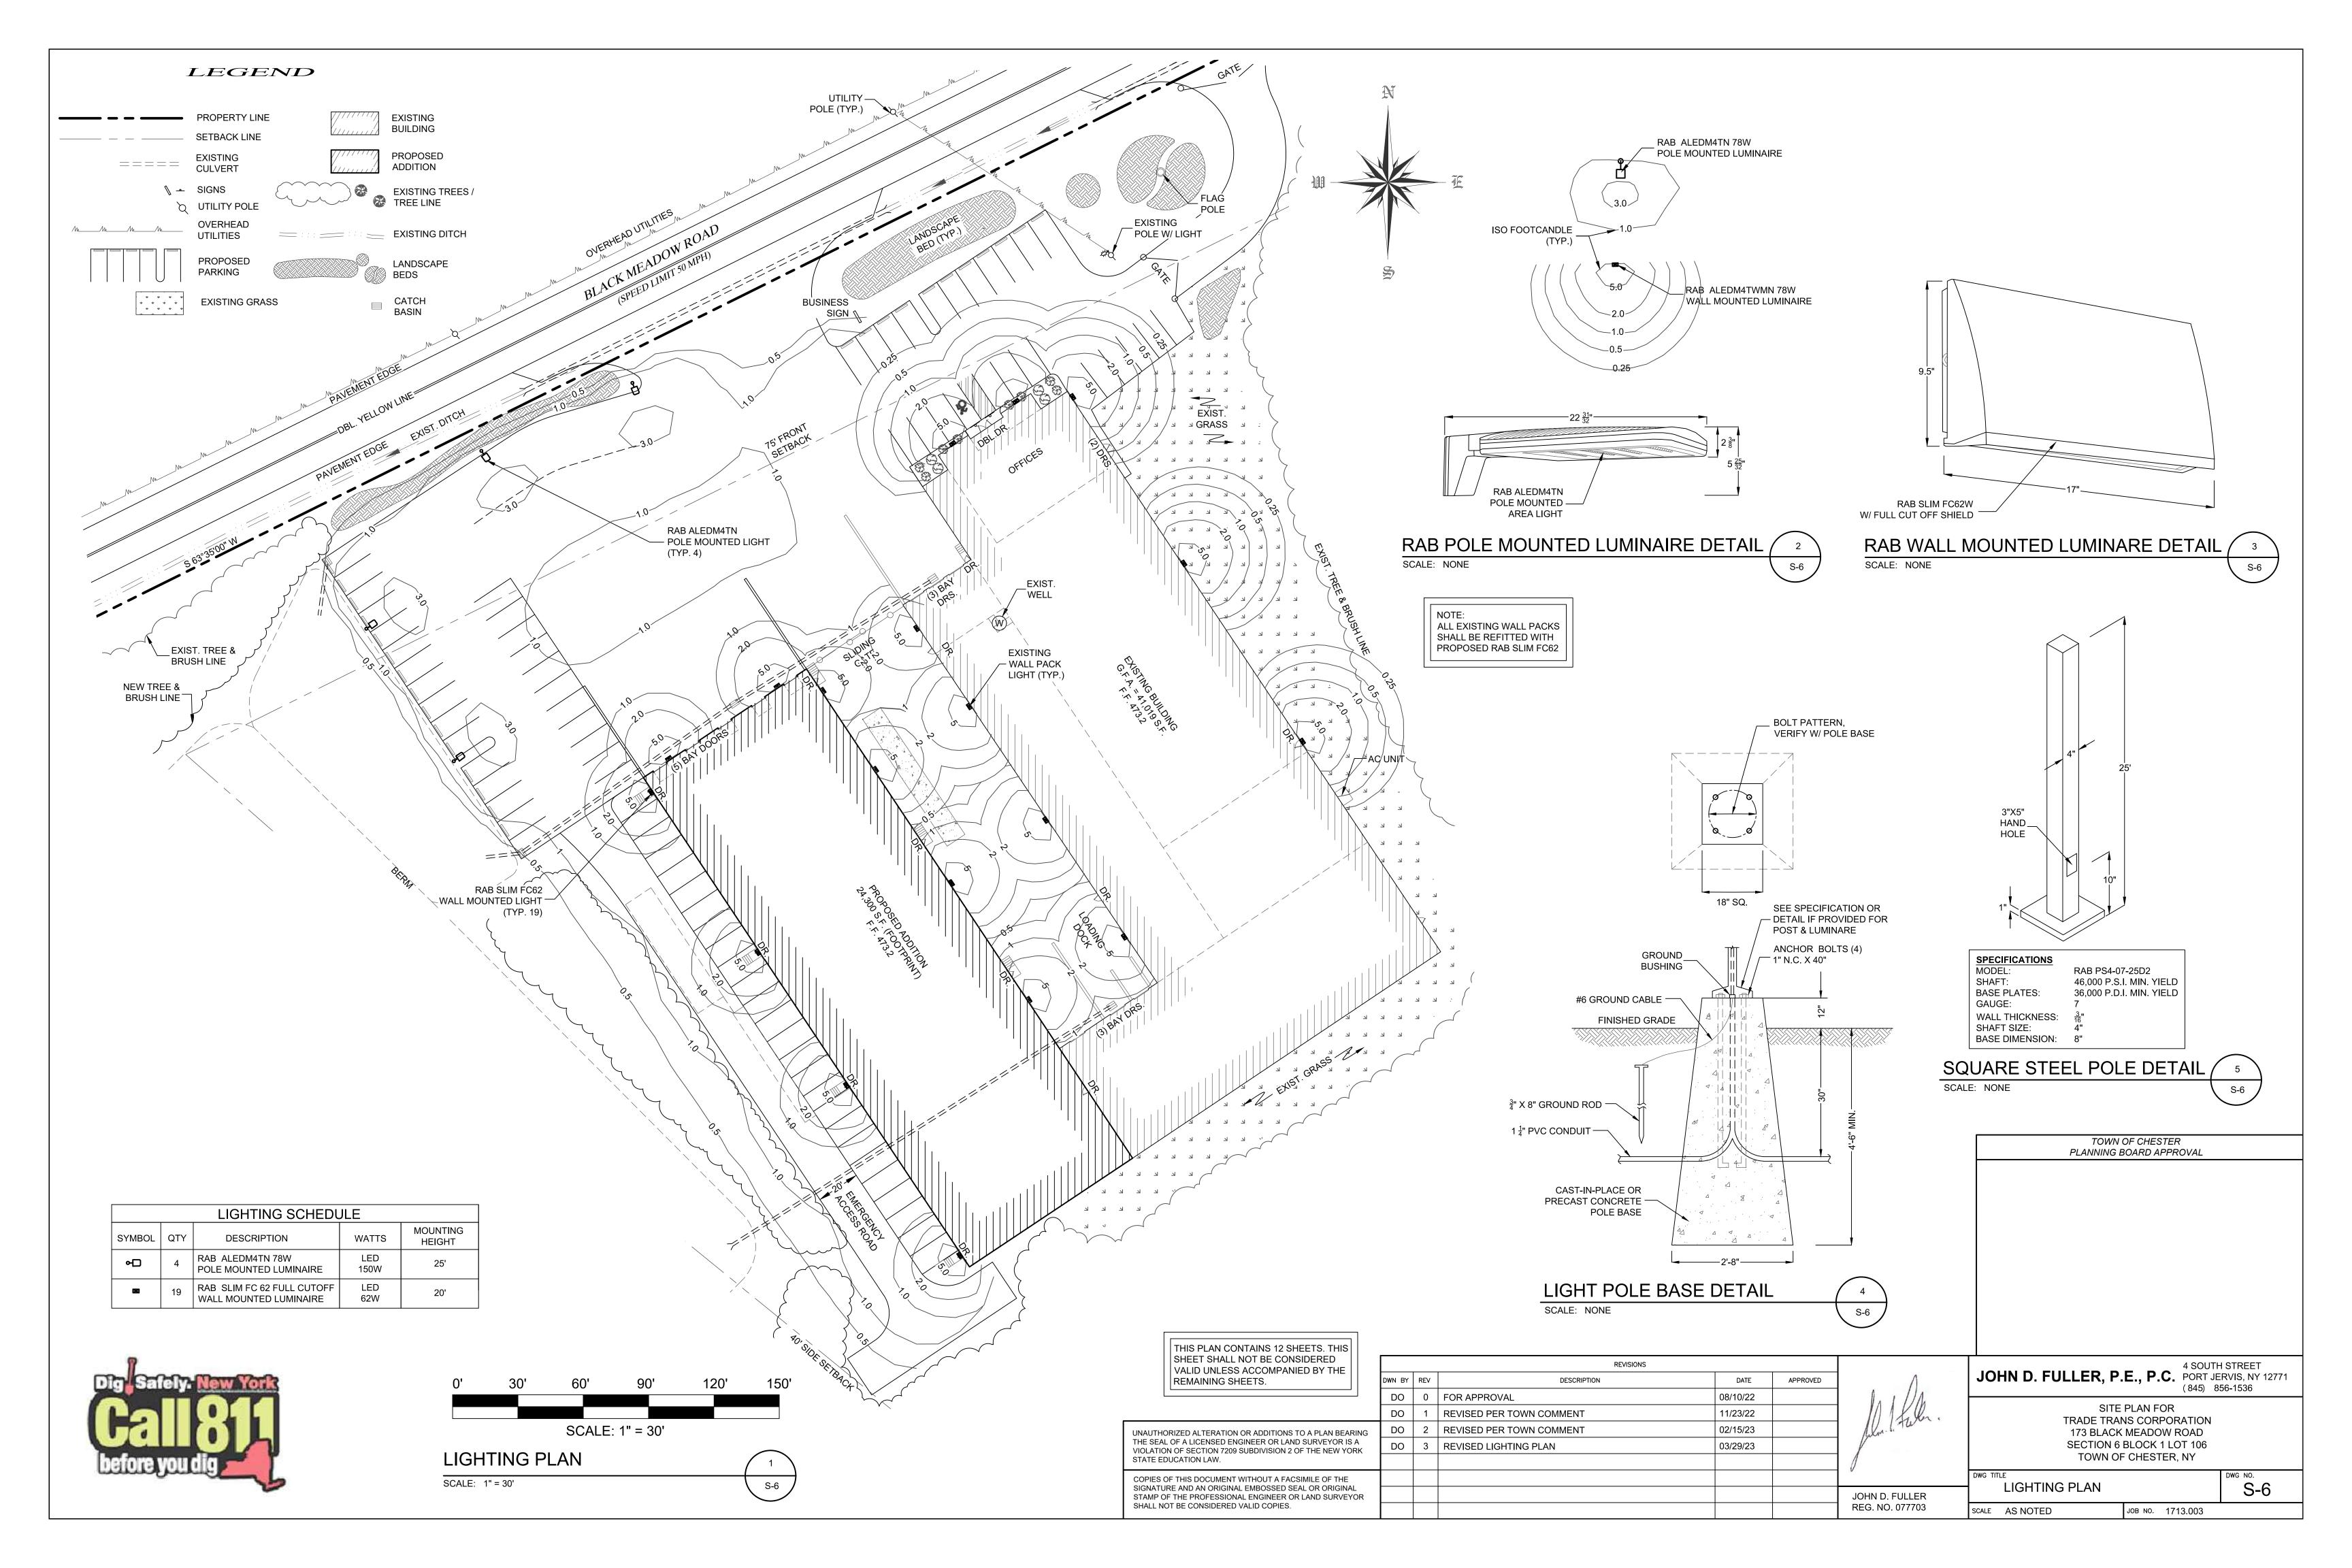
CONSTRUCTION SPECIFICATIONS:

3 (MIN.)

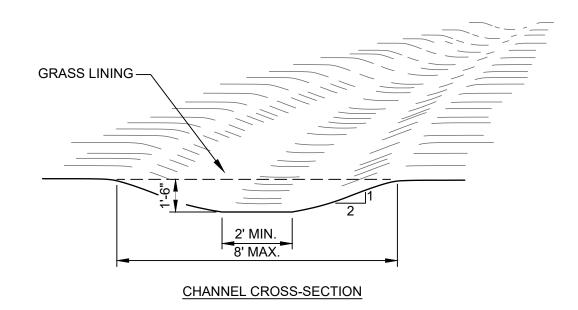- 1. ALL TREES, BRUSH, STUMPS, OBSTRUCTIONS AND OTHER OBJECTIONABLE SHALL BE REMOVED AND DISPOSED OF SO AS NOT TO INTERFERE WITH THE PROPER FUNCTIONING OF THE WATERWAY.
- 2. THE WATERWAY SHALL BE EXCAVATED OR SHAPED TO LINE, GRADE AND CROSS SECTION AS REQUIRED TO MEET THE CRITERIA SPECIFIED HEREIN, AND BE FREE OF BANK PROJECTIONS
- 3. ALL EARTH REMOVED AND NOT NEEDED IN CONSTRUCTION SHALL BE SPREAD OR DISPOSED OF SO THAT IT WILL NOT INTERFERE WITH THE FUNCTIONING OF THE WATERWAY. OR OTHER IRREGULARITIES WHICH WILL IMPEDE NORMAL FLOW.
- FILL SHALL BE COMPACTED AS NEEDED IN CONSTRUCTION TO PREVENT UNEQUAL SETTLEMENT THAT WOULD CAUSE DAMAGE IN THE COMPLETED WATERWAY.

VEGETATED SWALE DETAIL	4
SCALE: N. T. S.	S-5


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	DATE	APPROVED	Λ	JOHN D. FULLER, P.	E., P.C. 4 SOUTH PORT JE (845) 8	H STREET ERVIS, NY 12771 56-1536
	08/10/22		IN I VOD		PLAN FOR	
	02/15/23		Martituter.		NS CORPORATION MEADOW ROAD	
	03/29/23		1 million	SECTION 6	BLOCK 1 LOT 106	
			l l		F CHESTER, NY	
				DWG TITLE STORMWATER DE	TAILS	dwg no. S-5
			JOHN D. FULLER REG. NO. 077703			0-0
				SCALE AS NOTED	JOB NO. 1713.003	




- ADJACENT TO BUILDINGS.
- STORAGE OF EQUIPMENT. CONTRACTOR TO FIELD VERIFY ALL AREAS OF SEED.
- UNDESIRABLE MATERIAL. 4% ORGANIC MATTER PH 5.0 TO 6.5.


NAME OF GRASS	PROPORTION BY WT.	MIN. GERM.	MIN
PENNLAWN FESCUE	60%	85%	
FYIKING BLUEGRASS	30%	85%	


- WATER ALL LAWNS AND PLANTINGS UNTIL FINAL ACCEPTANCE BY THE OWNER.
- FROM THE LANDSCAPE ARCHITECT FOR THE TOWN.

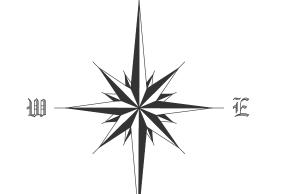

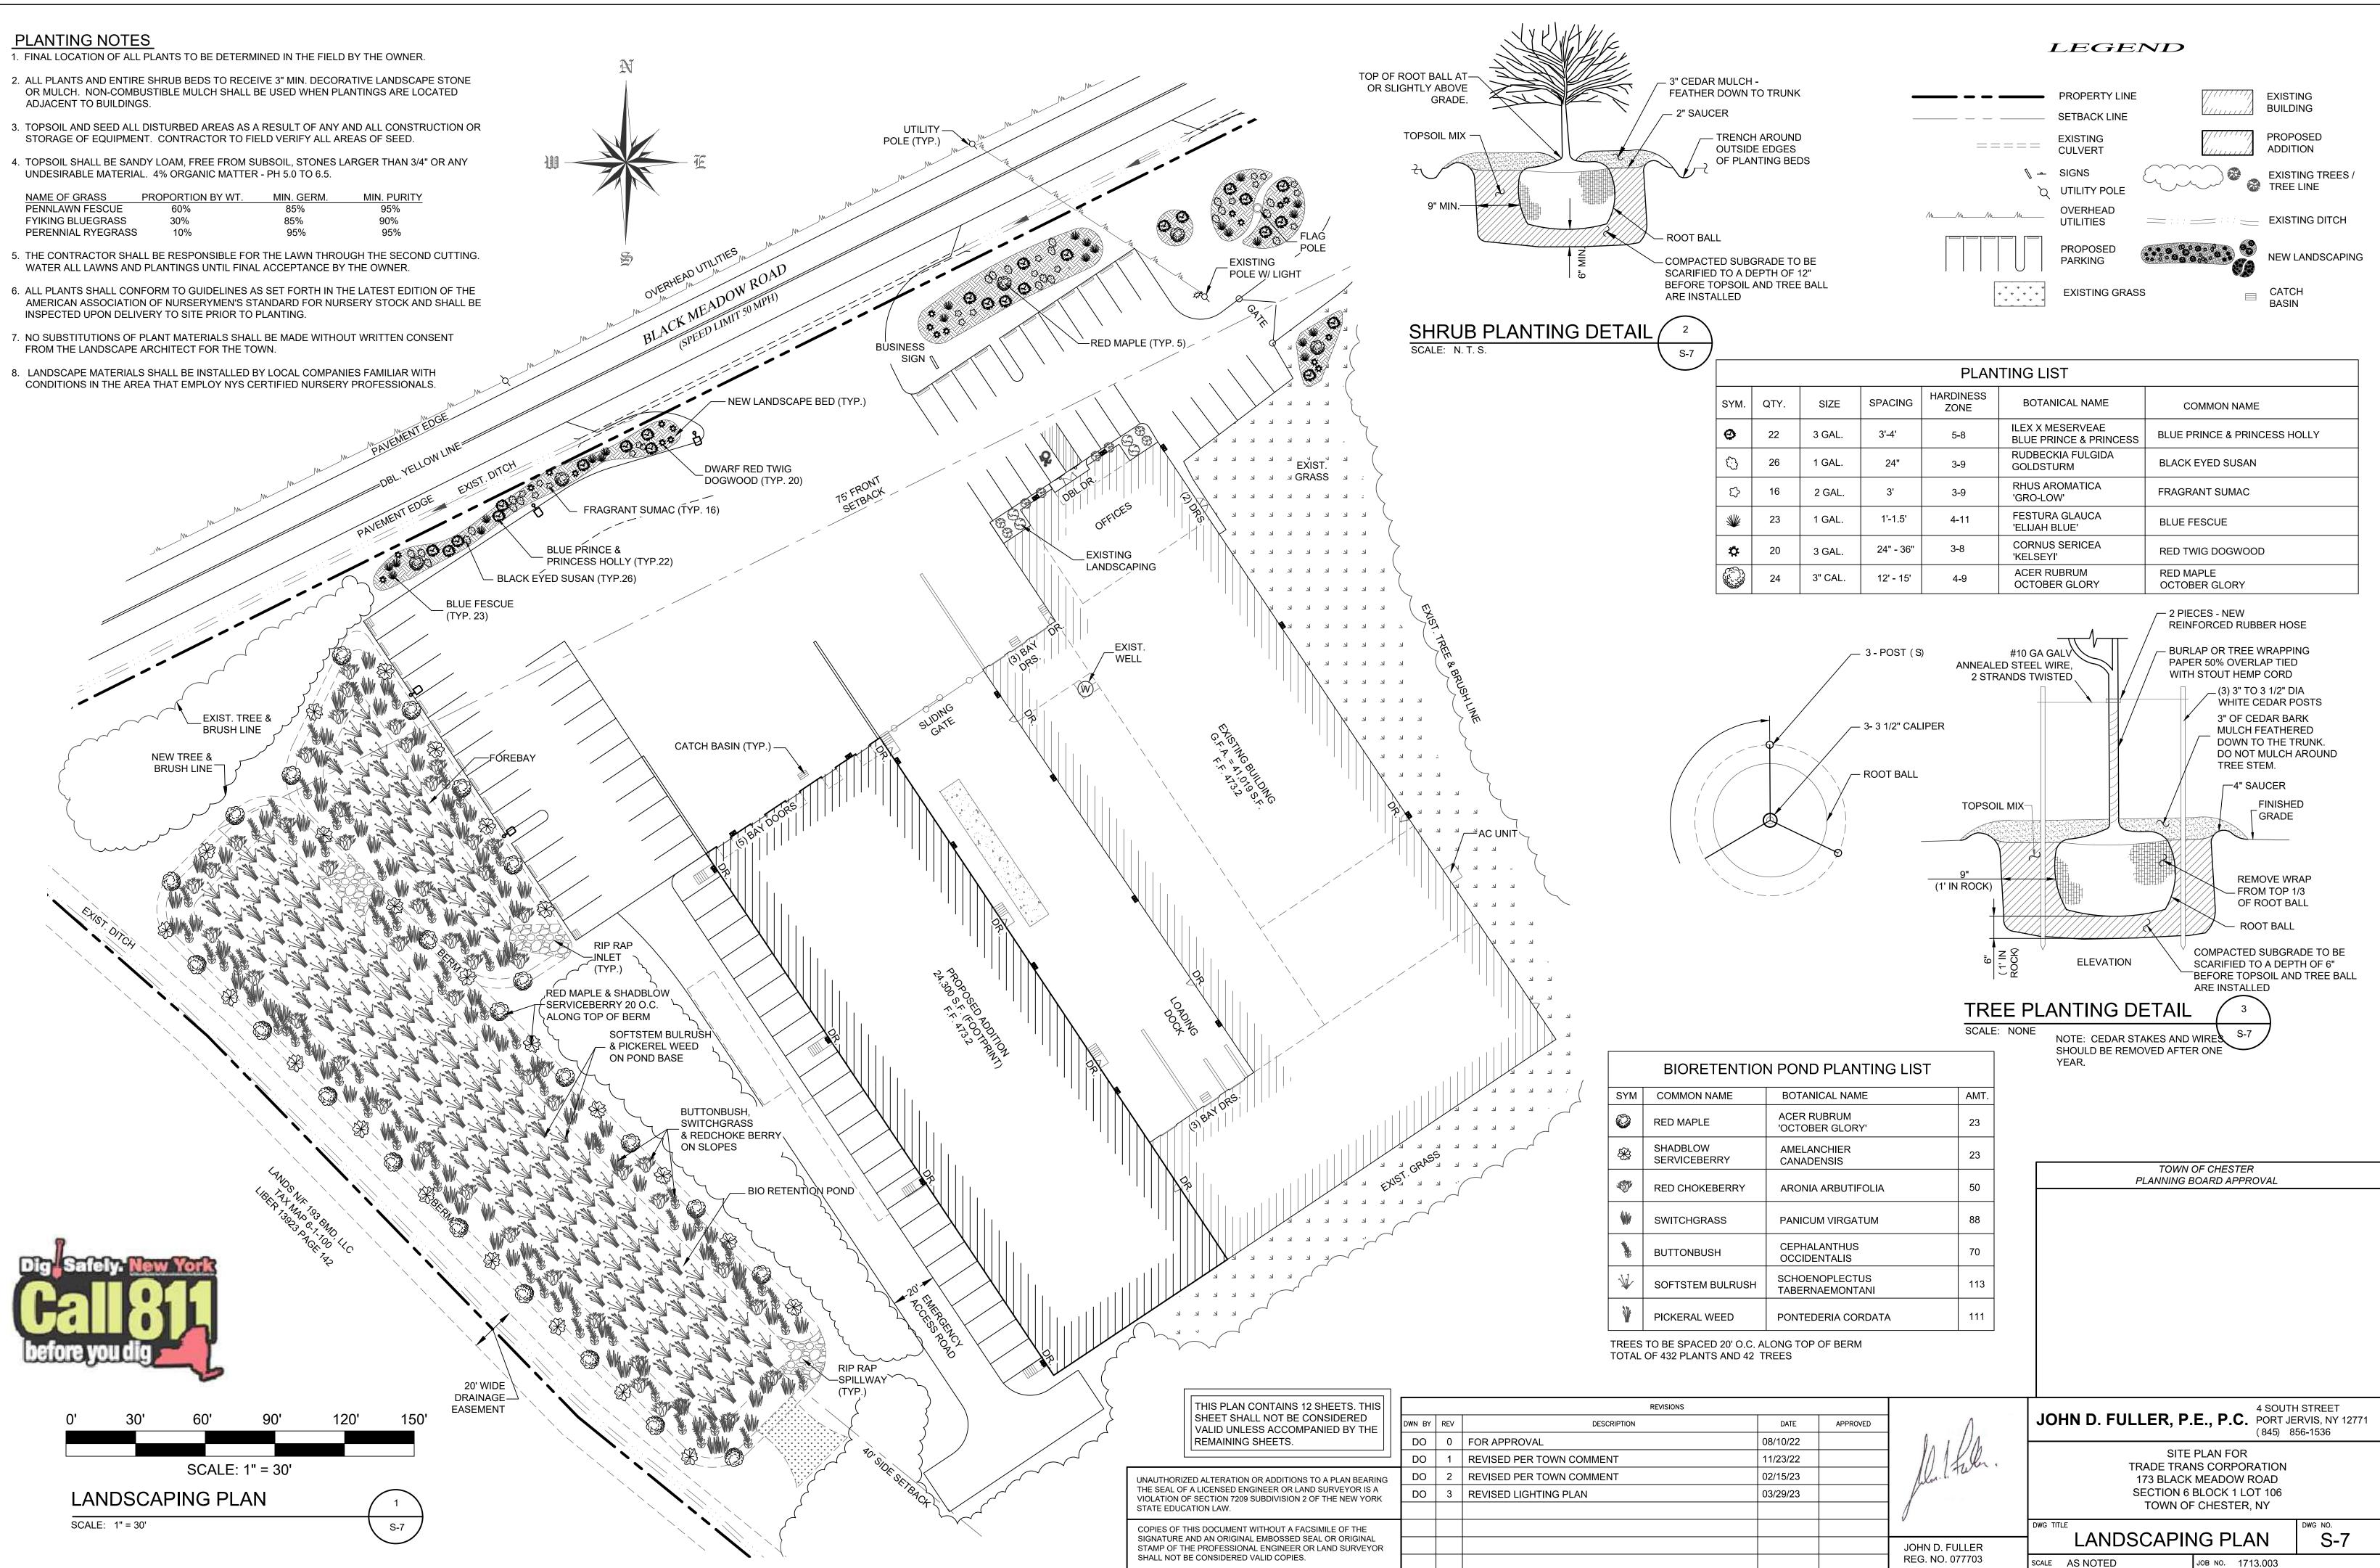

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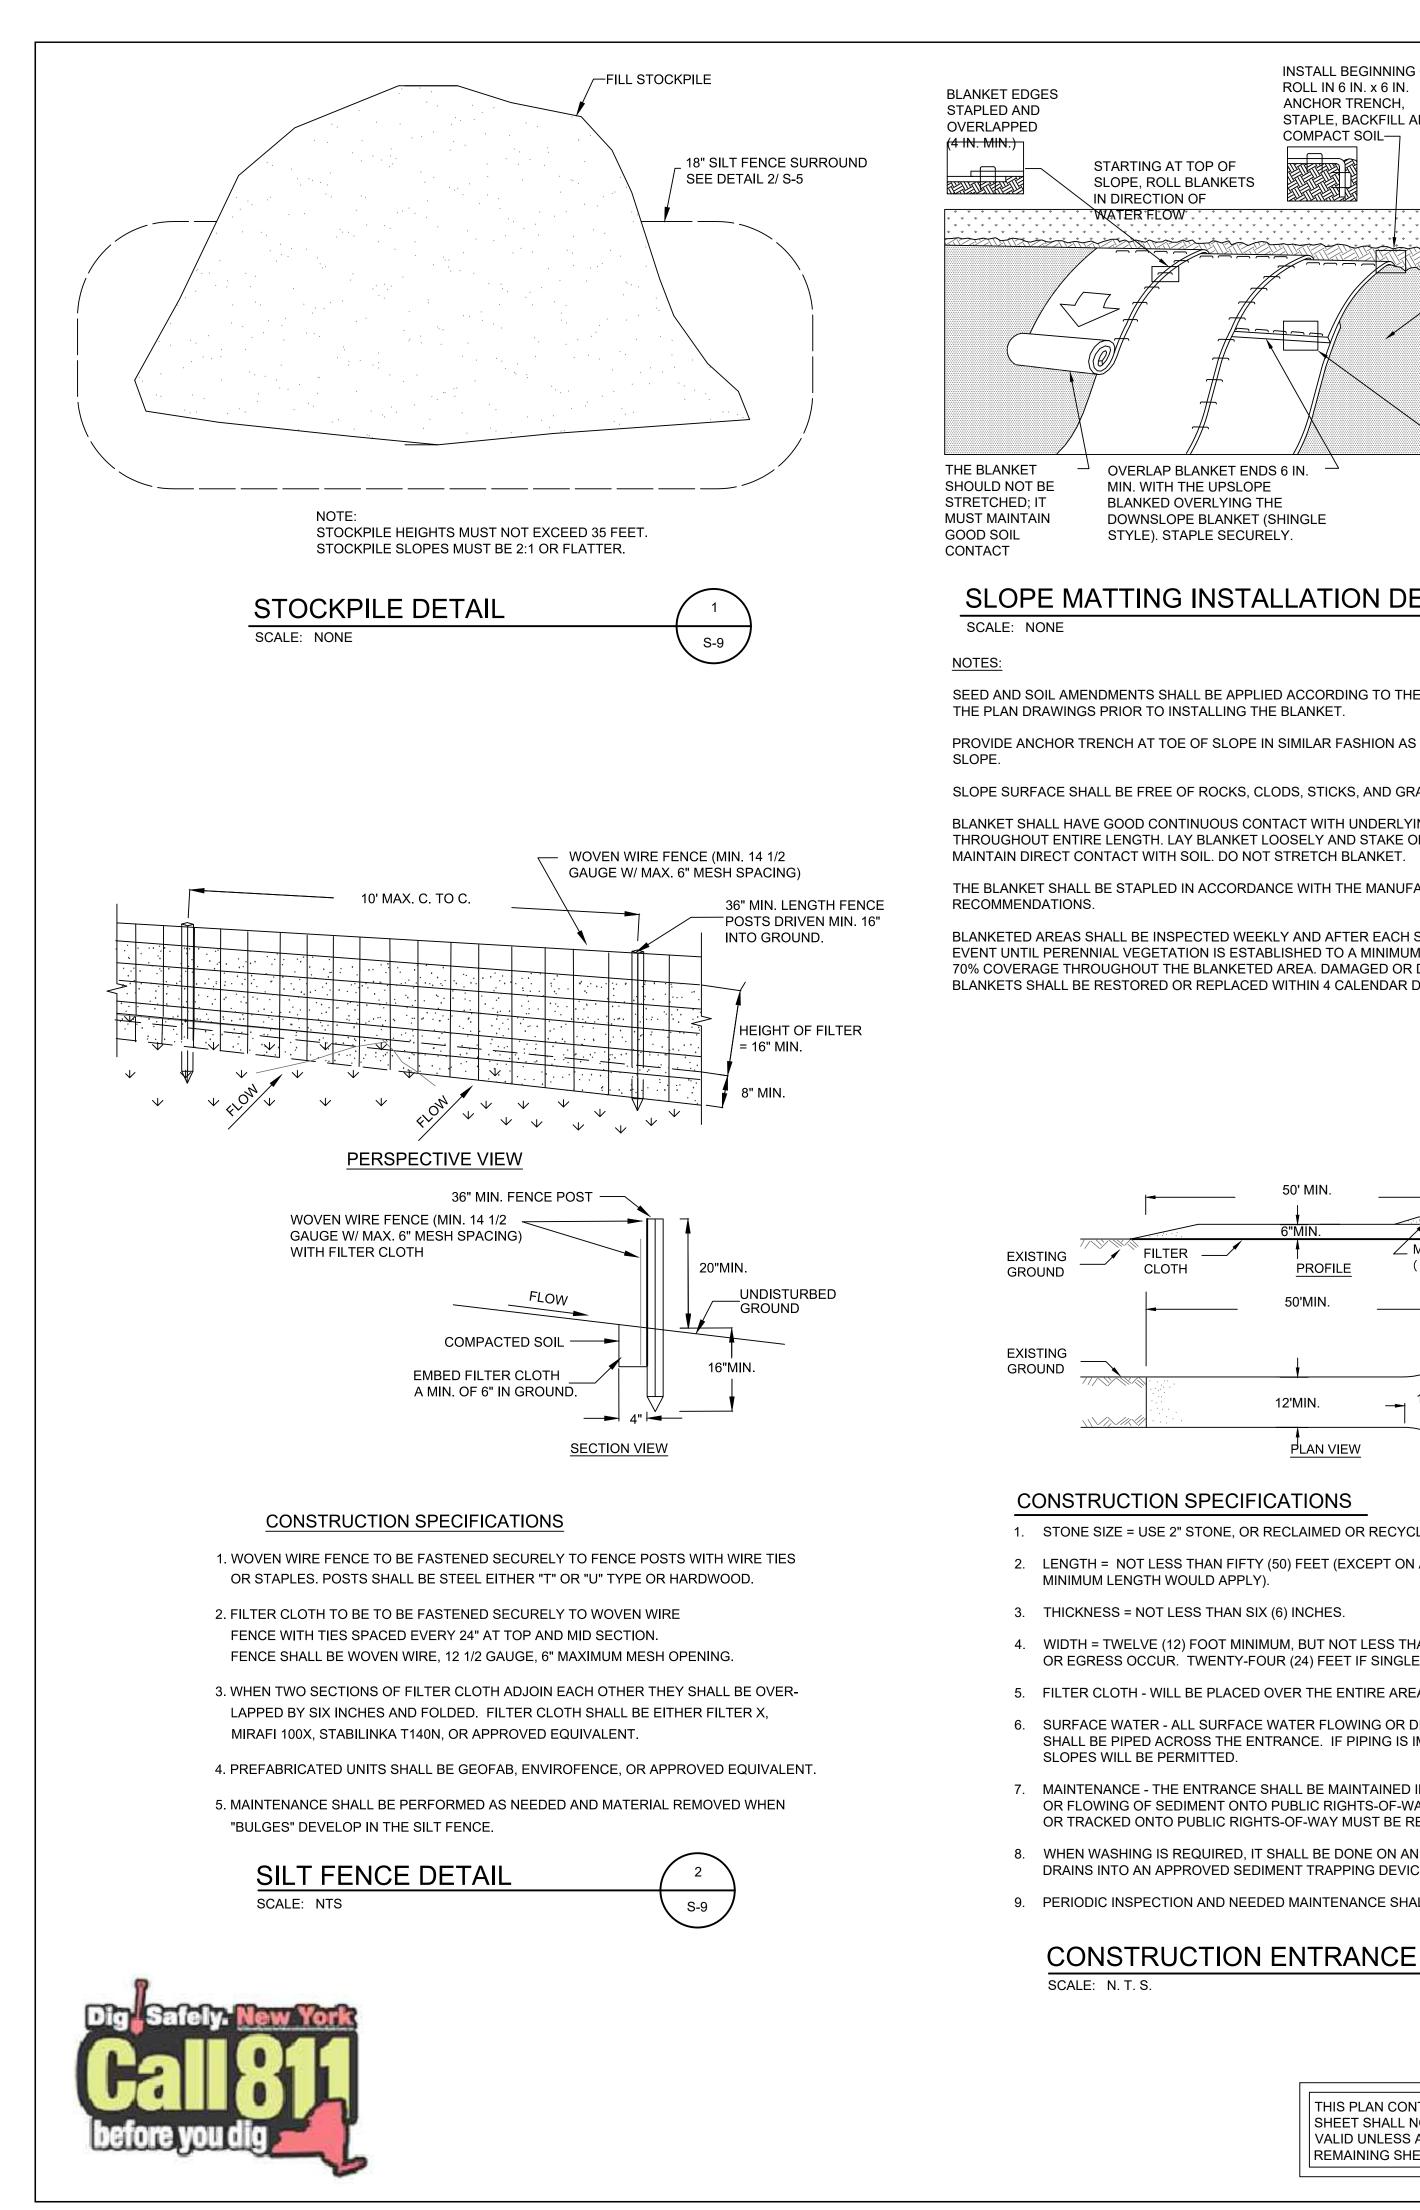


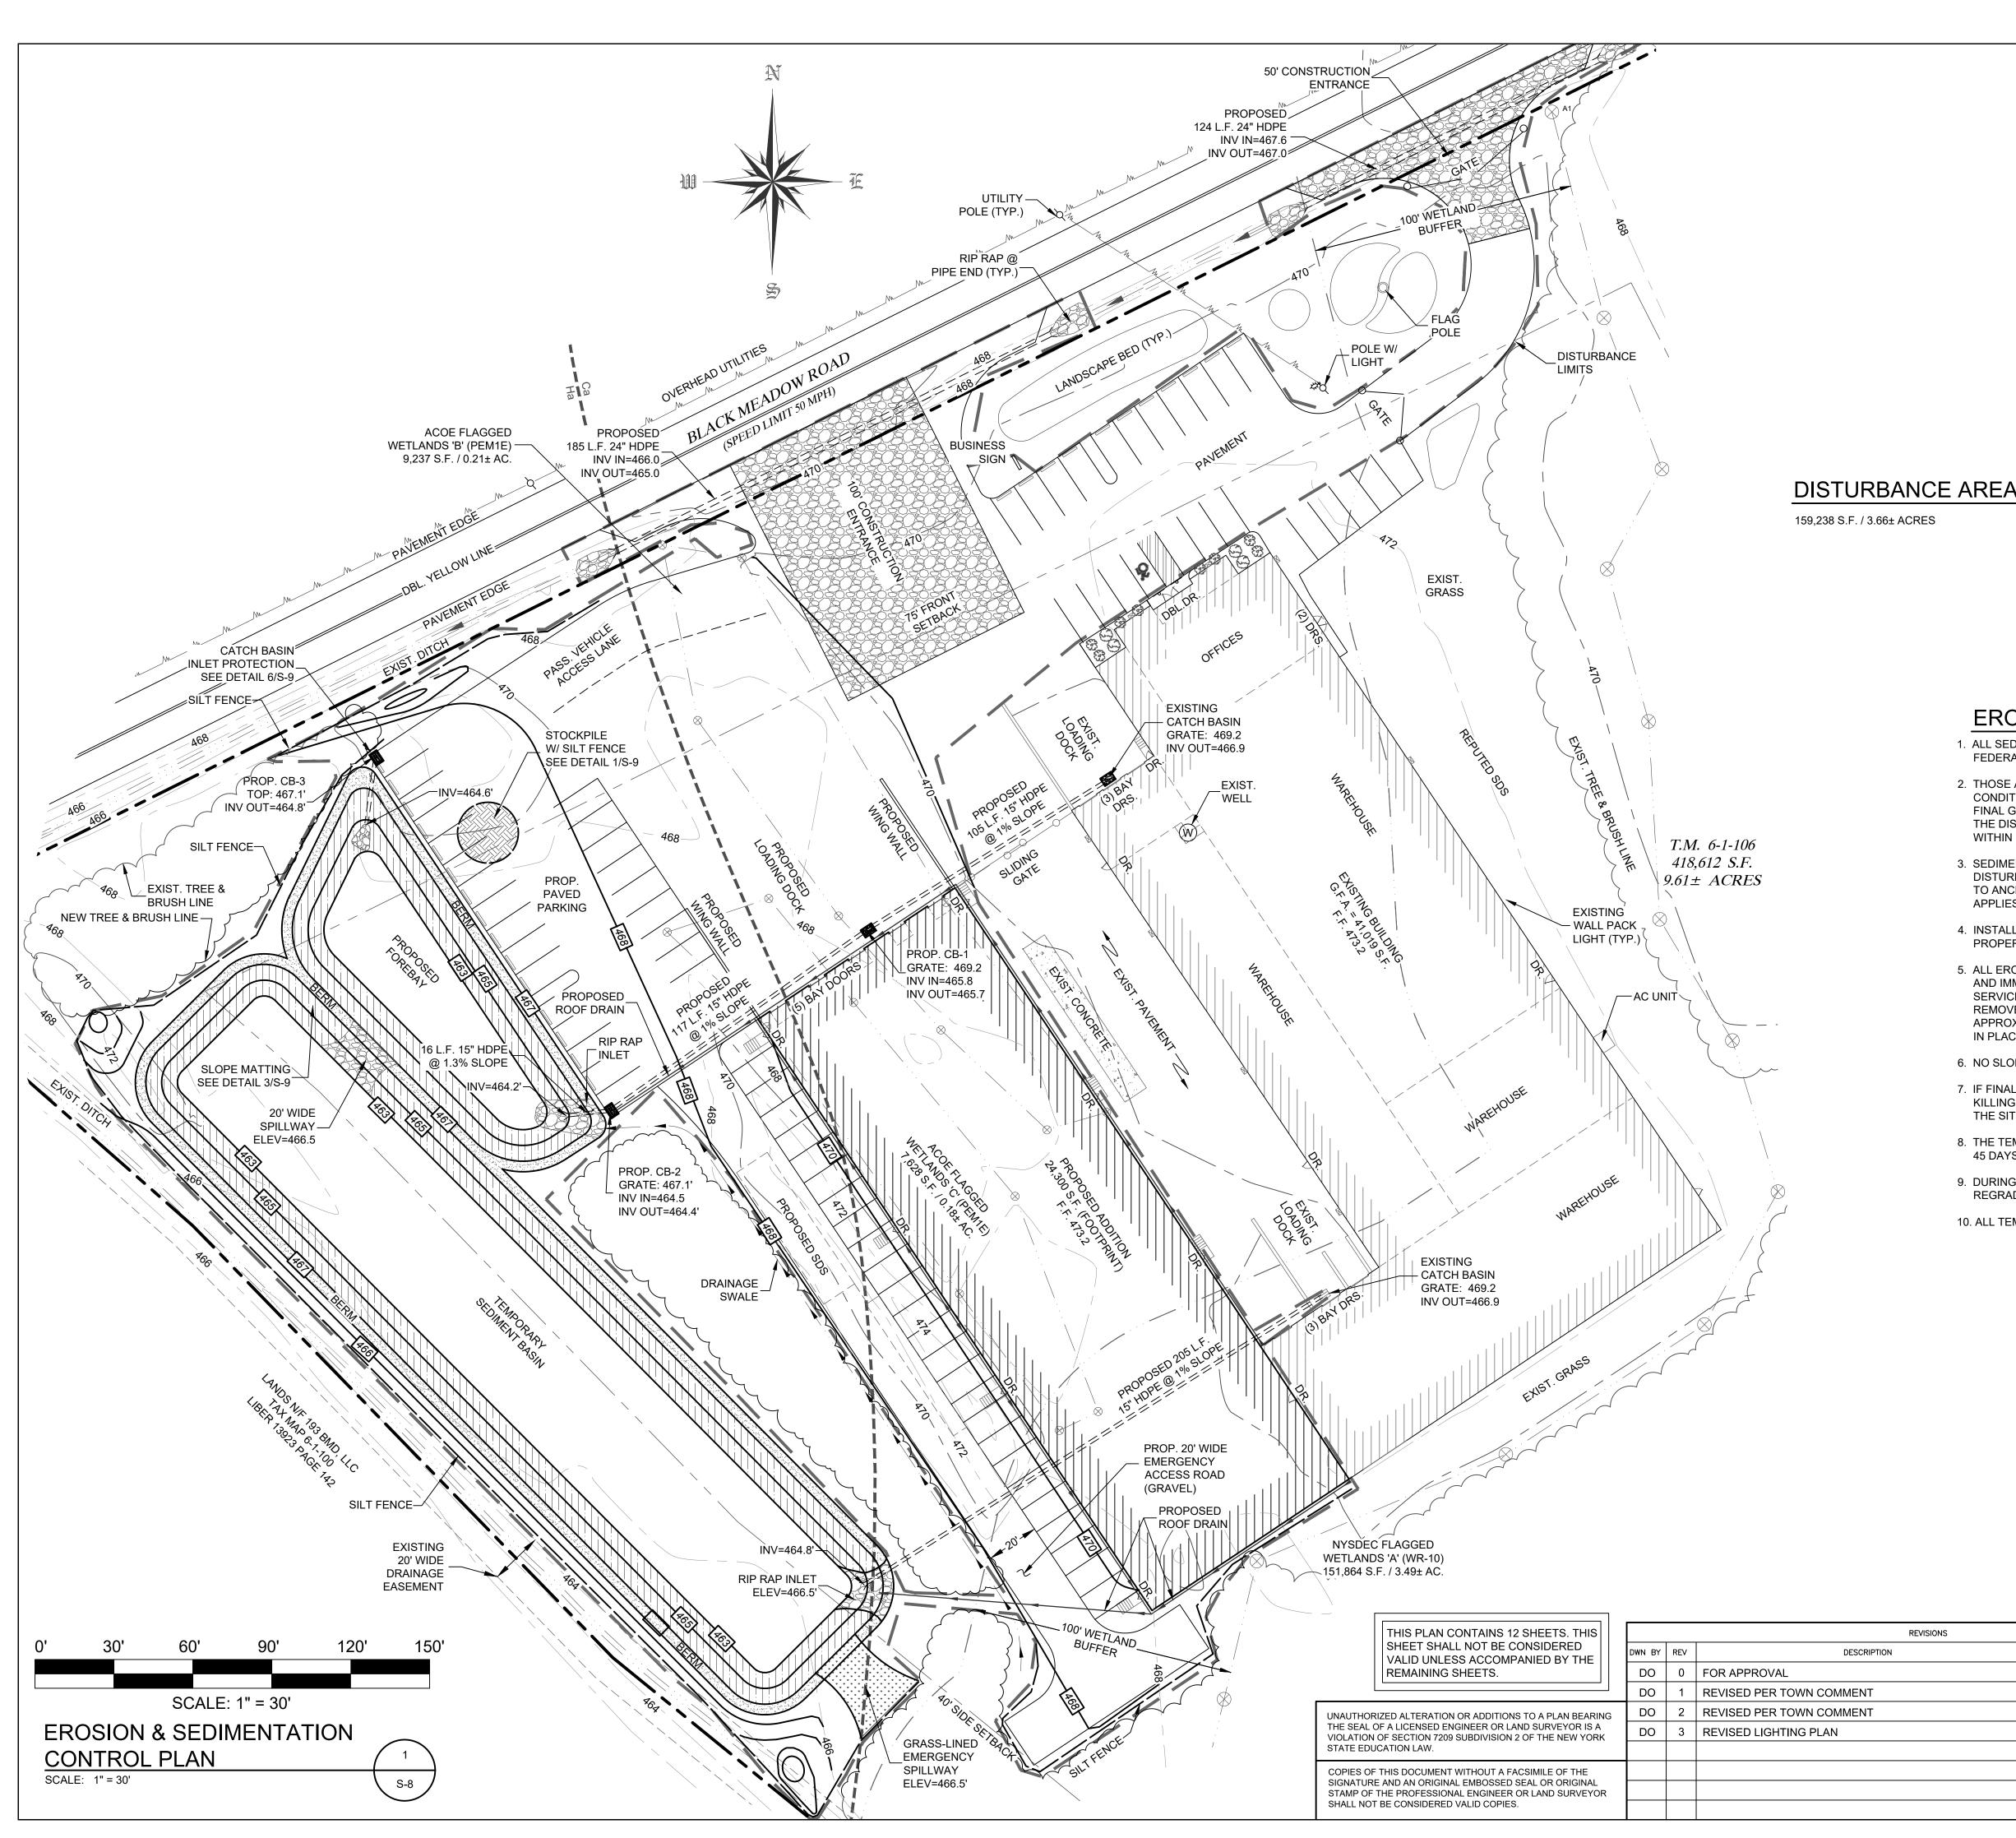


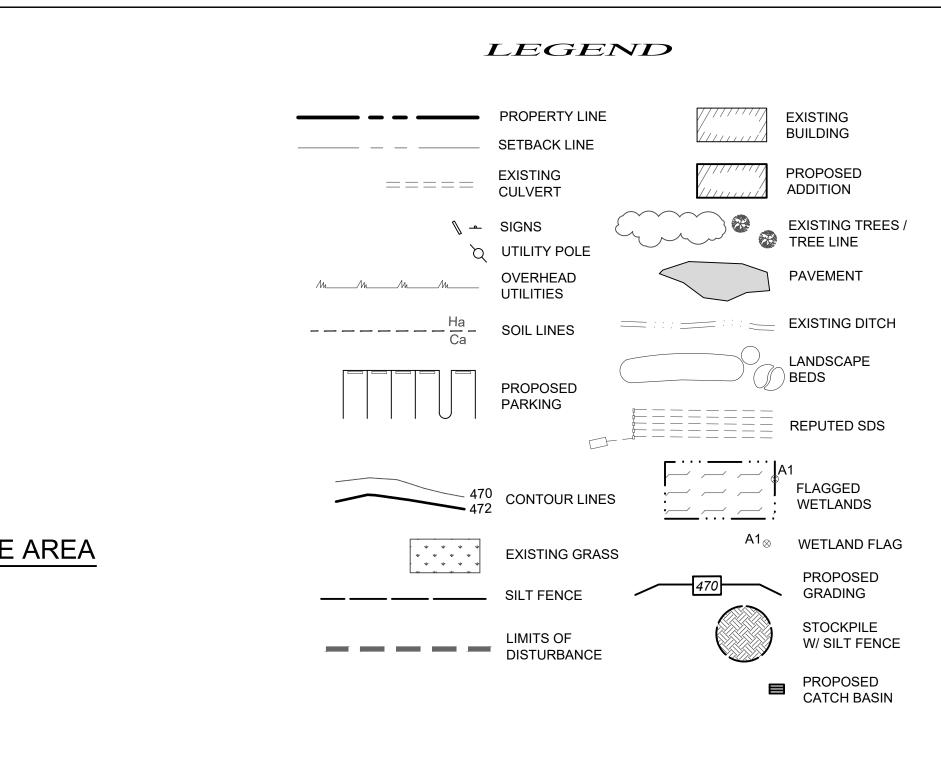EROSION & SEDIMENTATION CONTROL NOTES

- ALL SEDIMENT AND EROSION CONTROL MEASURES SHALL BE DONE IN ACCORDANCE WITH ANY AND ALL FEDERAL, STATE, AND LOCAL REGULATIONS.
- 2. THOSE AREAS UNDERGOING ACTUAL CONSTRUCTION WILL BE LEFT IN AN UNTREATED OR UNVEGETATED CONDITION FOR A MINIMUM TIME. AREAS SHALL BE PERMANENTLY STABILIZED WITHIN 15 DAYS OF FINAL GRADING AND TEMPORARY STABILIZED WITHIN 30 DAYS OF INITIAL DISTURBANCE OF THE SOIL IF THE DISTURBANCE IS WITHIN 100 FEET OF A STREAM OR POND. THE AREA SHALL BE STABILIZED WITHIN 7 DAYS OR PRIOR TO ANY STORM EVENT (THIS WOULD INCLUDE WETLANDS).
- 3. SEDIMENT BARRIERS (SILT FENCE, HAY BARRIERS, ETC.) SHOULD BE INSTALLED PRIOR TO ANY SOIL DISTURBANCE OF THE CONTRIBUTING DRAINAGE AREA ABOVE THEM. MULCH NETTING SHALL BE USED TO ANCHOR MULCH IN ALL AREAS WITH SLOPES GREATER THAN 15% AFTER OCTOBER 1ST THE SAME APPLIES FOR ALL SLOPES GREATER THAN 8%.
- 4. INSTALL SILT FENCE AT TOE OF SLOPE TO FILTER SILT FROM RUNOFF. SEE SILT FENCE DETAIL FOR PROPER INSTALLATION. SILT FENCE WILL REMAIN IN PLACE PER NOTE #5.
- 5. ALL EROSION CONTROL STRUCTURES WILL BE INSPECTED, REPLACED AND/OR REPAIRED EVERY 7 DAYS AND IMMEDIATELY FOLLOWING ANY SIGNIFICANT RAINFALL OR SNOW MELT OR WHEN NO LONGER SERVICEABLE DUE TO SEDIMENT ACCUMULATION OR DECOMPOSURE. SEDIMENT DEPOSITS SHOULD BE REMOVED AFTER EACH STORM EVENT. THEY MUST BE REMOVED WHEN DEPOSITS REACH APPROXIMATELY ONE HALF THE HEIGHT OF THE BARRIER. SEDIMENT CONTROL DEVICES SHALL REMAIN IN PLACE AND BE MAINTAINED BY THE CONTRACTOR UNTIL AREAS UPSLOPE ARE STABILIZED BY TURF.
- 6. NO SLOPES, EITHER PERMANENT OR TEMPORARY, SHALL BE STEEPER THAN TWO TO ONE (2 TO 1).
- 7. IF FINAL SEEDING OF THE DISTURBED AREAS IS NOT COMPLETED 45 DAYS PRIOR TO THE FIRST KILLING FROST USE TEMPORARY MULCH (DORMANT SEEDING MAY BE ATTEMPTED AS WELL) TO PROTECT THE SITE AND DELAY SEEDING UNTIL THE NEXT RECOMMENDED SEEDING PERIOD.
- 8. THE TEMPORARY SEEDING OF DISTURBED AREAS THAT HAVE NOT BEEN FINAL GRADED SHALL BE COMPLETED 45 DAYS PRIOR TO THE FIRST KILLING FROST TO PROTECT FROM SPRING RUNOFF PROBLEMS.
- 9. DURING THE CONSTRUCTION PHASE, INTERCEPTED SEDIMENT WILL BE RETURNED TO SITE AND REGRADED ONTO OPEN AREAS.
- 10. ALL TEMPORARY EROSION CONTROL MEASURES SHALL BE REMOVED ONCE THE SITE IS STABILIZED.

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NS				JOHN D. FULLER, F		H STREET
	ATE	APPROVED	Λ	JOHN D. FULLER, I	(845) 8	356-1536
08/10/			In I UM	SIT	E PLAN FOR	
11/23			fuln.		ANS CORPORATION	
02/15/			fulm. 6.		K MEADOW ROAD	
03/29/	/23				6 BLOCK 1 LOT 106 DF CHESTER, NY	
			Ű			
				DWG TITLE EROSION & SED	IMENTATION	DWG NO.
			JOHN D. FULLER	CONTROL PLAN S-8		
			REG. NO. 077703	SCALE AS NOTED	JOB NO. 1713.003	



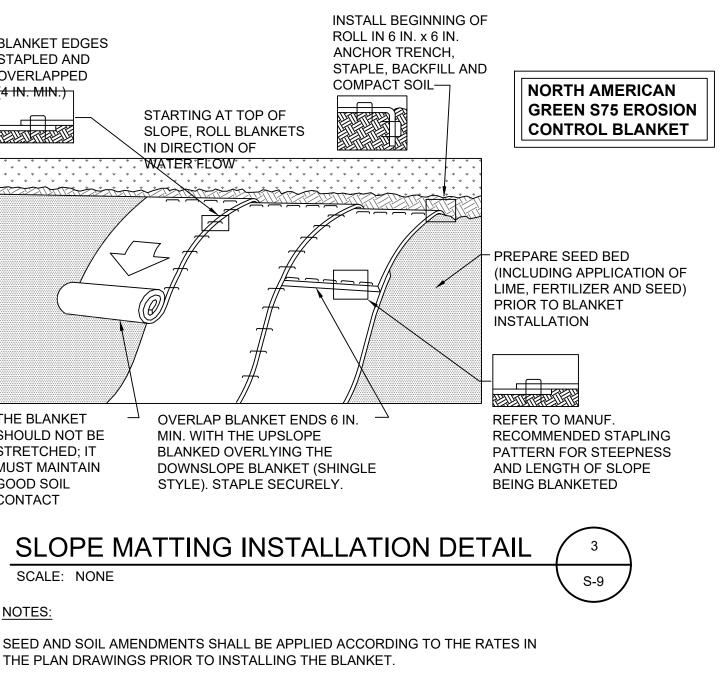


PROVIDE ANCHOR TRENCH AT TOE OF SLOPE IN SIMILAR FASHION AS AT TOP OF

SLOPE SURFACE SHALL BE FREE OF ROCKS, CLODS, STICKS, AND GRASS.

BLANKET SHALL HAVE GOOD CONTINUOUS CONTACT WITH UNDERLYING SOIL THROUGHOUT ENTIRE LENGTH. LAY BLANKET LOOSELY AND STAKE OR STAPLE TO MAINTAIN DIRECT CONTACT WITH SOIL. DO NOT STRETCH BLANKET.

THE BLANKET SHALL BE STAPLED IN ACCORDANCE WITH THE MANUFACTURER'S


BLANKETED AREAS SHALL BE INSPECTED WEEKLY AND AFTER EACH STORMWATER EVENT UNTIL PERENNIAL VEGETATION IS ESTABLISHED TO A MINIMUM UNIFORM 70% COVERAGE THROUGHOUT THE BLANKETED AREA. DAMAGED OR DISPLACED BLANKETS SHALL BE RESTORED OR REPLACED WITHIN 4 CALENDAR DAYS.

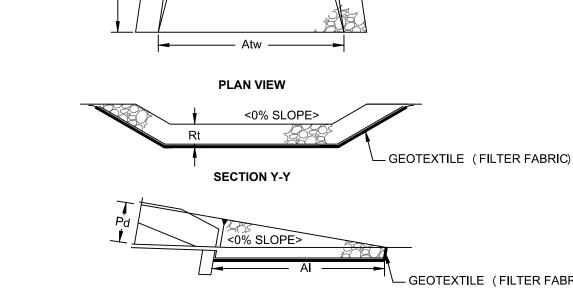

Aiw

SECTION Z-Z						
		RIP	RAP		APRON	
	PIPE				INITIAL	TERMINAL
	DIA		THICK.	LENGTH	WIDTH	WIDTH
OUTLET	Pd	SIZE	Rt	AI	Aiw	Atw
NO.	(IN)	(R)	(IN)	(FT)	(FT)	(FT)
1	15	4	6	12	3	10
-	-	-	-	-	-	-
-	-	-	-	-	-	-

RIP RAP APRON AT PIPE OUTLET SCALE: N. T. S.

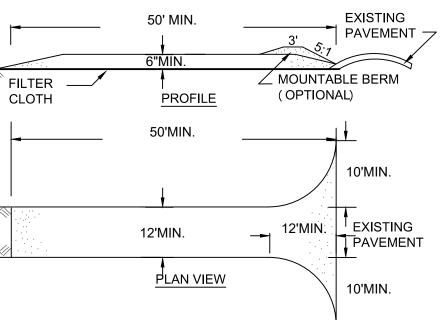

CONSTRUCTION SPECIFICATIONS

1. STONE SIZE = USE 2" STONE, OR RECLAIMED OR RECYCLED CONCRETE EQUIVALENT.

2. LENGTH = NOT LESS THAN FIFTY (50) FEET (EXCEPT ON A SINGLE RESIDENCE LOT WHERE A 30 FOOT

3. THICKNESS = NOT LESS THAN SIX (6) INCHES.

4. WIDTH = TWELVE (12) FOOT MINIMUM, BUT NOT LESS THAN THE FULL WIDTH AT POINTS WHERE INGRESS OR EGRESS OCCUR. TWENTY-FOUR (24) FEET IF SINGLE ENTRANCE TO SITE.


5. FILTER CLOTH - WILL BE PLACED OVER THE ENTIRE AREA PRIOR TO PLACING OF STONE.

6. SURFACE WATER - ALL SURFACE WATER FLOWING OR DIVERTED TOWARD CONSTRUCTION ENTRANCES SHALL BE PIPED ACROSS THE ENTRANCE. IF PIPING IS IMPRACTICAL, A MOUNTABLE BERM WITH 5:1

7. MAINTENANCE - THE ENTRANCE SHALL BE MAINTAINED IN A CONDITION WHICH WILL PREVENT TRACKING OR FLOWING OF SEDIMENT ONTO PUBLIC RIGHTS-OF-WAY. ALL SEDIMENT SPILLED, DROPPED, WASHED OR TRACKED ONTO PUBLIC RIGHTS-OF-WAY MUST BE REMOVED IMMEDIATELY.

8. WHEN WASHING IS REQUIRED, IT SHALL BE DONE ON AN AREA STABILIZED WITH STONE AND WHICH DRAINS INTO AN APPROVED SEDIMENT TRAPPING DEVICE.

9. PERIODIC INSPECTION AND NEEDED MAINTENANCE SHALL BE PROVIDED AFTER EACH RAIN.

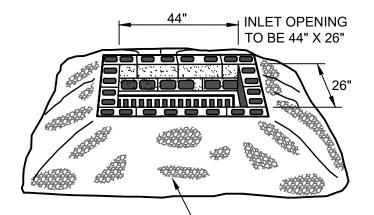

USE D.O.T. #57 WASHED STONE

-1/2" WIRE MESH GRAVEL TO BE NO COURSE THAN 3" FROM TOP OF BLOCK _PLACE AT LEAST ONE BLOCK ON ITS SIDE IN EACH BOTTOM ROW FOR DRAINAGE FLOOD OVERFLOW PLACE 2 COURSES OF BLOCK AROUND INLET

CONSTRUCTION SPECIFICATIONS

- 1. LAY CONCRETE BLOCKS ON FIRM, SMOOTH FOUNDATION EXCAUATED 3" BELOW STORM DRAIN TOP, PLACE BLOCKS AGAINST DRAIN INLET FOR LATERAL SUPPORT.
- 2. PLACE AT LEAST ONE CONCRETE BLOCK ON ITS SIDE IN EACH BOTTOM ROW OF BLOCKS.
- WITHIN 3" OF TOP OF BLOCK
- CONCRETE DRAIN INLET SHOULD BE FILLED WITH 3" FLOWS OVER BLOCKS INTO DRAIN.

TOWN OF CHESTER 3. PLACE WIRE MESH WITH 1/2" OPENINGS OVER ALL BLOCK PLANNING BOARD APPROVAL OPENINGS USED FOR DRAINAGE. 4. USE D.O.T. #57 WASHED STONE TO REDUCE FLOW RATE BUT ALLOW DRAINAGE, PLACE STONE ON 2:1 SLOPE TO 5. ANY SOIL LEFT EXPOSED BETWEEN THE BLOCK AND DIAMETER STONE TO PREVENT WASHING WHEN WATER CATCH BASIN INLET PROTECTION DETAIL SCALE: NONE S-9 REVISIONS **4 SOUTH STREET** JOHN D. FULLER, P.E., P.C. PORT JERVIS, NY 12771 DATE APPROVED (845) 856-1536 08/10/22 SITE PLAN FOR 11/23/22 Auto TRADE TRANS CORPORATION 02/15/23 173 BLACK MEADOW ROAD SECTION 6 BLOCK 1 LOT 106 03/29/23 TOWN OF CHESTER, NY DWG TITLE EROSION & SEDIMENTATION DWG NO. S-9 CONTROL PLAN DETAILS JOHN D. FULLER REG. NO. 077703 SCALE AS NOTED JOB NO. 1713.003

	S-9					
				REV	DESCRIPTION	
			DO	0	FOR APPROVAL	
			DO	1	REVISED PER TOWN COMMENT	
		UNAUTHORIZED ALTERATION OR ADDITIONS TO A PLAN BEARING	DO	2	REVISED PER TOWN COMMENT	
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	REMAINING SHEETS.					

CONSTRUCTION SEQUENCE

STAGE 1 (SITE PREPARATION)

- 1. SCHEDULE ON-SITE PRE-CONSTRUCTION MEETING WITH ENGINEER, CONTRACTOR, LANDOWNER, AND TOWNSHIP AT LEAST ONE WEEK PRIOR TO THE START OF CONSTRUCTION.
- 2. INSTALL CONSTRUCTION ENTRANCE AND PERIMETER SILT FENCE.
- 3. CONSTRUCT SEDIMENT INFILTRATION BASINS AS SHOWN ON THE PLAN. EROSION CONTROLS MUST BE CONSTRUCTED, STABILIZED, AND FUNCTIONAL BEFORE NEW SITE DISTURBANCE BEGINS.
- 4. CLEAR AND GRUB SITE. STRIP TOPSOIL AND STOCKPILE AS SHOWN ON THE EROSION AND SEDIMENTATION CONTROL PLAN AND STABILIZE IN ACCORDANCE WITH THE SEEDING AND MULCHING SPECIFICATIONS.
- 5. INITIATE EARTH MOVING ACTIVITIES FOR SITE DEVELOPMENT. UNSUITABLE MATERIAL IS TO BE REMOVED FROM THE PROJECT SITE. CONTRACTOR SHALL BE SOLELY RESPONSIBLE FOR ALL EROSION AND SEDIMENTATION CONTROL MEASURE AT ANY OFF-SITE SPOIL AREAS. PLACE AND COMPACT MATERIAL IN AREAS OF FILL TO OBTAIN NECESSARY GRADES.
- 6. ROUGH GRADE SITE, STABILIZE AND SEED EXCESS STOCKPILE MATERIAL AS SHOWN ON THE EROSION AND SEDIMENTATION CONTROL PLAN SHEET. INSTALL SILT FENCE AROUND THE STOCKPILE IMMEDIATELY AFTER THE SOIL IS STOCKPILED.
- 7. THE SITE GRADING ACTIVITIES SHALL BE INITIATED AND PROCEED IN SUCH A MANNER AS TO DIRECT ALL STORM WATER FROM DISTURBED AREAS TO THE SEDIMENT CONTROL STRUCTURES.
- 8. STABILIZE ALL GRASS AREAS IN ACCORDANCE WITH THE SEEDING AND MULCHING SPECIFICATIONS.

STAGE 2 (CONSTRUCTION)

- 1. INITIATE CONSTRUCTION OF BUILDING FOUNDATION AND SUPER STRUCTURE.
- 2. INSTALL WASTEWATER AND WATER SUPPLY SYSTEMS INCLUDING PIPING AND TRENCHING AS SHOWN ON THE SITE PLAN.
- 3. ROUGH GRADE SITE, WORKING GRADE TOWARDS "ROUGH" FINAL GRADE ELEVATIONS OF PARKING LOT.
- 4. PLACE AND COMPACT SUBBASE IN AREAS TO BE PAVED AND PLACE THEGRAVEL / ITEM #4 COURSE AS SOON AS IT IS PRACTICAL.
- 5. CLEAN OUT & RESEED AND RE-STABILIZE INFILTRATION BASINS WHERE NECESSARY
- 6. RESEED, RE-MULCH AND RE-STABILIZE WHERE NECESSARY.

FERTILIZER 10-20-10

7. REMOVE SILT FENCING ONLY AFTER ENTIRE SITE HAS BEEN STABILIZED, VEGETATED AREAS SHALL BE CONSIDERED PERMANENTLY STABILIZED WHEN A UNIFORM 70% VEGETATIVE COVER OF EROSION RESISTANT PERENNIAL SPECIFIED HAS BEEN ACHIEVED, OR THE DISTURBED AREA IS COVERED WITH AN ACCEPTABLE BMP WHICH PERMANENTLY MINIMIZE ACCELERATED EROSION AND SEDIMENTATION. UNTIL SUCH TIME AS THIS STANDARD IS ACHIEVED, INTERIM STABILIZATION MEASURES AND TEMPORARY EROSION AND SEDIMENT CONTROL BMPS THAT ARE USED TO TREAT PROJECT RUNOFF MAY NOT BE REMOVED. DURING PERIODS OF DROUGHT, IRRIGATION SHOULD BE UTILIZED UNTIL STABILIZATION HAS OCCURRED.


SEEDING AND MULCHING SPECIFICATIONS

TEMPORARY STABILIZATION:						
	TYPE	RATE				
SEED	ANNUAL RYE GRASS	1 LB/1,000 SQ FT				
MULCH	HAY	3.0 TONS/ACRE				
LIME	AGRICULTURAL GRADE LIMESTONE	1.0 TONS/ACRE				
FERTILIZER	10-20-10	50 LBS./ACRE				
PERMANENT	STABILIZATION:					
	TYPE	RATE				
SEED	PERENNIAL RYE GRASS (20%) REDTOP (50%) ORCHARD GRASS (30%)	0.45 LBS/1,000 SQ FT 0.35 LBS/1,000 SQ FT 1.4 LBS/1,000 SQ FT				
MULCH	HAY	3.0 TONS/ACRE				
LIME	AGRICULTURAL GRADE LIMESTONE	6.0 TONS/ACRE				

1,000 LBS./ACRE

GEOTEXTILE (FILTER FABRIC)

S-9

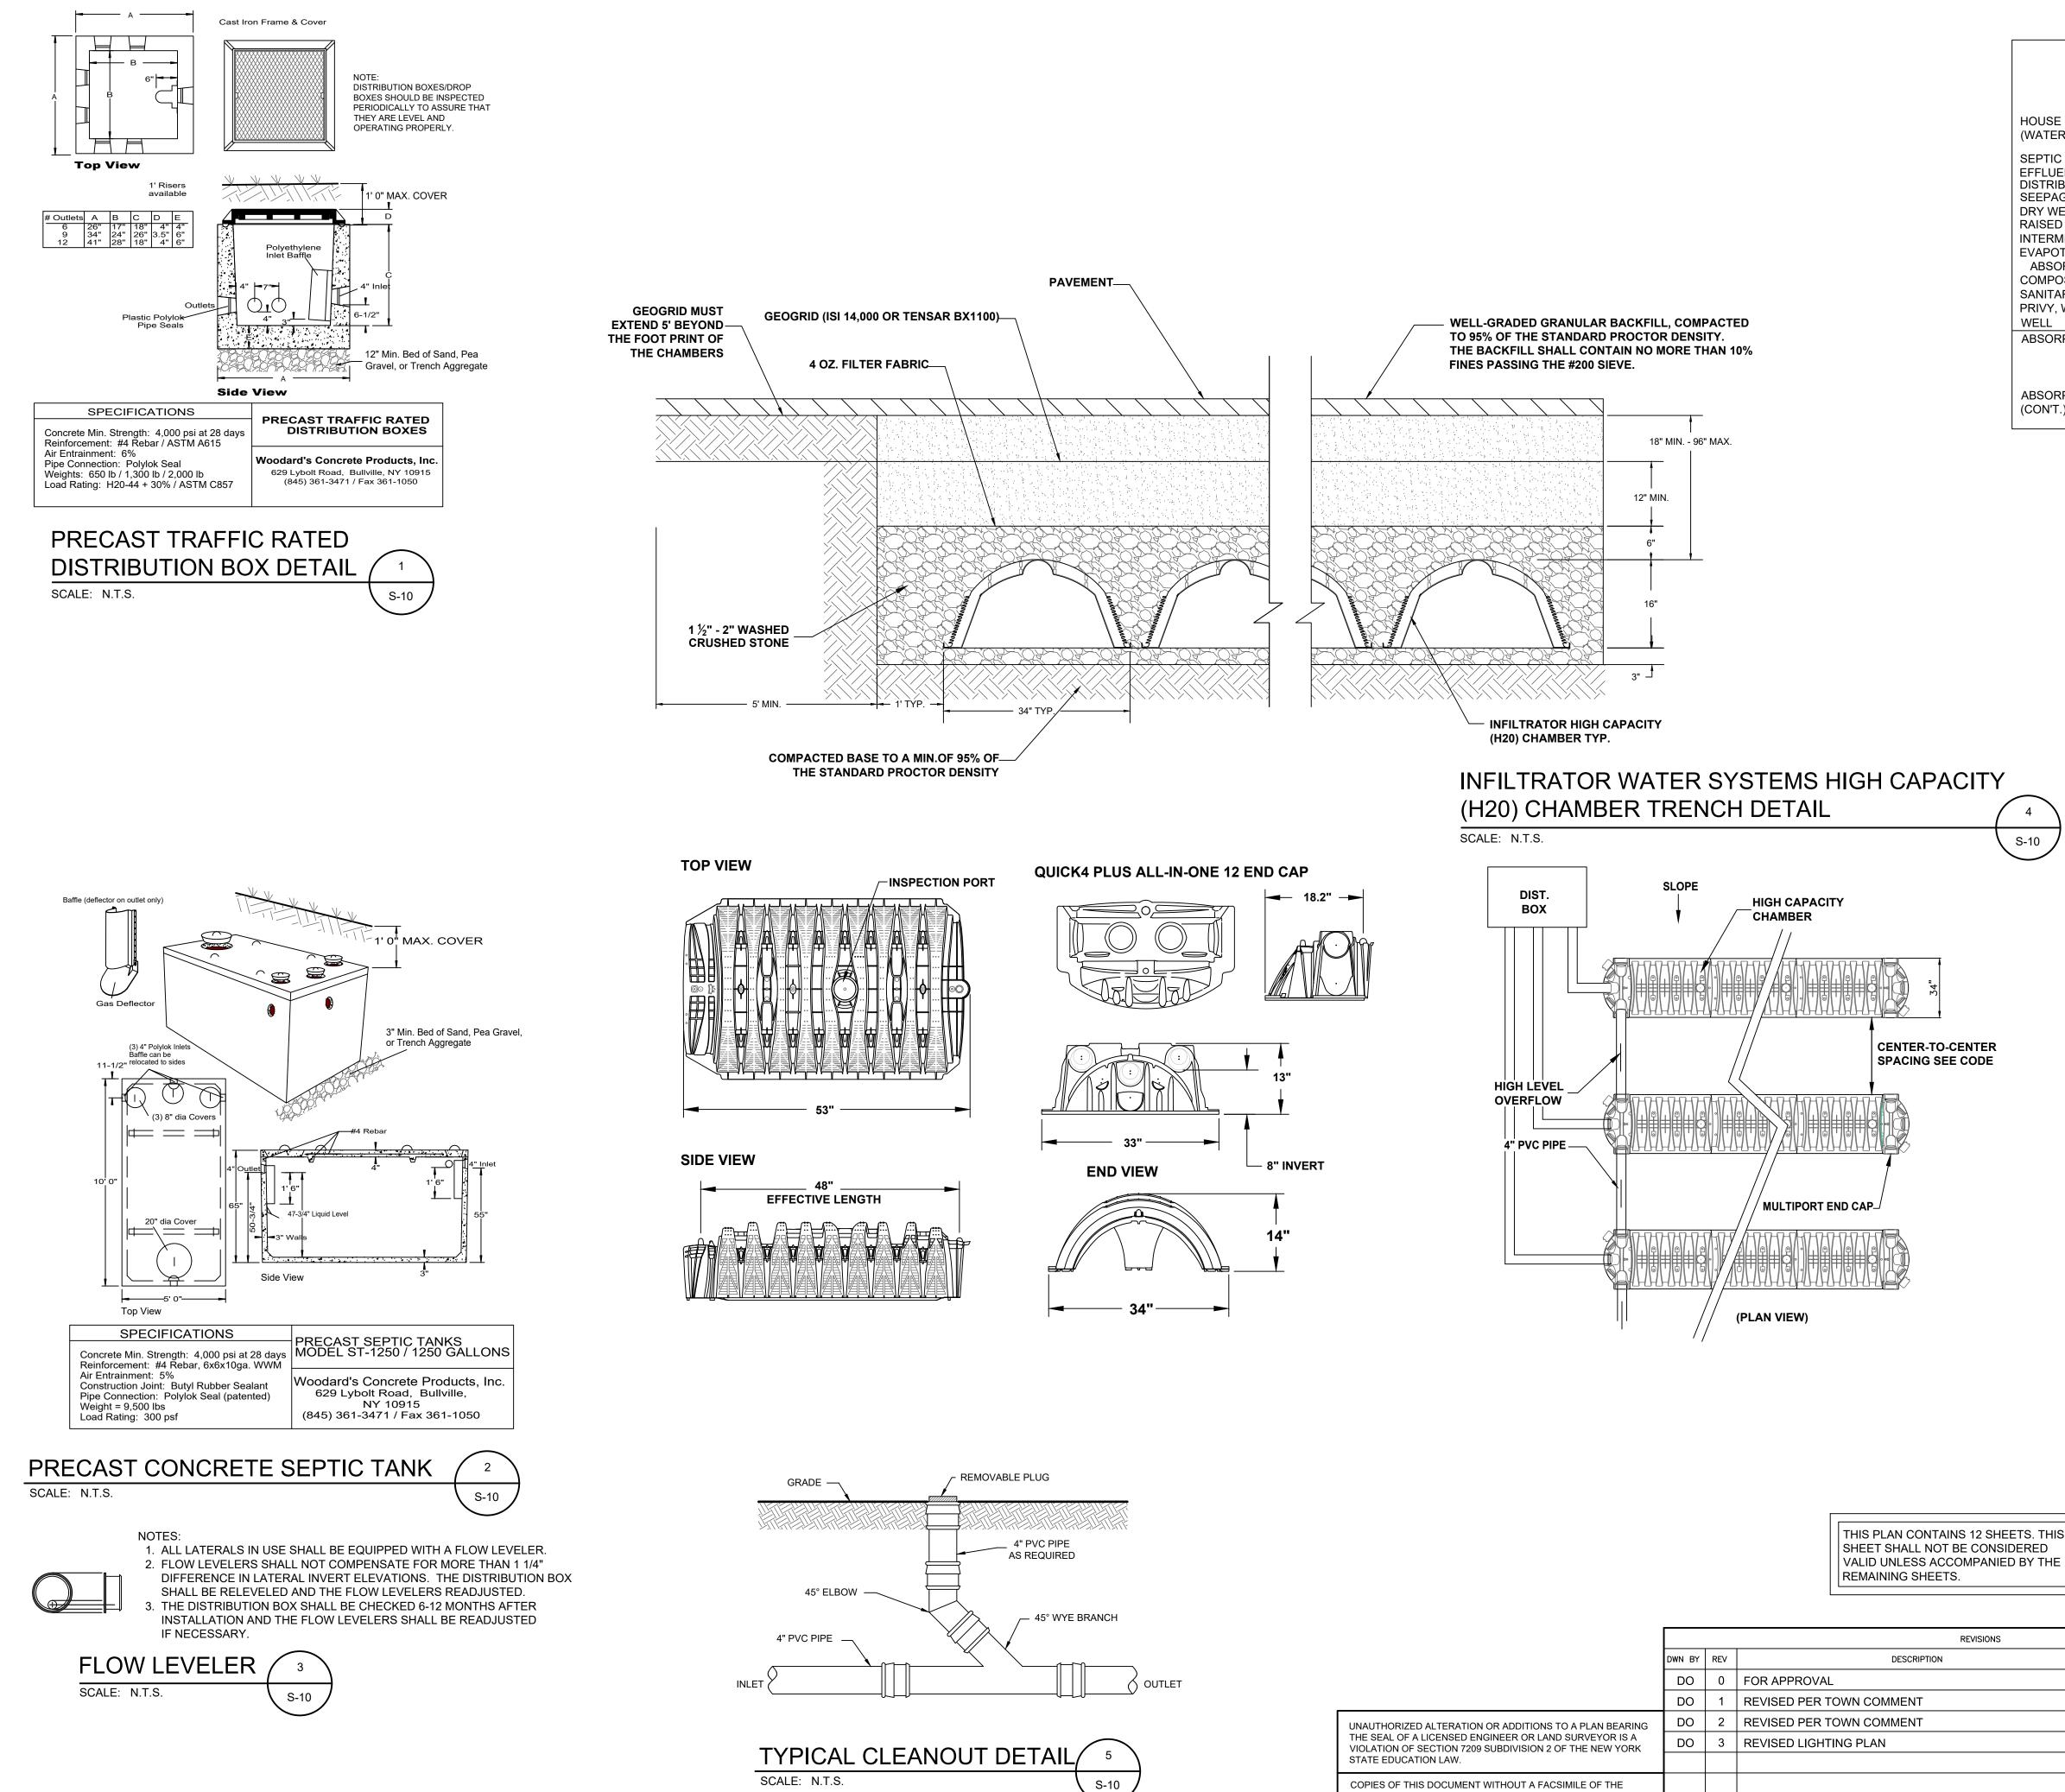

45° WYE BRANCH				REMAINING SHEETS.		
		REVIS				
		DWN BY	REV	DESCRIPTION		
		DO	0	FOR APPROVAL		
		DO	1	REVISED PER TOWN COMMENT		
OUT DETAIL 5 S-10	UNAUTHORIZED ALTERATION OR ADDITIONS TO A PLAN BEARING THE SEAL OF A LICENSED ENGINEER OR LAND SURVEYOR IS A VIOLATION OF SECTION 7209 SUBDIVISION 2 OF THE NEW YORK	DO	2	REVISED PER TOWN COMMENT		
		DO	3	REVISED LIGHTING PLAN		
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MINIMUM SEPARATION DISTANCE (FEET) FROM

		TO STREAM, L	AKE,					
		WATERCOUR	SE,		DRAINAGE			
	WELL (f) OR	WETLAND		PROPER	TY DITCH			
	SUCTION LIN	NE OR WET PONE) (b) DWELLING) LINE	(b) (g)			
			() =	-	() (0)			
HOUSE SEWER	25' IF C.I. OR PVC	25	3'	10'				
	W/ O-RING JOINT	S,						
(WATERTIGHT JOINTS)	50' OTHERWISE							
SEPTIC TANK	50'	50'	10'	10'	10'			
EFFLUENT LINE TO DIST. B	3OX 50'	50'	10'	10'	10'			
DISTRIBUTION BOX	100'	100'	20'	10'	50'			
SEEPAGE PIT	150' (a)	100'	20'	10'	50'			
DRY WELL (ROOF AND FOO	DTING) 50'	25'	20'	10'	50'			
RAISED OR MOUND SYSTE		100'	20'	10'	50'			
INTERMITTEN SAND FILTER	() 100 (u)	100'	20'	10'	50'			
EVAPOTRANSPIRATION	() 100 (u)	50'	20'	10'	50'			
ABSORPTION SYSTEM (c	100' (a)	50	20	10	50			
COMPOSTER	50'	50'	20'	10'	10'			
SANITARY PRIVY PIT	100'	50'	20'	10	20'	SUBDIVI	ISION	
PRIVY, WATERTIGHT VAUL		50'	20'	10'	10'	BOUND	ARY	
WELL	50		20	10	10	501		
	4001/->	25'	201	10'	50'	50'	TO INTERMI	
ABSORPTION FIELD	100'(a)	100'	20'	10	50			
				9	OLID CURTAI		STREAM,	
0	CULVERT OR STOR		TOP OF		ROOF OR FO	,	WELL,CUL	
	SEWER (GASKETED	CURTAIN	EMBANKMEN				STORM SE	
ABSORPTION FIELD	TIGHT PIPE)	DRAIN			IPES, SNOW S		(NON-GASKET	
(CON'T.)	,		TEEP SLOPE (10N3)	EASEME	IN I	OR CATCH	BASIN
	35'	15'	25'		10'		50'	

(a) WHEN SEWAGE TREATMENT SYSTEMS ARE LOCATED IN COARSE GRAVEL OR UPGRADE AND IN THE GENERAL PATH OF DRAINAGE TO A WELL, THE CLOSEST PART OF THE TREATMENT SYSTEM SHALL BE AT LEAST 200' AWAY FROM THE WELL.

(b) MEAN HIGH WATER MARK

(c) FOR ALL SYSTEMS INVOLVING THE PLACEMENT OF FILL MATERIAL, SEPARATION DISTANCES ARE MEASURED FROM THE TOE OF SLOPE OF THE FILL.

(d) ANY WATER SERVICE LINE UNDER PRESSURE (i.e., PUBLIC WATER SUPPLY MAIN, HOUSEHOLD SERVICE LINE, WELL TO HOUSEHOLD SERVICE LINE) LOCATED WITHIN TEN FEET OF ANY ABSORPTION FIELD, SEEPAGE PIT OR SANITARY PRIVY SHALL BE INSTALLED INSIDE A LARGER DIAMETER WATER MAIN TO PROTECT THE POTABLE WATER SUPPLY.

(e) ANY WATER SERVICE LINE UNDER PRESSURE (i.e., PUBLIC WATER SUPPLY MAIN, HOUSEHOLD SERVICE LINE, WELL TO HOUSEHOLD SERVICE LINE) CROSSING A SEWER SHALL BE INSTALLED WITH ONE FULL LENGTH OF WATER MAIN CENTERED ABOVE THE SEWER SO BOTH WATER CONNECTING JOINTS ARE AS FAR AS POSSIBLE FROM THE SEWER. SECTION 8.6 OF THE GLUMRB RECOMMENDED STANDARDS FOR WATER WORKS, SHALL BE FOLLOWED FOR SEPARATION OF WATER MAINS, SANITARY SEWERS AND STORM SEWERS.

(f) THE MINIMUM SEPARATION DISTANCE BETWEEN A SEPTIC TANK AND A COMMUNITY TYPE PUBLIC WATER SUPPLY WELL SHOULD BE 100'. DISTRIBUTION BOXES AND ABSORPTION FACILITIES (e.g., ABSORPTION TRENCHES/BEDS, SEEPAGE PITS, RAISED SYSTEMS, MOUND SYSTEMS, ETC.) SHOULD BE LOCATED AT LEAST 200' FROM COMMUNITY TYPE PUBLIC WATER SUPPLY WELLS. (g) RECOMMENDED SEPARATION DISTANCES.

MINIMUM SEPTIC TANK CAPACITIES

MINIMUM SEPTIC TANK CAPACITY = 1.5 TIMES THE DESIGN FLOW RATE 1.5 X 315 GPD = 472.5 GALLONS 1,250 GALLONS PROVIDED


SEPTIC CALCULATIONS

DESIGN FLOW = 21 EMPLOYEES @ 15 GPD PER EMPLOYEE = 315 GPD PERCOLATION RATE: 45-60 MIN.

TRENCH LENGTH REQUIRED = 315 GPD/0.45/2 = 350 L.F.

6 ROWS PROVIDED @ 60 = 360 L.F.

		TOWN OF CHESTER PLANNING BOARD APPROVAL				
SHEETS. THIS NSIDERED NIED BY THE	New York 811 dig					
DNS DATE APPROVED	Λ	JOHN D. FULLER, P.	E., P.C. 4 SOUTH PORT JE (845) 8	H STREET RVIS, NY 12771		
08/10/22	DA I //A		· · ·	50-1550		
11/23/22	11 Kila.	SITE PLAN FOR TRADE TRANS CORPORATION				
02/15/23	Julm. 6. 7 W	173 BLACK MEADOW ROAD				
03/29/23			BLOCK 1 LOT 106 F CHESTER, NY			
	V	DWG TITLE		DWG NO.		
	JOHN D. FULLER	SEPTIC DETAILS				
	REG. NO. 077703	SCALE AS NOTED JOB NO. 1713.003				

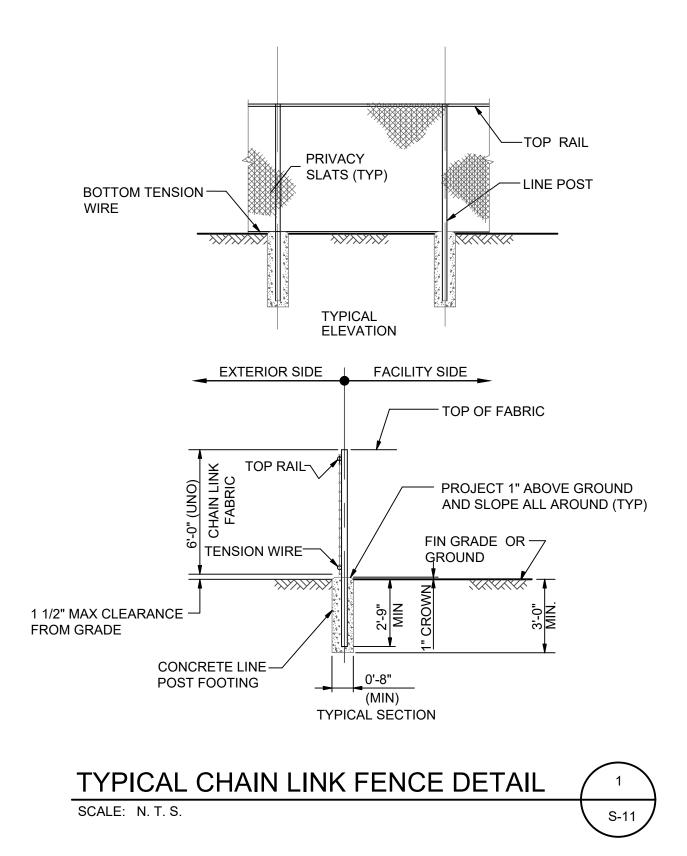


TYPICAL WOVEN WIRE FENCING NOTES


(INSTALL FENCING PER ASTM F-567)

- 1. LINE POST: 2-3/8"Ø SCHEDULE 40 PIPE PER ASTM-F1083.
- 2. TOP RAIL & BRACE RAIL: 1 1/4"Ø SCHEDULE 40 PIPE PER ASTM-F1083.
- FABRIC: 11 GA. CORE WIRE SIZE 2" MESH, CONFORMING TO ASTM-A392 CLASS 1.
- 4. TIE WIRE: MINIMUM 11 GA GALVANIZED STEEL INSTALL A SINGLE WRAP TIE WIRE AT POSTS AND RAILS AT MAX. 24" INTERVALS. INSTALL HOG RINGS ON TENSION WIRE AT 24" INTERVALS.
- 5. TENSION WIRE: 7 GA. GALVANIZED STEEL.
- 6. HEIGHT = 4' VERTICAL.
- 7. LINE POSTS ARE 5' O.C. NOMINAL AND NOT TO EXCEED 10'
- 8. ALL WORK SHALL CONFORM WITH THE PROJECT SPECIFICATIONS.

THIS PLAN CONTAINS 12 SHEETS. THIS SHEET SHALL NOT BE CONSIDERED VALID UNLESS ACCOMPANIED BY THE REMAINING SHEETS.

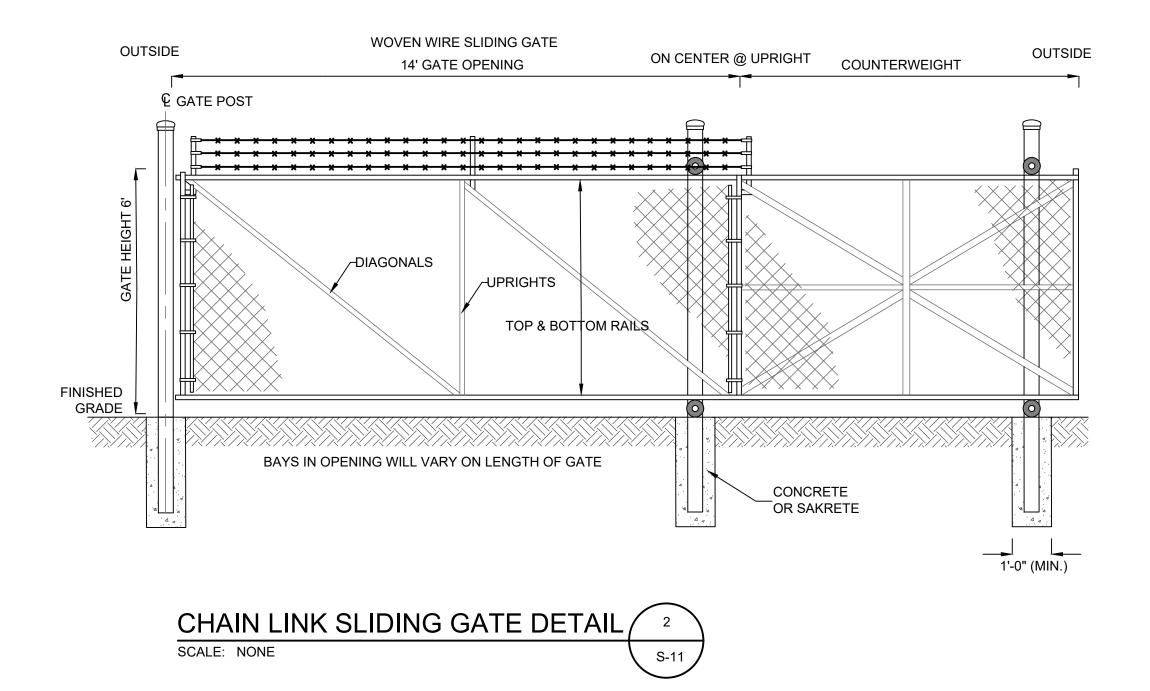

		REVIS				
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2" FINE ASPHALT TOP COAT OVER _

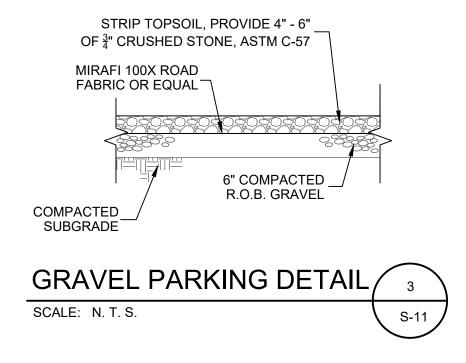3" ASPHALT BINDER PAVING BASE


8" COMPACTED R.O.B. GRAVEL

SITE PAVING DETAIL

OR ITEM NO. 4

1

SCALE: N. T. S.

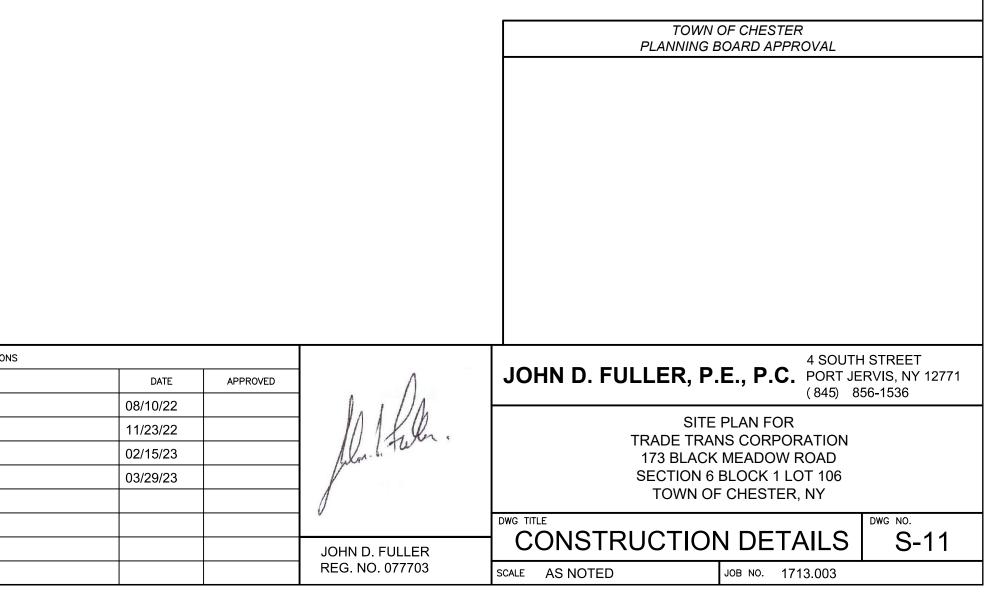

S-11