

33 Airport Center Drive, Suite 202 New Windsor, NY 12553 Milford, PA 18337 (845) 567-3100 (570) 296-2765

before you dig ____

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SYNERGY


TOWN OF CHESTER ORANGE COUNTY, NEW YORK


SITE PLAN

| EVISIONS | | | | | | | |
|----------|------------------------------|-----------|--|--|--|--|--|
| O. | DESCRIPTION | DATE | | | | | |
| ١. | AS PER THE BOARD'S COMMENTS | 2/16/2022 | | | | | |
| 2. | AS PER THE BOARD'S COMMENTS | 3/16/2022 | | | | | |
| 3. | AS PER THE BOARD'S COMMENTS | 4/12/2022 | | | | | |
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| SSUE | SUED DATE: 21 December, 2021 | | | | | | |


DESIGN BY: JV DRAWN BY: JRJ CHECKED BY: JV **REVIEWED BY:** MWW

SHEET NO.

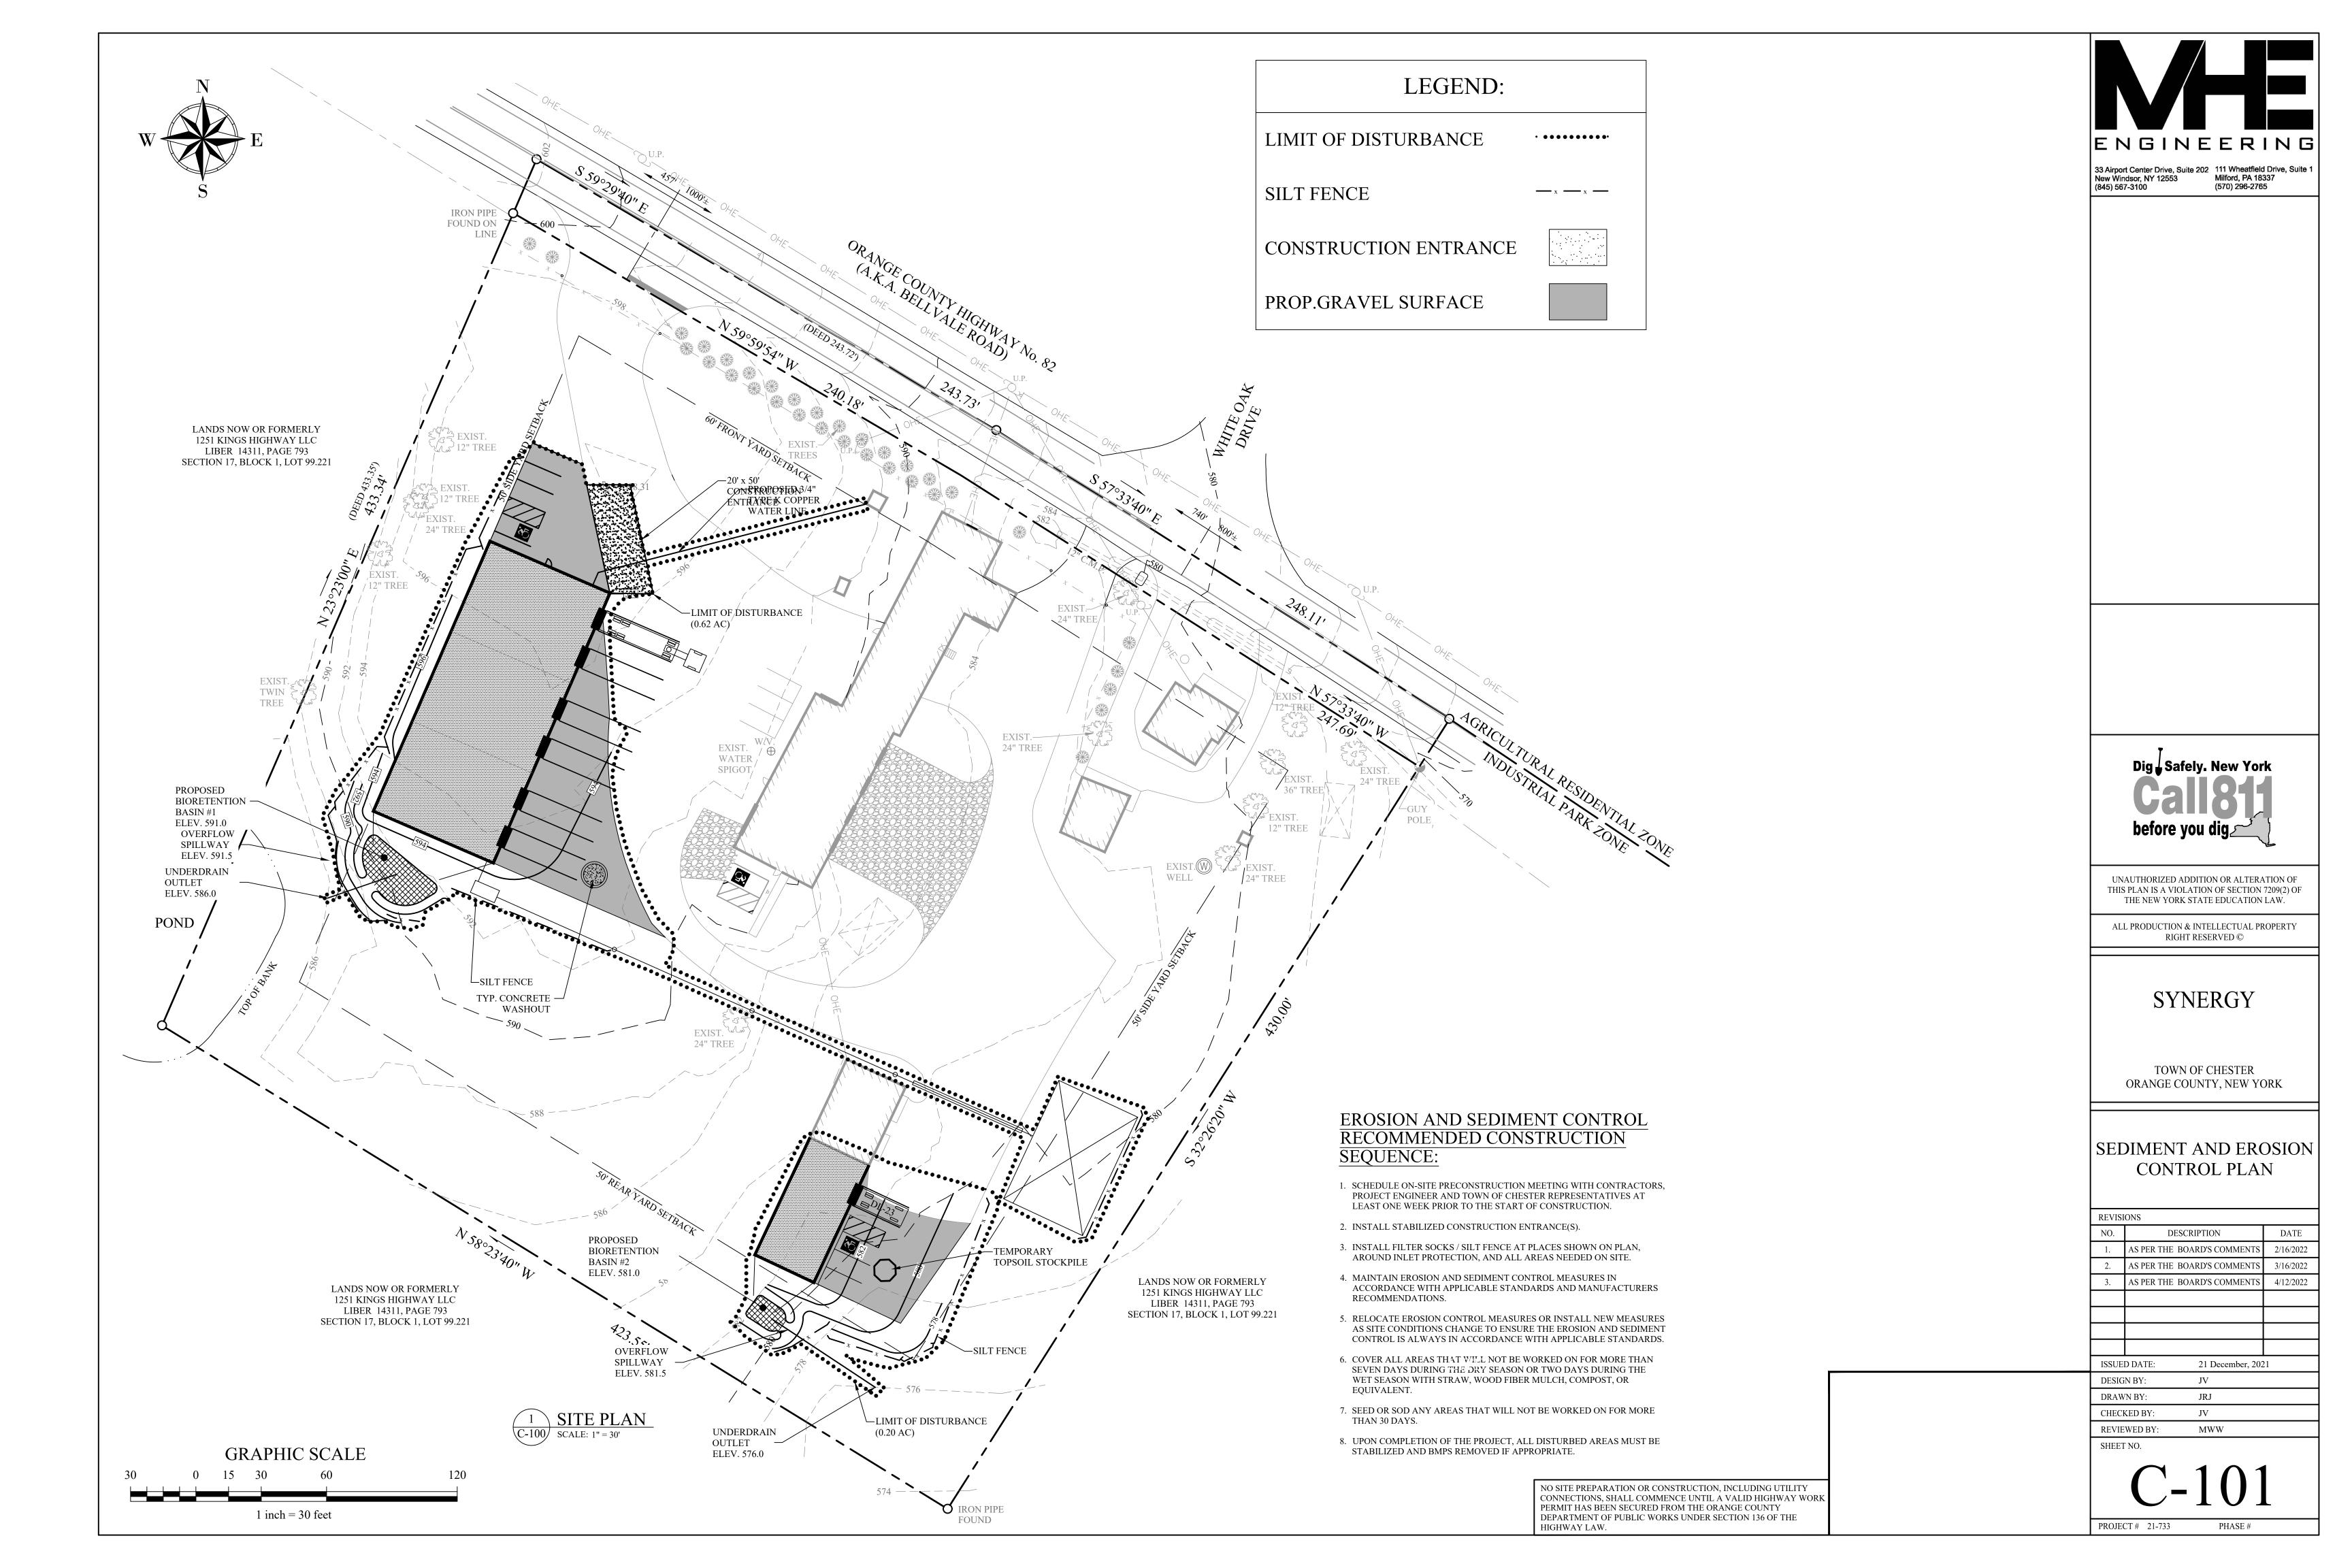

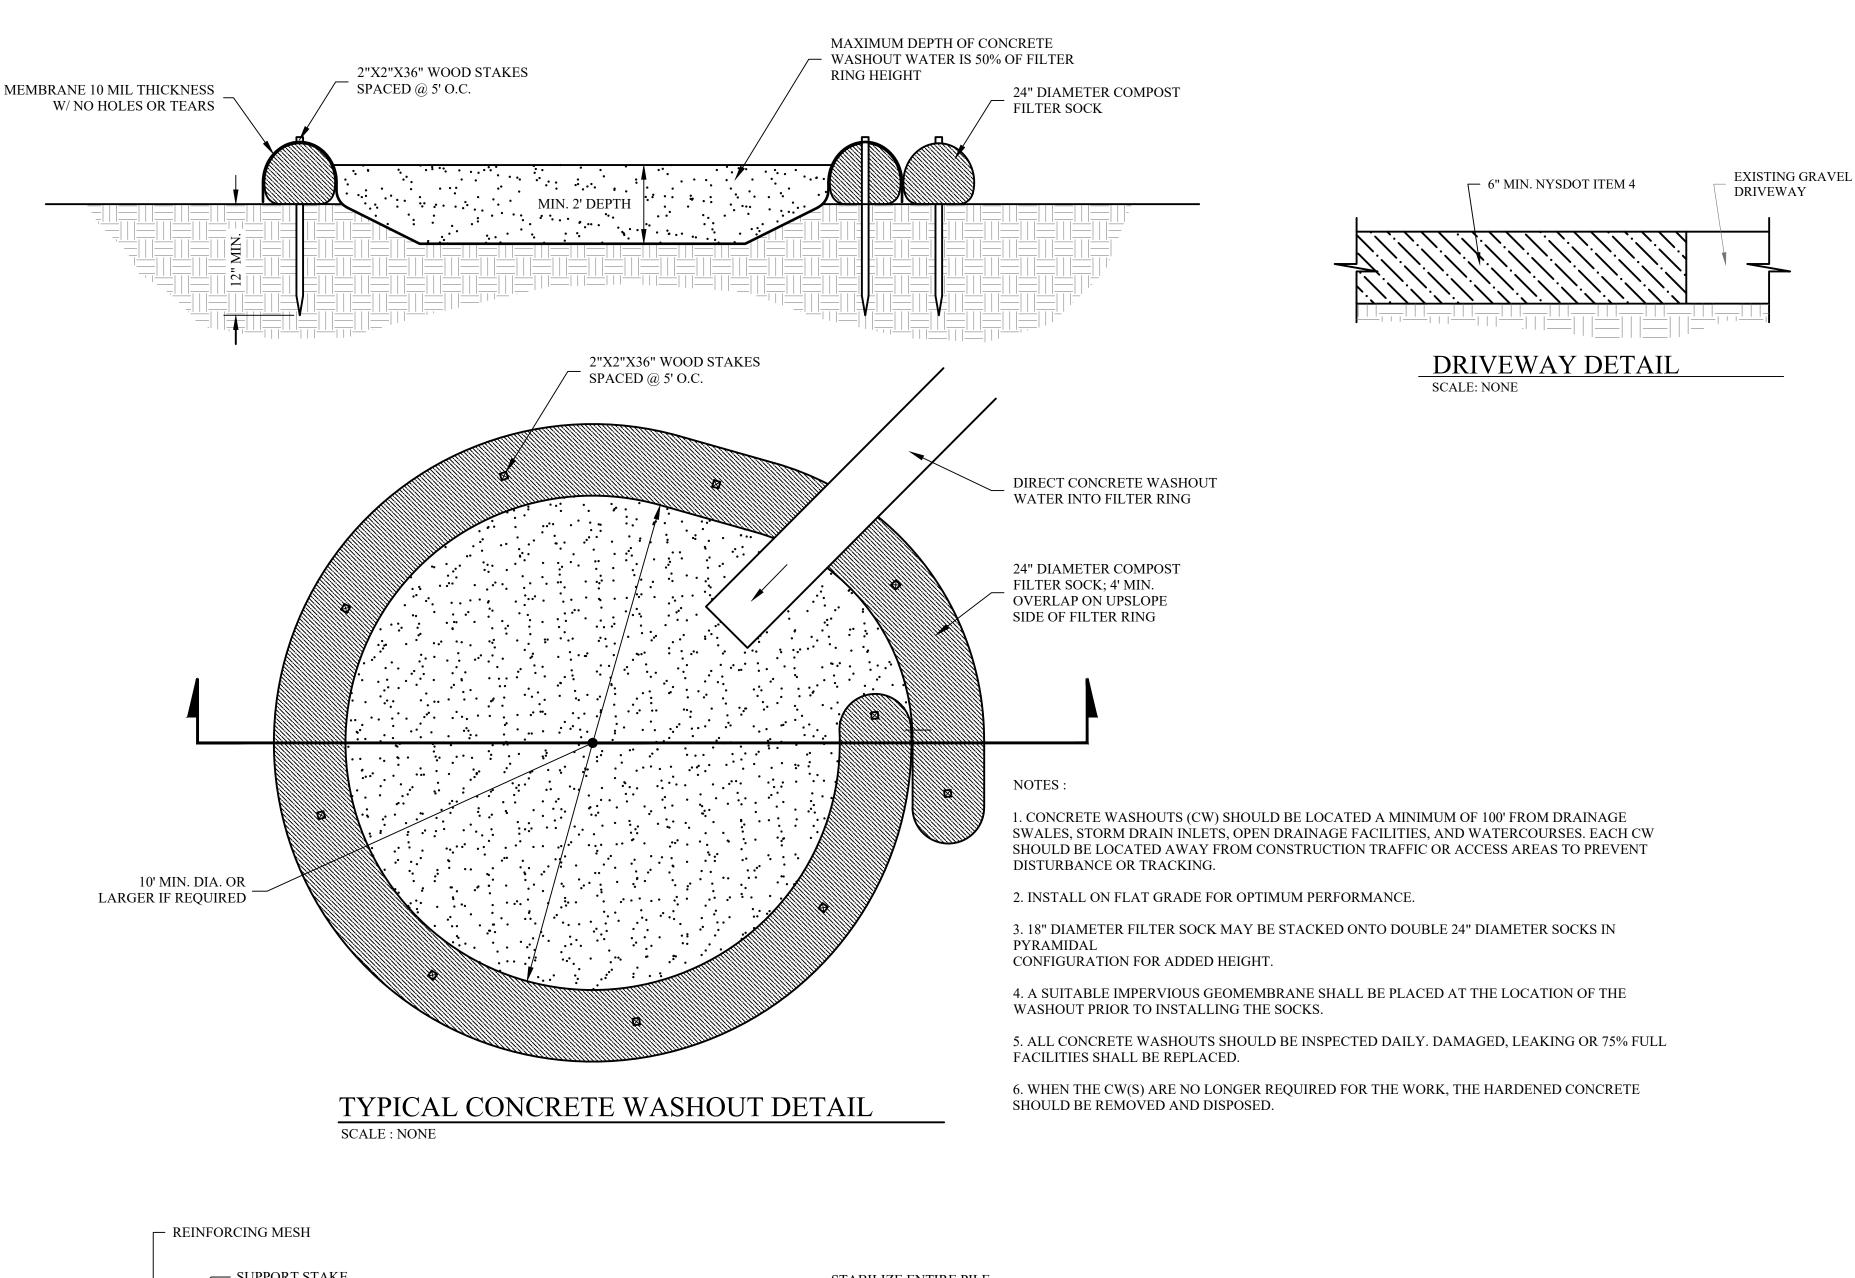

TYPICAL WATER SERVICE DETAIL

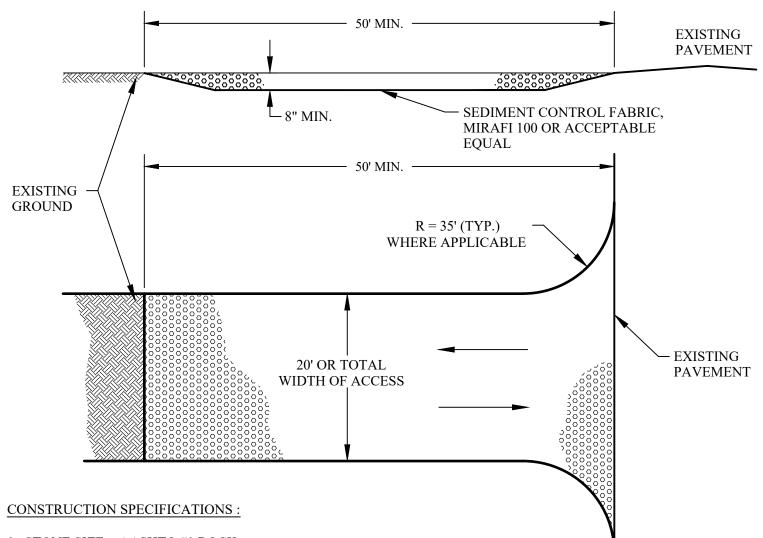

1. STONE SIZE = AASHTO #1 ROCK.

2. LENGTH = NOT LESS THAN FIFTY (50) FEET.

3. THICKNESS = NOT LESS THAN EIGHT (8) INCHES.

4. WIDTH = TWENTY (20) FOOT MINIMUM, BUT NOT LESS THAN THE FULL WIDTH AT POINTS WHERE INGRESS OR EGRESS OCCUR. TWELVE (12) FEET IF SINGLE ENTRANCE TO SITE.

5. GEOTEXTILE - WILL BE PLACED OVER THE ENTIRE AREA PRIOR TO PLACING OF STONE.

6. SURFACE WATER - ALL SURFACE WATER FLOWING OR DIVERTED TOWARD CONSTRUCTION ENTRANCES SHALL BE PIPED ACROSS THE ENTRANCE. IF PIPING IS IMPRACTICAL, A MOUNTABLE BERM WITH 5:1 SLOPES WILL BE PERMITTED.


7. MAINTENANCE - THE ENTRANCE SHALL BE MAINTAINED IN A CONDITION WHICH WILL PREVENT TRACKING OR FLOWING OF SEDIMENT ONTO PUBLIC RIGHTS-OF-WAY. ALL SEDIMENT SPILLED, DROPPED, WASHED OR TRACKED ONTO PUBLIC RIGHT-OF-WAY MUST BE REMOVED IMMEDIATELY.

8. WHEN WASHING IS REQUIRED, IT SHALL BE DONE ON AN AREA STABILIZED WITH STONE AND WHICH DRAINS INTO AN APPROVED SEDIMENT TRAPPING DEVICE.

9. PERIODIC INSPECTION AND NEEDED MAINTENANCE SHALL BE PROVIDED AFTER EACH RAIN.

10. TEMPORARY CONSTRUCTION ENTRANCES, EXITS AND TEMPORARY ACCESS SHALL BE SUBJECT TO THE APPROVAL OF THE APPROPRIATE AUTHORITIES.

STABILIZED CONSTRUCTION ENTRANCE DETAILS SCALE: NONE

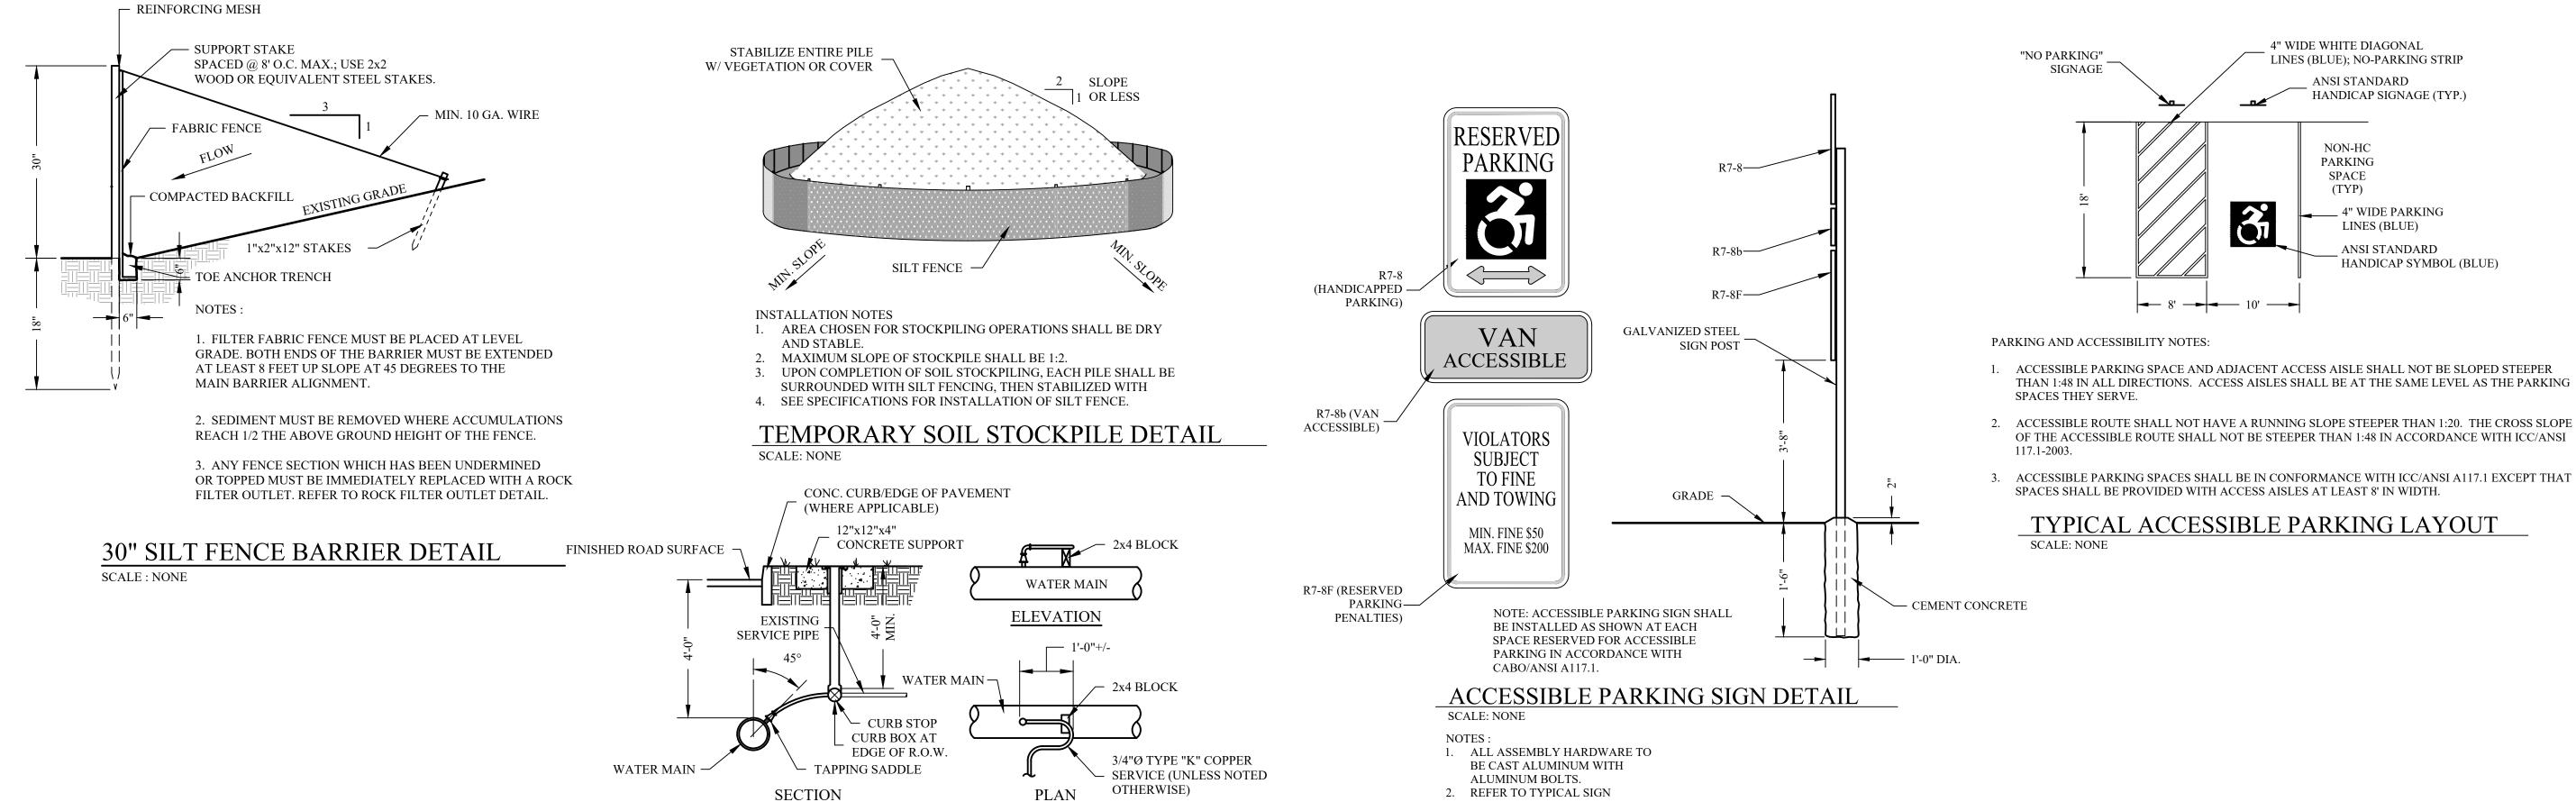

MOUNTING DETAIL FOR SIGN

CONNECTION DETAILS.



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SYNERGY

TOWN OF CHESTER ORANGE COUNTY, NEW YORK

TYPICAL DETAILS

| REVISIONS | | | | | | | |
|-----------|-----------------------------|-----------|--|--|--|--|--|
| NO. | DESCRIPTION | DATE | | | | | |
| 1. | AS PER THE BOARD'S COMMENTS | 2/16/2022 | | | | | |
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ISSUED DATE: 21 December, 2021 **DESIGN BY:** JV DRAWN BY: JRJ CHECKED BY JV

MWW

REVIEWED BY: SHEET NO.

PROJECT # 21-733

NO SITE PREPARATION OR CONSTRUCTION, INCLUDING UTILITY CONNECTIONS, SHALL COMMENCE UNTIL A VALID HIGHWAY WORK PERMIT HAS BEEN SECURED FROM THE ORANGE COUNTY DEPARTMENT OF PUBLIC WORKS UNDER SECTION 136 OF THE HIGHWAY LAW.

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*1.0 *0.8 *1.5 *2.7 *3.5 *3.4 *

3.7 + 4.6 + 3.5 + 2.0 + 1.1 = 0.6 + 0.4 = 0.2 = 0.

*4.8 *3.9 *3.1 *2.5 *2.3 *2.2 *1.8 *1.7 *2.1 *1.2 *1.7 *1.8 *2.1 *2.4 *2.0 $0.0 \ 0.0 \ 0.0 \ 0.0 \ 0.0 \ 0.0 \ 0.0 \ 0.0 \ 0.0 \ 0.0 \ 0.0$ $0.0 \ 0.0 \ 0.0 \ 0.0 \ 0.0 \ 0.0 \ 0.0 \ 0.0 \ 0.0 \ 0.0 \ 0.0$ WP @ 15 $0.0 \ 0.0 \ 0.0 \ 0.0 \ 0.0 \ 0.0 \ 0.0 \ 0.0 \ 0.0 \ 0.0 \ 0.0 \ 0.0$ 3.0 *2.3 *2.1 *2.2 / 2.6 *3.1 *3.3 *3.6 *4.3 3 1.8 1/.7 2.3 3.1 3.6 3.7SHED 4.4 / 3/8 WP @ 1: 1.3/1.4 2.3 3.1 4.0 3.9 3.8 2.7 2.5 $0.0 \quad 0.0 \quad 0.0$ 2.3 *1.3 *0.9 *1.2 *2.3 *3.8 *4.6 *3.8 *3.0 * 9 *1.5 *0.9 *1.2 *2.0 *3.3 *4.9 6.4 $0.0 \quad 0.0 \quad 0.0$ WP @ 15' 1.0 1.0 1.6 2EXIS3.3 74 6 4.2

 $0.0 \quad 0.0 \quad 0.0$ +0.0 +0.0 +0.0 +0.0 +0.0 +0.0 +0.1 +0.3

WP @ 15' $0.0 \quad 0.0 \quad 0.0$

 $0.0 \quad 0.0 \quad 0.0$ 1251 KINGS HIGHWAY LLC SECTION 17, BLOCK 1, LOT 99.221

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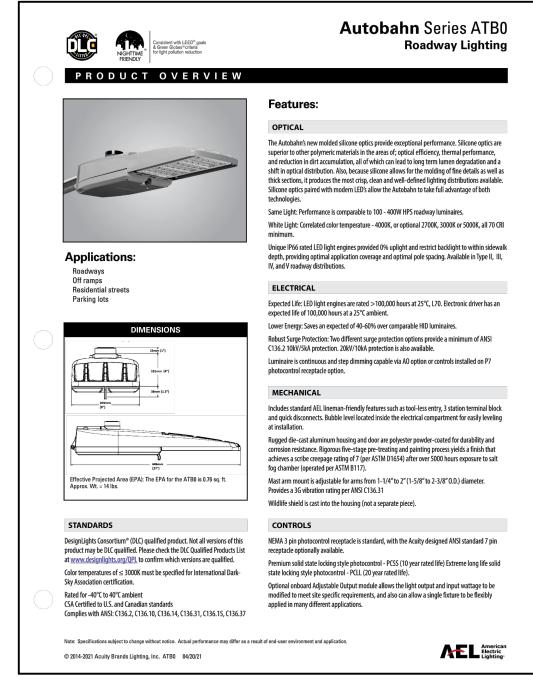
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effectiveness for use in a particular application. In no event will Acuity Brands be responsible for any loss

to consult with a professional engineering advisor to determine whether the proposed design meets the applicable project requirements for lighting system performance, code compliance, safety, suitability and

resulting from any use of any information contained in this lighting submittal.

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HOLOPHANE HLWPC2 Mechanical

• Heavy grade A360 cast aluminum (aluminum with <1%

• Field adjustable output (A0) copper)

Button style photocontrol (PP)

Setzerior parts are protected by a zinc-infused Super Durable

Glic thermoset powder coat finish that provides superior

mounting Jow (8-15') (MASL) and high (15-30') (MASH) Wallpack® Full Cutoff LED mounting heights Certification and Standards Rated for -40°C (-40°F) minimum ambient 1 Projected LED Lumen Main
 1 In Projected LED Lumen Main
 1 In Projected LED Lumen Main
 1 Projected LED Lumen Main
 1 In Projected LED Lumen Main
 1 In Projected LED Lumen Main
 1 Projected LE Warranty
5-year limited warranty. Complete warranty terms located at Optional > 90 CRI (3000K, 4000K and 5000K CCT)
 Internally mounted emergency battery backup for operation in an ambient temperature ranging from -20°C(-4°F) to 30°C (86°F), available with P10 thru P40 performance packages, onn CEC compliant
 All surge protection meets ANSI/IEEE (62.21.2 10kV/10kA)
 Standards urge protection is 10kV/10kA per ANSI (136.2
 Optional surge protection is 10kV/5kk per ANSI (136.2
 Optional surge protection is 10kV/5kk per ANSI (136.2 Deptical
Light engine housing is IP66 rated
Acrylic optical system
Type V: E (entry), M (medium), R (rectangle) & W (wide)
Asymmetric Sacuity Brands | Holophane | 3825 Columbus Rd., Granville, OH 43023 | Phone: 866-HOLOPHANE | www.holophane.com


1. Readings shown are based on a total LLF as shown at grade. Data references the extrapolated performance projections in a 25c ambient based on 10,000 hrrs of LED testing (per IESNA LM-80-08 and projected per IESNA TM-21-11) 2. Please refer to the "luminaire locations" table for mounting 3- Product information can be obtained at www.Holophane.com or through your local agency.

4. Please note this analysis does not comply with minimal IESNA levels for parking and pedestrian safety. Acuity Brands will not be liable for any safety issues that may arise from installation of this

| | | | Location | | | |
|-----|-------|--------|----------|-------|-------|-------------|
| No. | Label | X | Y | Z | MH | Orientation |
| 1 | WP | 311.37 | 124.98 | 15.00 | 15.00 | 115.71 |
| 2 | WP | 335.47 | 176.09 | 15.00 | 15.00 | 115.71 |
| 3 | WP | 329.77 | 201.93 | 15.00 | 15.00 | 24.62 |
| 4 | A | 423.76 | 275.13 | 20.00 | 20.00 | 244.55 |
| 5 | WP | 280.58 | 295.93 | 15.00 | 15.00 | 208.48 |
| 6 | WP | 309.41 | 302.50 | 15.00 | 15.00 | 118.47 |
| 7 | WP | 266.45 | 309.04 | 15.00 | 15.00 | 295.77 |
| 8 | WP | 126.27 | 309.61 | 15.00 | 15.00 | 202.29 |
| 9 | WP | 167.11 | 325.86 | 15.00 | 15.00 | 112.97 |
| 10 | WP | 335.48 | 351.49 | 15.00 | 15.00 | 118.47 |
| 11 | WP | 294.20 | 361.46 | 15.00 | 15.00 | 295.77 |
| 12 | WP | 362.11 | 395.90 | 15.00 | 15.00 | 118.47 |
| 13 | WP | 197.20 | 396.13 | 15.00 | 15.00 | 112.97 |
| 14 | A | 431.67 | 401.18 | 20.00 | 20.00 | 294.94 |
| 15 | WP | 335.88 | 413.27 | 15.00 | 15.00 | 295.77 |
| 16 | WP | 179.63 | 434.56 | 15.00 | 15.00 | 24.62 |
| 17 | A | 282.69 | 435.00 | 20.00 | 20.00 | 210.00 |
| 18 | A | 236.27 | 487.64 | 20.00 | 20.00 | 255.52 |

| Statistics | | | | | | |
|------------------------------------|--------|--------|--------|--------|---------|---------|
| Description | Symbol | Avg | Max | Min | Max/Min | Avg/Min |
| BARN AREA SUMMARY | Ж | 2.8 fc | 6.3 fc | 0.4 fc | 15.8:1 | 7.0:1 |
| EXISTING WAREHOUSE PARKING SUMMARY | Ж | 3.2 fc | 6.5 fc | 0.5 fc | 13.0:1 | 6.4:1 |
| GRAVCEL AREA SUMMARY | Ж | 1.5 fc | 5.5 fc | 0.2 fc | 27.5:1 | 7.5:1 |
| OPEN PAVED AREA SUMMARY | Ж | 2.3 fc | 5.9 fc | 0.3 fc | 19.7:1 | 7.7:1 |
| PROPOSED WAREHOUSE PARKING SUMMARY | ж | 3.1 fc | 5.6 fc | 1.0 fc | 5.6:1 | 3.1:1 |
| SPILL SUMMARY | + | 0.4 fc | 6.5 fc | 0.0 fc | N/A | N/A |

| Schedule | | | | | | | | | | | |
|----------|-------|----------|-------------------------------|---------------------------|-------------------------------------------------------------------------------------------------------|-----------------|--------------------|----------------------|----------------------|---------|----------------------------------------------|
| Symbol | Label | Quantity | Manufacturer | Catalog Number | Description | Number Lamps | Lumens Per Lamp | Light Loss Factor | Total Lamp Lumens | Wattage | Distribution |
| | A | 4 | American Electric Lighting | ATB0 P205 R4 4K | Autobahn Small P205 Package Roadway Type IV 4000K/5000K | 1 | 13829 | 0.91 | 13829 | 102 | TYPE IV, MEDIUM, BUG RATING: B2 - U0 - G3 |
| | WP | 14 | Holophane | HLWPC2 P50 40K XX TFTM | Wallpack Full Cutoff LED, LED Performance Package P20, 4000 series CCT, Voltage, Forward Throw Medium | 1 | 12125 | 0.9 | 12125 | 115 | TYPE IV, SHORT, BUG RATING: B2 - U0 - G2 |

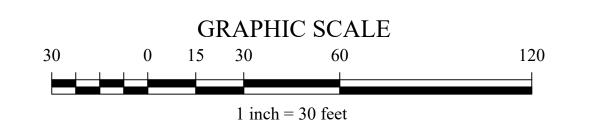

| $\overline{1}$ | SITE LIGHTING PLAN |
|---------------------------|--------------------|
| $\backslash \text{C-103}$ | SCALE: 1" = 30' |

NO SITE PREPARATION OR CONSTRUCTION, INCLUDING UTILITY CONNECTIONS, SHALL COMMENCE UNTIL A VALID HIGHWAY WORK PERMIT HAS BEEN SECURED FROM THE ORANGE COUNTY DEPARTMENT OF PUBLIC WORKS UNDER SECTION 136 OF THE HIGHWAY LAW.

before you dig <u></u>

33 Airport Center Drive, Suite 202 111 Wheatfield Drive, Suite 1

New Windsor, NY 12553

(845) 567-3100

Milford, PA 18337

(570) 296-2765

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SYNERGY

TOWN OF CHESTER ORANGE COUNTY, NEW YORK

SITE LIGHTING **PLAN**

| REVISIONS | | | | | | | |
|--------------------------------|-----------------------------|-----------|--|--|--|--|--|
| NO. | DESCRIPTION | DATE | | | | | |
| 1. | AS PER THE BOARD'S COMMENTS | 2/16/2022 | | | | | |
| 2. | AS PER THE BOARD'S COMMENTS | 3/16/2022 | | | | | |
| 3. | AS PER THE BOARD'S COMMENTS | 4/12/2022 | | | | | |
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| | | | | | | | |
| ISSUED DATE: 21 December, 2021 | | | | | | | |
| DESIG | N BY: JV | | | | | | |

DRAWN BY: JV CHECKED BY: REVIEWED BY: MWW SHEET NO.

PROJECT # 21-733